

DRAWING No	DRAWING DESCRIPTION	SHEET No.
A0002	FRESNO TO BAKERSFIELD – STATIONS DRAWINGS – INDEX OF SHEETS	1 OF 3
A0003	FRESNO TO BAKERSFIELD – STATIONS DRAWINGS – GENERAL ABBREVIATIONS	2 OF 3
A0004	FRESNO TO BAKERSFIELD – STATIONS DRAWINGS – GENERAL ABBREVIATIONS	3 OF 3

#### **FRESNO STATION - MARIPOSA ALTERNATIVE**

DRAWING No	DRAWING DESCRIPTION	SHEET No.
A1101	FRESNO SUBSECTION – ALIGNMENT F1 - FRESNO STATION - MARIPOSA ALTERNATIVE - GROUND LEVEL SITE PLAN	1 OF 15
A1102	FRESNO SUBSECTION – ALIGNMENT F1 - FRESNO STATION - MARIPOSA ALTERNATIVE - ROOF LEVEL SITE PLAN	2 OF 15
A1110	FRESNO SUBSECTION – ALIGNMENT F1 - FRESNO STATION - MARIPOSA ALTERNATIVE - GROUND LEVEL/PLATFORM KEY PLAN	3 OF 15
A1111	FRESNO SUBSECTION – ALIGNMENT F1- FRESNO STATION - MARIPOSA ALTERNATIVE - EAST ENTRY FLOOR PLAN	4 OF 15
A1112	FRESNO SUBSECTION – ALIGNMENT F1 - FRESNO STATION - MARIPOSA ALTERNATIVE - WEST ENTRY/PLATFORM FLOOR PLAN	5 OF 15
A1120	FRESNO SUBSECTION – ALIGNMENT F1 - FRESNO STATION - MARIPOSA ALTERNATIVE - CONCOURSE KEY PLAN	6 OF 15
A1121	FRESNO SUBSECTION – ALIGNMENT F1 - FRESNO STATION - MARIPOSA ALTERNATIVE - EAST CONCOURSE FLOOR PLAN	7 OF 15
A1122	FRESNO SUBSECTION – ALIGNMENT F1 - FRESNO STATION - MARIPOSA ALTERNATIVE - WEST CONCOURSE FLOOR PLAN	8 OF 15
A1130	FRESNO SUBSECTION – ALIGNMENT F1 - FRESNO STATION - MARIPOSA ALTERNATIVE - ROOF KEY PLAN	9 OF 15
A3101	FRESNO SUBSECTION – ALIGNMENT F1 - FRESNO STATION - MARIPOSA ALTERNATIVE - BUILDING SECTIONS	10 OF 15
A3102	FRESNO SUBSECTION – ALIGNMENT F1 - FRESNO STATION - MARIPOSA ALTERNATIVE - BUILDING SECTIONS	11 OF 15
A6101	FRESNO SUBSECTION – ALIGNMENT F1 - FRESNO STATION - MARIPOSA ALTERNATIVE - ROOM SCHEDULE	12 OF 15
A9101	FRESNO SUBSECTION – ALIGNMENT F1 - FRESNO STATION - MARIPOSA ALTERNATIVE - AXONOMETRIC VIEWS	13 OF 15
A9102	FRESNO SUBSECTION – ALIGNMENT F1 - FRESNO STATION - MARIPOSA ALTERNATIVE - 3D ELEVATION VIEWS	14 OF 15
A9103	FRESNO SUBSECTION – ALIGNMENT F1 - FRESNO STATION - MARIPOSA ALTERNATIVE - 3D ELEVATION VIEWS	15 OF 15

#### **FRESNO STATION - KERN ALTERNATIVE**

DRAWING No	DRAWING DESCRIPTION	SHEET No.
A1201	FRESNO SUBSECTION – ALIGNMENT F1 - FRESNO STATION - KERN ALTERNATIVE - GROUND LEVEL SITE PLAN	1 OF 15
A1202	FRESNO SUBSECTION – ALIGNMENT F1 - FRESNO STATION - KERN ALTERNATIVE - ROOF LEVEL SITE PLAN	2 OF 15
A1210	FRESNO SUBSECTION – ALIGNMENT F1 - FRESNO STATION - KERN ALTERNATIVE - GROUND LEVEL/PLATFORM KEY PLAN	3 OF 15
A1211	FRESNO SUBSECTION – ALIGNMENT F1- FRESNO STATION - KERN ALTERNATIVE - EAST ENTRY FLOOR PLAN	4 OF 15
A1212	FRESNO SUBSECTION – ALIGNMENT F1 - FRESNO STATION - KERN ALTERNATIVE - WEST ENTRY/PLATFORM FLOOR PLAN	5 OF 15
A1220	FRESNO SUBSECTION – ALIGNMENT F1 - FRESNO STATION - KERN ALTERNATIVE - CONCOURSE KEY PLAN	6 OF 15
A1221	FRESNO SUBSECTION – ALIGNMENT F1 - FRESNO STATION - KERN ALTERNATIVE - EAST CONCOURSE FLOOR PLAN	7 OF 15
A1222	FRESNO SUBSECTION – ALIGNMENT F1 - FRESNO STATION - KERN ALTERNATIVE - WEST CONCOURSE FLOOR PLAN	8 OF 15
A1230	FRESNO SUBSECTION – ALIGNMENT F1 - FRESNO STATION - KERN ALTERNATIVE - ROOF KEY PLAN	9 OF 15
A3201	FRESNO SUBSECTION – ALIGNMENT F1 - FRESNO STATION - KERN ALTERNATIVE - BUILDING SECTIONS	10 OF 15
A3202	FRESNO SUBSECTION – ALIGNMENT F1 - FRESNO STATION - KERN ALTERNATIVE - BUILDING SECTIONS	11 OF 15
A6201	FRESNO SUBSECTION – ALIGNMENT F1 - FRESNO STATION - KERN ALTERNATIVE - ROOM SCHEDULE	12 OF 15
A9201	FRESNO SUBSECTION – ALIGNMENT F1 - FRESNO STATION - KERN ALTERNATIVE - AXONOMETRIC VIEWS	13 OF 15
A9202	FRESNO SUBSECTION – ALIGNMENT F1 - FRESNO STATION - KERN ALTERNATIVE - 3D ELEVATION VIEWS	14 OF 15
A9203	FRESNO SUBSECTION – ALIGNMENT F1 - FRESNO STATION - KERN ALTERNATIVE - 3D ELEVATION VIEWS	15 OF 15

#### KINGS / TULARE REGIONAL STATION - EAST ALTERNATIVE

DRAWING No	DRAWING DESCRIPTION	SHEET No.
A1301	HANFORD SUBSECTION – ALIGNMENT H - KINGS / TULARE REGIONAL STATION - EAST ALTERNATIVE – ROOF LEVEL SITE PLAN	1 OF 13
A1302	HANFORD SUBSECTION – ALIGNMENT H – KINGS / TULARE REGIONAL STATION - EAST ALTERNATIVE – GROUND LEVEL SITE PLAN	2 OF 13
A1310	HANFORD SUBSECTION – ALIGNMENT H – KINGS / TULARE REGIONAL STATION - EAST ALTERNATIVE – CONCOURSE KEY PLAN	3 OF 13
A1311	HANFORD SUBSECTION – ALIGNMENT H – KINGS / TULARE REGIONAL STATION - EAST ALTERNATIVE – CONCOURSE FLOOR PLAN	4 OF 13
A1320	HANFORD SUBSECTION – ALIGNMENT H – KINGS / TULARE REGIONAL STATION - EAST ALTERNATIVE – PLATFORM KEY PLAN	5 OF 13
A1321	HANFORD SUBSECTION – ALIGNMENT H – KINGS / TULARE REGIONAL STATION - EAST ALTERNATIVE – PLATFORM FLOOR PLAN	6 OF 13
A1330	HANFORD SUBSECTION – ALIGNMENT H – KINGS / TULARE REGIONAL STATION - EAST ALTERNATIVE – ROOF KEY PLAN	7 OF 13
A3301	HANFORD SUBSECTION – ALIGNMENT H – KINGS / TULARE REGIONAL STATION - EAST ALTERNATIVE – BUILDING SECTIONS	8 OF 13
A3302	HANFORD SUBSECTION – ALIGNMENT H – KINGS / TULARE REGIONAL STATION - EAST ALTERNATIVE – BUILDING SECTIONS	9 OF 13
A6301	HANFORD SUBSECTION – ALIGNMENT H – KINGS / TULARE REGIONAL STATION - EAST ALTERNATIVE – ROOM SCHEDULE	10 OF 13
A9301	HANFORD SUBSECTION – ALIGNMENT H – KINGS / TULARE REGIONAL STATION - EAST ALTERNATIVE – AXONOMETRIC VIEWS	11 OF 13
A9302	HANFORD SUBSECTION – ALIGNMENT H – KINGS / TULARE REGIONAL STATION - EAST ALTERNATIVE – 3D ELEVATION VIEWS	12 OF 13
A9303	HANFORD SUBSECTION – ALIGNMENT H – KINGS / TULARE REGIONAL STATION - EAST ALTERNATIVE – 3D ELEVATION VIEWS	13 OF 13

# KINGS / TULARE REGIONAL STATION - WEST ALTERNATIVE (AT GRADE OPTION)

DRAWING		SHEET
No	DRAWING DESCRIPTION	No.
A1601	HANFORD WEST BYPASS SUBSECTION – ALIGNMENT HW - KINGS / TULARE REGIONAL STATION - WEST ALTERNATIVE (AT GRADE OPTION) STATION AREA CONTEXT PLAN	1 OF 14
A1602	HANFORD WEST BYPASS SUBSECTION – ALIGNMENT HW - KINGS / TULARE REGIONAL STATION - WEST ALTERNATIVE (AT GRADE OPTION) STATION SITE PLAN	2 OF 14
A1611	HANFORD WEST BYPASS SUBSECTION – ALIGNMENT HW - KINGS / TULARE REGIONAL STATION - WEST ALTERNATIVE (AT GRADE OPTION) CONCOURSE KEY PLAN	3 OF 14
A1612	HANFORD WEST BYPASS SUBSECTION – ALIGNMENT HW - KINGS / TULARE REGIONAL STATION - WEST ALTERNATIVE (AT GRADE OPTION) CONCOURSE DETAIL PLAN	4 OF 14
A1620	HANFORD WEST BYPASS SUBSECTION – ALIGNMENT HW - KINGS / TULARE REGIONAL STATION - WEST ALTERNATIVE (AT GRADE OPTION) PLATFORM KEY PLAN	5 OF 14
A1621	HANFORD WEST BYPASS SUBSECTION – ALIGNMENT HW - KINGS / TULARE REGIONAL STATION - WEST ALTERNATIVE (AT GRADE OPTION) PLATFORM FLOOR PLAN	6 OF 14
A1630	HANFORD WEST BYPASS SUBSECTION – ALIGNMENT HW - KINGS / TULARE REGIONAL STATION - WEST ALTERNATIVE (AT GRADE OPTION) ROOF KEY PLAN	7 OF 14
A1641	HANFORD WEST BYPASS SUBSECTION - ALIGNMENT HW - KINGS / TULARE REGIONAL STATION - WEST ALTERNATIVE (AT GRADE OPTION) UNDERCROSSING LEVEL FLOOR PLAN	8 OF 14
A3601	HANFORD WEST BYPASS SUBSECTION – ALIGNMENT HW - KINGS / TULARE REGIONAL STATION - WEST ALTERNATIVE (AT GRADE OPTION) BUILDING SECTIONS	9 OF 14
A6601	HANFORD WEST BYPASS SUBSECTION – ALIGNMENT HW - KINGS / TULARE REGIONAL STATION - WEST ALTERNATIVE (AT GRADE OPTION) ROOM SCHEDULE	10 OF 14
A9601	HANFORD WEST BYPASS SUBSECTION – ALIGNMENT HW - KINGS / TULARE REGIONAL STATION - WEST ALTERNATIVE (AT GRADE OPTION) AERIAL VIEW - CONTEXT	11 OF 14
A9602	HANFORD WEST BYPASS SUBSECTION – ALIGNMENT HW - KINGS / TULARE REGIONAL STATION - WEST ALTERNATIVE (AT GRADE OPTION) ARIAL VIEW - CAMPUS	12 OF 14
A9603	HANFORD WEST BYPASS SUBSECTION - ALIGNMENT HW - KINGS / TULARE REGIONAL STATION - WEST ALTERNATIVE (AT GRADE OPTION) 3D ELEVATION VIEWS	13 OF 14
A9604	HANFORD WEST BYPASS SUBSECTION - ALIGNMENT HW - KINGS / TULARE REGIONAL STATION - WEST ALTERNATIVE (AT GRADE OPTION) 3D ELEVATION VIEWS	14 OF 14

## KINGS / TULARE REGIONAL STATION - WEST ALTERNATIVE (BELOW GRADE OPTION)

DRAWING No	DRAWING DESCRIPTION	SHEET No.
A1701	HANFORD WEST BYPASS SUBSECTION – ALIGNMENT HW - KINGS / TULARE REGIONAL STATION - WEST ALTERNATIVE (BELOW GRADE OPTION) STATION AREA CONTEXT PLAN	1 OF 14
A1702	HANFORD WEST BYPASS SUBSECTION – ALIGNMENT HW - KINGS / TULARE REGIONAL STATION - WEST ALTERNATIVE (BELOW GRADE OPTION) STATION SITE PLAN	2 OF 14
A1710	HANFORD WEST BYPASS SUBSECTION – ALIGNMENT HW - KINGS / TULARE REGIONAL STATION - WEST ALTERNATIVE (BELOW GRADE OPTION) CONCOURSE KEY PLAN	3 OF 14
A1712	HANFORD WEST BYPASS SUBSECTION – ALIGNMENT HW - KINGS / TULARE REGIONAL STATION - WEST ALTERNATIVE (BELOW GRADE OPTION) CONCOURSE DETAIL PLAN	4 OF 14
A1720	HANFORD WEST BYPASS SUBSECTION – ALIGNMENT HW - KINGS / TULARE REGIONAL STATION - WEST ALTERNATIVE (BELOW GRADE OPTION) PLATFORM KEY PLAN	5 OF 14
A1722	HANFORD WEST BYPASS SUBSECTION – ALIGNMENT HW - KINGS / TULARE REGIONAL STATION - WEST ALTERNATIVE (BELOW GRADE OPTION) PLATFORM DETAIL PLAN	6 OF 14
A1730	HANFORD WEST BYPASS SUBSECTION – ALIGNMENT HW - KINGS / TULARE REGIONAL STATION - WEST ALTERNATIVE (BELOW GRADE OPTION) ROOF KEY PLAN	7 OF 14
A3701	HANFORD WEST BYPASS SUBSECTION – ALIGNMENT HW - KINGS / TULARE REGIONAL STATION - WEST ALTERNATIVE (BELOW GRADE OPTION) BUILDING SECTIONS	8 OF 14
A3702	HANFORD WEST BYPASS SUBSECTION – ALIGNMENT HW - KINGS / TULARE REGIONAL STATION - WEST ALTERNATIVE (BELOW GRADE OPTION) BUILDING SECTION	9 OF 14
A6701	HANFORD WEST BYPASS SUBSECTION – ALIGNMENT HW - KINGS / TULARE REGIONAL STATION - WEST ALTERNATIVE (BELOW GRADE OPTION) ROOM SCHEDULE	10 OF 14
A9701	HANFORD WEST BYPASS SUBSECTION - ALIGNMENT HW - KINGS / TULARE REGIONAL STATION - WEST ALTERNATIVE (BELOW GRADE OPTION) AERIAL VIEW - CONTEXT	11 OF 14
A9702	HANFORD WEST BYPASS SUBSECTION – ALIGNMENT HW - KINGS / TULARE REGIONAL STATION - WEST ALTERNATIVE (BELOW GRADE OPTION) AERIAL VIEW - CAMPUS	12 OF 14
A9703	HANFORD WEST BYPASS SUBSECTION - ALIGNMENT HW - KINGS / TULARE REGIONAL STATION - WEST ALTERNATIVE (BELOW GRADE OPTION) 3D ELEVATION VIEWS	13 OF 14
A9704	HANFORD WEST BYPASS SUBSECTION - ALIGNMENT HW - KINGS / TULARE REGIONAL STATION - WEST ALTERNATIVE (BELOW GRADE OPTION) 3D ELEVATION VIEWS	14 OF 14

## **BAKERSFIELD STATION - NORTH ALTERNATIVE**

DRAWING No	DRAWING DESCRIPTION	SHEET No.
A1401	BAKERSFIELD URBAN SUBSECTION – ALIGNMENT B1 – BAKERSFIELD STATION - NORTH ALTERNATIVE - GROUND LEVEL SITE PLAN	1 OF 14
A1402	BAKERSFIELD URBAN SUBSECTION – ALIGNMENT B1 – BAKERSFIELD STATION - NORTH ALTERNATIVE - ROOF LEVEL SITE PLAN	2 OF 14
A1410	BAKERSFIELD URBAN SUBSECTION – ALIGNMENT B1 – BAKERSFIELD STATION - NORTH ALTERNATIVE - CONCOURSE KEY PLAN	3 OF 14
A1411	BAKERSFIELD URBAN SUBSECTION – ALIGNMENT B1 – BAKERSFIELD STATION - NORTH ALTERNATIVE - CONCOURSE FLOOR PLAN	4 OF 14
A1421	BAKERSFIELD URBAN SUBSECTION – ALIGNMENT B1 – BAKERSFIELD STATION - NORTH ALTERNATIVE - PEDESTRIAN OVERCROSSING FLOOR PLAN	5 OF 14
A1430	BAKERSFIELD URBAN SUBSECTION – ALIGNMENT B1 – BAKERSFIELD STATION - NORTH ALTERNATIVE - PLATFORM KEY PLAN	6 OF 14
A1431	BAKERSFIELD URBAN SUBSECTION – ALIGNMENT B1 – BAKERSFIELD STATION - NORTH ALTERNATIVE - PLATFORM FLOOR PLAN	7 OF 14
A1440	BAKERSFIELD URBAN SUBSECTION – ALIGNMENT B1 – BAKERSFIELD STATION - NORTH ALTERNATIVE - ROOF KEY PLAN	8 OF 14
A3401	BAKERSFIELD URBAN SUBSECTION – ALIGNMENT B1 – BAKERSFIELD STATION - NORTH ALTERNATIVE - BUILDING SECTION	9 OF 14
A3402	BAKERSFIELD URBAN SUBSECTION – ALIGNMENT B1 – BAKERSFIELD STATION - NORTH ALTERNATIVE - BUILDING SECTION	10 OF 14
A6401	BAKERSFIELD URBAN SUBSECTION – ALIGNMENT B1 – BAKERSFIELD STATION - NORTH ALTERNATIVE - ROOM SCHEDULE	11 OF 14
A9401	BAKERSFIELD URBAN SUBSECTION – ALIGNMENT B1 – BAKERSFIELD STATION - NORTH ALTERNATIVE - AXONOMETRIC VIEWS	12 OF 14
A9402	BAKERSFIELD URBAN SUBSECTION – ALIGNMENT B1 – BAKERSFIELD STATION - NORTH ALTERNATIVE - 3D ELEVATION VIEWS	13 OF 14
A9403	BAKERSFIELD URBAN SUBSECTION – ALIGNMENT B1 – BAKERSFIELD STATION - NORTH ALTERNATIVE - 3D ELEVATION VIEWS	14 OF 14

## **BAKERSFIELD STATION - SOUTH ALTERNATIVE**

DRAWING No	DRAWING DESCRIPTION	SHEET No.
A1501	BAKERSFIELD URBAN SUBSECTION – ALIGNMENT B2 – BAKERSFIELD STATION - SOUTH ALTERNATIVE - GROUND LEVEL SITE PLAN	1 OF 13
A1502	BAKERSFIELD URBAN SUBSECTION – ALIGNMENT B2 – BAKERSFIELD STATION - SOUTH ALTERNATIVE - ROOF LEVEL SITE PLAN	2 OF 13
A1510	BAKERSFIELD URBAN SUBSECTION – ALIGNMENT B2 – BAKERSFIELD STATION - SOUTH ALTERNATIVE - CONCOURSE KEY PLAN	3 OF 13
A1511	BAKERSFIELD URBAN SUBSECTION – ALIGNMENT B2 – BAKERSFIELD STATION - SOUTH ALTERNATIVE - CONCOURSE FLOOR PLAN	4 OF 13
A1520	BAKERSFIELD URBAN SUBSECTION – ALIGNMENT B2 – BAKERSFIELD STATION - SOUTH ALTERNATIVE - PLATFORM KEY PLAN	5 OF 13
A1521	BAKERSFIELD URBAN SUBSECTION – ALIGNMENT B2 – BAKERSFIELD STATION - SOUTH ALTERNATIVE - PLATFORM FLOOR PLAN	6 OF 13
A1530	BAKERSFIELD URBAN SUBSECTION – ALIGNMENT B2 – BAKERSFIELD STATION - SOUTH ALTERNATIVE - ROOF KEY PLAN	7 OF 13
A3501	BAKERSFIELD URBAN SUBSECTION – ALIGNMENT B2 – BAKERSFIELD STATION - SOUTH ALTERNATIVE - BUILDING SECTION	8 OF 13
A3502	BAKERSFIELD URBAN SUBSECTION – ALIGNMENT B2 – BAKERSFIELD STATION - SOUTH ALTERNATIVE - BUILDING SECTION	9 OF 13
A6501	BAKERSFIELD URBAN SUBSECTION – ALIGNMENT B2 – BAKERSFIELD STATION - SOUTH ALTERNATIVE - ROOM SCHEDULE	10 OF 13
A9501	BAKERSFIELD URBAN SUBSECTION – ALIGNMENT B2 – BAKERSFIELD STATION - SOUTH ALTERNATIVE - AXONOMETRIC VIEWS	11 OF 13
A9502	BAKERSFIELD URBAN SUBSECTION – ALIGNMENT B2 – BAKERSFIELD STATION - SOUTH ALTERNATIVE - 3D ELEVATION VIEWS	12 OF 13
A9503	BAKERSFIELD URBAN SUBSECTION – ALIGNMENT B2 – BAKERSFIELD STATION - SOUTH ALTERNATIVE - 3D ELEVATION VIEWS	13 OF 13

# **BAKERSFIELD STATION - (B3) HYBRID**

DRAWING No	DRAWING DESCRIPTION	SHEET No.
A1801	BAKERSFIELD URBAN SUBSECTION - ALIGNMENT B3 - BAKERSFIELD STATION - (B3) HYBRID - SITE CONTEXT ROOF PLAN	1 OF 15
A1802	BAKERSFIELD URBAN SUBSECTION - ALIGNMENT B3 - BAKERSFIELD STATION - (B3) HYBRID - STATION SITE ROOF PLAN	2 OF 15
A1810	BAKERSFIELD URBAN SUBSECTION - ALIGNMENT B3 - BAKERSFIELD STATION - (B3) HYBRID - CONCOURSE KEY PLAN	3 OF 15
A1811	BAKERSFIELD URBAN SUBSECTION - ALIGNMENT B3 - BAKERSFIELD STATION - (B3) HYBRID - CONCOURSE FLOOR PLAN	4 OF 15
A1812	BAKERSFIELD URBAN SUBSECTION - ALIGNMENT B3 - BAKERSFIELD STATION - (B3) HYBRID - NORTH STATION FLOOR PLANS	5 OF 15
A1830	BAKERSFIELD URBAN SUBSECTION - ALIGNMENT B3 - BAKERSFIELD STATION - (B3) HYBRID - PLATFORM KEY PLAN	6 OF 15
A1831	BAKERSFIELD URBAN SUBSECTION – ALIGNMENT B3 – BAKERSFIELD STATION - (B3) HYBRID - PLATFORM FLOOR PLAN	7 OF 15
A1840	BAKERSFIELD URBAN SUBSECTION - ALIGNMENT B3 - BAKERSFIELD STATION - (B3) HYBRID - ROOF KEY PLAN	8 OF 15
A3801	BAKERSFIELD URBAN SUBSECTION - ALIGNMENT B3 - BAKERSFIELD STATION - (B3) HYBRID - BUILDING SECTIONS	9 OF 15
A3802	BAKERSFIELD URBAN SUBSECTION - ALIGNMENT B3 - BAKERSFIELD STATION - (B3) HYBRID - BUILDING SECTIONS	10 OF 15
A6801	BAKERSFIELD URBAN SUBSECTION - ALIGNMENT B3 - BAKERSFIELD STATION - (B3) HYBRID - ROOM SCHEDULE	11 OF 15
A9801	BAKERSFIELD URBAN SUBSECTION - ALIGNMENT B3 - BAKERSFIELD STATION - (B3) HYBRID - AXONOMETRIC VIEWS	12 OF 15
A9802	BAKERSFIELD URBAN SUBSECTION - ALIGNMENT B3 - BAKERSFIELD STATION - (B3) HYBRID - 3D ELEVATION VIEWS	13 OF 15
A9803	BAKERSFIELD URBAN SUBSECTION - ALIGNMENT B3 - BAKERSFIELD STATION - (B3) HYBRID - 3D ELEVATION VIEWS	14 OF 15
A9804	BAKERSFIELD URBAN SUBSECTION - ALIGNMENT B3 - BAKERSFIELD STATION - (B3) HYBRID - AERIAL VIEW	15 OF 15

						DESIGNED BY E. NAOR	
						DRAWN BY D. BACKMAN	RI
						CHECKED BY F. KING	DES
						IN CHARGE	l c
						E. NAOR	1
REV	DATE	BY	СНК	APP	DESCRIPTION	06/08/12	

RECORD SET 15% DESIGN SUBMISSION -NOT FOR





# CALIFORNIA HIGH-SPEED TRAIN PROJECT FRESNO TO BAKERSFIELD

STATIONS DRAWINGS PLANS, ELEVATIONS AND SECTIONS

INDEX OF SHEETS

HSR 06-0003

DRAWING NO.

A0002

SCALE

SHEET NO.

1 OF 3

	A		C CONTINUED		E CONTINUED		H		M CONTINUED	
AB	AGGREGATE BASE	CHSRA	CALIFORNIA HIGH SPEED RAIL AUTHORITY	EU	UNBALANCED SUPERELEVATION	Н	HEIGHT	MOD	MODIFIED, MODIFY	
ABBC	ASBESTOS BONDED BITUMINOUS COATED	CHST	CALIFORNIA HIGH SPEED TRAIN	EASE	EASEMENT	HR	HOUR	MON	MONUMENT	
ABM	AIR-BLOWN MORTAR	CHSR	CALIFORNIA HIGH SPEED RAIL	EB	END OF BRIDGE, EASTBOUND	HD	HORIZONTAL DRAIN	MP	METAL PLATE	
ABN	ABANDON	CG	CENTER OF GRAVITY	EC	END HORIZONTAL CURVE	HDWL	HEADWALL	MPGR	METAL PLATE GUARD RAILING	
ABUT	ABUTMENT	CHNL	CHANNEL	ECR	END CURB RETURN	HEX HD	HEXAGONAL HEAD	MPH	MILES PER HOUR	
AC	ASPHALT CONCRETE	CI	CAST IRON	ED	EDGE DRAIN	HMA	HOT MIXED ASPHALT	MR	MOVEMENT RATING	
ACB	ASPHALT CONCRETE BASE	CIDH	CAST-IN-DRILLED-HOLE	EDC	EDGE DRAIN CLEANOUT	HORIZ	HORIZONTAL	MSE	MECHANICALLY STABILIZED EARTH	
ACP	ASBESTOS CEMENT PIPE	CIP,C-I-P	CAST-IN-PLACE. CAST IRON PIPE	EDO	EDGE DRAIN OUTLET	HP	HINGE POINT, HORSEPOWER	MTL	MATERIAL	
ADL	ADDED DEAD LOAD	CIPCP	CAST IN PLACE CONCRETE PIPE	EDV	EDGE DRAIN VENT	HPS	HIGH PERFORMANCE STEEL	MSS	MOVING SCAFFOLDING SYSTEM	
ADJ	ADJUST	CISS	CAST-IN-STEEL-SHELL	ELEC	ELECTROLIER, ELECTRICAL	HS	HIGH STRENGTH	Wico		
		CJP		ELECT	•	HST	HIGH SPEED TRAIN		N	
ADMIN	ADMINISTRATION		COMPLETE JOINT PENETRATION		ELECTRIC					
AFES	ALTERNATIVE FLARED END SECTION	CL, ©	CENTER LINE, CLASS	ELEV	ELEVATION	HSR	HIGH SPEED RAIL	N	NORTH, NORTHING	
AHD	AHEAD	CL2	CLASS 2	EMB	EMBANKMENT	HW	HEADWALL, HIGH WATER	NB	NORTHBOUND	
ALT	ALTERNATE	CL-6	CHAIN LINK FENCE (6 FT)	ENGR	ENGINEER	HWM	HIGH WATER MARK	NO.	NUMBER (MUST HAVE PERIOD)	
AM	TIME FROM MIDNIGHT TO NOON	CLR	CLEAR, CLEARANCE	EOD	EDGE OF DECK	HWY	HIGHWAY	NOS.	NUMBERS (MUST HAVE PERIOD)	
AP	ALTERNATIVE PIPE	CM	CORRUGATED METAL	EP	EDGE OF PAVEMENT			NPS	NOMINAL PIPE SIZE	
APC	ALTERNATIVE PIPE CULVERT	CMP	CORRUGATED METAL PIPE	EQ	EQUATION, EQUAL			NS	NEAR SIDE	
APPROX	APPROXIMATE	CO	COUNTY	ES	EDGE OF SHOULDER	IB	IMPORTED BORROW	NTS	NOT TO SCALE	
APU	ALTERNATIVE PIPE UNDERDRAIN	COL	COLUMN	ETW	EDGE OF TRAVELED WAY	ID	INSIDE DIAMETER	N/A	NOT APPLICABLE	
ARS	ACCELERATION RESPONSE SPECTRUM	COMM	COMMUNICATION	EVC	END VERTICAL CURVE	IF	INSIDE FACE			
AR	ACCESS RESTRICTION	CONC	CONCRETE	EW	ENDWALL CORVE	IN	INCH, INCHES		0	
						INT	INTERIOR	05/5	ODLITEDATE	
AS	AGGREGATE SUBBASE	COND	CONDUIT	EXC	EXCAVATION	INV	INVERT	OBLR	OBLITERATE	
ASRP	ALUMINUM SPIRAL RIB PIPE	CONN	CONNECTOR	EXIST, EX.	EXISTING	IRR	IRRIGATION	OC	OVERCROSSING	
ASSY	ASSEMBLY	CONST	CONSTRUCT, CONSTRUCTION	EXP	EXPANSION,	INN		ocs	OVERHEAD CONTACT SYSTEM	
ATPB	ASPHALT TREATED PERMEABLE BASE	CONT	CONTINUOUS	EXP JT	EXPANSION JOINT		J	OD	OUTSIDE DIAMETER	
ATPM	ASPHALT TREATED PERMEABLE MATERIAL	COORD	COORDINATE	EXWY	EXPRESSWAY	JCT	JUNCTION	OF	OUTSIDE FACE	
AVE	AVENUE	CP	CANDLEPOWER	EXT	EXTERIOR			OG	ORIGINAL GROUND	
AVG	AVERAGE	CR	CREEK			JP	JOINT POLE	OGAC	OPEN GRADED ASPHALT CONCRET	E
@	AT	CRCP	CONTINUOUS REINFORCED CONCRETE PAVEM	ENT	(F)	JPCP	JOINTED PLAIN CONCRETE PAY	/EMENT OH	OVERHEAD	
		CRSP	CONCRETED ROCK SLOPE PROTECTION	F&C	FRAME AND COVER	JS	JUNCTION STRUCTURE	0-0	OUT TO OUT	
	( <u>B</u>	CS	CURVE TO SPIRAL	F&G	FRAME AND GRATE	JT	JOINT	OPP	OPPOSITE	
BAGR	PRIDOF ARRESTALL CHARD DAIL INC	CSP	CORRUGATED STEEL PIPE	FB	FLOOR BEAM		K	Oli	OFFOSITE	
	BRIDGE APPROACH GUARD RAILING			F-B					P	
BB	BEGINNING OF BRIDGE	CSPA	CORRUGATED STEEL PIPE ARCH		FRESNO TO BAKERSFIELD	K	DISTANCE TO ACHIEVE 1% GRA			
BC	BEGIN HORIZONTAL CURVE	СТВ	CEMENT TREATED BASE	FDN	FOUNDATION			Р	PAGE	
BCC	BALANCED CANTILEVER CONSTRUCTION	CTPB	CEMENT TREATED PERMEABLE BASE	FEBT	FACING EASTBOUND TRAFFIC		L	PAP	PERFORATED ALUMINUM PIPE	
BCR	BEGIN CURB RETURN	CTPM	CEMENT TREATED PERMEABLE MATERIAL	FES	FLARED END SECTION	L	LENGTH	PB	PULL BOX	
BEG	BEGIN	CTRS	CENTERS	FF	FILTER FABRIC	LAT	LATITUDE	PC	POINT OF CURVATURE, PRECAST	
BIT CTD	BITUMINOUS COATED	CVFPB	CENTRAL VALLEY FLOOD PROTECTION BOARD	FG	FINISHED GRADE	LCB	LEAN CONCRETE BASE	PCC	POINT OF COMPOUND CURVE,	
BK	BACK	CULV	CULVERT	FH	FIRE HYDRANT	LN	LANE		PORTLAND CEMENT CONCRETE	
BKF	BACKFILL	C	CENTERLINE	FIG	FIGURE	LOC	LOCATION	PCP	PERFORATED CONCRETE PIPE,	
BLDG	BUILDING	_		FL	FLOW LINE	LOL	LAYOUT LINE		PRESTRESSED CONCRETE PIPE	
BLM	BRIDGE-LOG MILE		(D)	FNBT	FACING NORTHBOUND TRAFFIC	LONG	LONGITUDE	PCVC	POINT OF COMPOUND VERTICAL CL	IRVE
		D	DEPTH	FOC	FACE OF CONCRETE			PED	PEDESTRIAN	SITVE
BLVD	BOULEVARD					LONGIT	LONGITUDINAL			
BM	BENCH MARK	DD	DOWNDRAIN, DIRECTIVE DRILLING	FR RD	FRONTAGE ROAD	LS	LENGTH OF SPIRAL	PED OC	PEDESTRIAN OVERCROSSING	
BND	BOUND	DBL	DOUBLE	FS	FAR SIDE, FINISHED SURFACE	LC	LENGTH OF CURVE	PED UC	PEDESTRIAN UNDERCROSSING	
BNSF	BURLINGTON NORTHERN SANTA FE	DEG	DEGREE	FSBT	FACING SOUTHBOUND TRAFFIC	LT	LEFT	PERM MTL	PERMEABLE MATERIAL	
BOT	BOTTOM	DEL	DELINEATOR	FT	FOOT, FEET		M	PG	PROFILE GRADE	
BR	BRIDGE	DET	DETAIL, DETOUR	FTG	FOOTING			PI	POINT OF INTERSECTION	
BRG	BEARING	DF	DOUGLAS FIR	FWBT	FACING WESTBOUND TRAFFIC	MACH	MACHINE	PJP	PARTIAL JOINT PENETRATION	
BTU	BRITISH THERMAL UNIT	DI	DRAINAGE INLET, DROP INLET	FWY	FREEWAY	MAINT	MAINTENANCE	Â,PL	PLATE	
BVC	BEGIN VERTICAL CURVE	DIA	DIAMETER	FPLM	FULL SPAN PRECAST	MAX	MAXIMUM	P/L	PROPERTY LINE	
BW	BARBED WIRE	DIAPH	DIAPHRAGM	i i Livi	LAUNCHING METHOD	MB	METAL BEAM	PM	POST MILE, TIME FROM NOON TO M	IIDNIGHT
DVV	DANDED WINE				LACINOLILING IVIE I FIOD	MBB	METAL BEAM BARRIER		<i>'</i>	ווטואוטהו
	( C	DIST	DISTANCE, DISTRICT		G	MBGR	METAL BEAM GUARD RAILING	PN	PAVING NOTCH	
		DMBB	DOUBLE METAL BEAM BARRIER		<u> </u>	MED	MEDIAN	POB	POINT OF BEGINNING	
CAA	CABLE ANCHOR ASSEMBLY	DR	DRIVE	G	ACCELERATION DUE TO GRAVITY			POC	POINT OF HORIZONTAL CURVE	
CAP	CORRUGATED ALUMINUM PIPE	DTBB	DOUBLE THRIE BEAM BARRIER	GA	GAGE	M-F	MERCED TO FRESNO	POE	POINT OF ENDING	
CAPA	CORRUGATED ALUMINUM PIPE ARCH	DWG	DRAWING	GALV	GALVANIZED	MH	MANHOLE	POT	POINT OF TANGENT	
CAS	CONSTRUCTION AREA SIGN	DWY	DRIVEWAY	GP	GRADING PLANE	MIN	MINIMUM	POVC	POINT OF VERTICAL CURVE	
СВ	CONCRETE BARRIER			GR	GUARD RAILING	MISC	MISCELLANEOUS	PP	PIPE PILE, PLASTIC PIPE, POWER PO	OLE
CBW	CONCRETE BLOCK WALL		( <u>E</u>	GSP	GALVANIZED STEEL PIPE	MISC I & S	IRON AND STEEL	PPL	PREFORMED PERMEABLE LINER	
C-C	CENTER TO CENTER	E	EAST, EASTING	GTR	GUTTER	MKR	MARKER	PPP	PERFORATED PLASTIC PIPE	
5 5	SERVENTIO SERVENT	EA	ACTUAL SUPERELEVATION	din	SOTIEN	M/L	MAIN LINE (RAILWAY)	PRC	POINT OF REVERSE CURVE	
		EA			·	141/ -		PHC	FOINT OF NEVENSE CURVE	Las
			DESIGNED BY E. NAOR					CALIFORNIA HIGH-SPEE	D TRAIN PROJECT	CONTRACT NO.
			DRAWN BY RECORD SET 15%	\(\sigma_1, \ldots \)				FRESNO TO BAI		HSF DRAWING NO.
$\rightarrow$			D. BACKMAN DESIGN SUBMISSION	\ URS HMM	ARUP					DHAWING NO.
$\rightarrow$			CHECKED BY - F. KING NOT FOR	4				STATIONS DR		SCALE
			No. 1 on					PLANS, ELEVATIONS	AND SECTIONS	JUALE
$\Box$			IN CHARGE CONSTRUCTION	7		CALIFORI	<i>V/A</i>	. =, ===		
			IN CHARGE CONSTRUCTION E. NAOR DATE	CALIFORNIA H		CALIFORI IGH-SPEED RAIL AUTH		,		SHEET NO.


		P CONTINUED		S CONTINUED		V	
	PRF	PAVEMENT REINFORCING FABRIC	SIM	SIMILAR	V	VALVE,	
	PRVC	POINT OF REVERSE VERTICAL CURVE	S	STATION LINE		DESIGN SPEED	
	PS&E	PLANS, SPECIFICATIONS AND ESTIMATES	SM	SELECTED MATERIAL	VAR	VARIABLE	
	PS, P/S	PRESTRESSED, PARALLEL STATION	SPEC	SPECIAL, SPECIFICATIONS	VC	VERTICAL CURVE	
	PSB	PASSENGER SERVICE BOOTH	SP	SOUTHERN PACIFIC	VCP	VITRIFIED CLAY PIPE	
	PSP	PERFORATED STEEL PIPE	SPRR	SOUTHERN PACIFIC RAILROAD	VERT	VERTICAL	
	PT	POINT OF TANGENCY	SPP	SLOTTED PLASTIC PIPE	VIA	VIADUCT	
	PVC	POLYVINYL CHLORIDE	SS	SLOPE STAKE, SPIRAL TO SPIRAL	VOL	VOLUME	
	PVI	POINT OF VERTICAL INTERSECTION	SSBM	STRAP AND SADDLE BRACKET METHOD		W	
	PVMT	PAVEMENT	SSD	STRUCTURAL SECTION DRAIN			
	Pbmax	PEAK PASSENGER BOARDINGS	SSPA	STRUCTURAL STEEL PLATE ARCH	W	WEST,	
	P60b	PEAK HOURLY BOARDINGS	SSPP	STRUCTURAL STEEL PLATE PIPE		WIDTH	
	P15	PEAK 15 MINUTE BOARDINGS	SSPPA	STRUCTURAL STEEL PLATE PIPE ARCH	WB	WESTBOUND	
			SSRP	STEEL SPIRAL RIB PIPE	WH	WEEP HOLE	
		( Q	SR	STATE ROUTE	WM	WIRE MESH	
			ST	STREET, SPIRAL TO TANGENT	WS	WATER SURFACE	
	QTY	QUANTITY	STA	STATION	WSP	WELDED STEEL PIPE	
		R	STBB	SINGLE THRIE BEAM BARRIER	WT	WEIGHT	
	_		STD	STANDARD	WV	WATER VALVE	
	R	RADIUS	STR	STRUCTURE	WW	WINGWALL	
	R&D	REMOVE AND CALVACE	SRS	STAND ALONE RADIO SITE	WWLOL W/	WINGWALL LAYOUT LINE	
	R&S	REMOVE AND SALVAGE	SURF	SURFACING	W/	WITH	
1	R/C	RATE OF CHANGE	SW	SIDEWALK, SOUND WALL		X	
1	RCA	REINFORCED CONCRETE ARCH	SWR SWS	SEWER SWITCHING STATION	X SEC	CROSS SECTION	
	RCB	REINFORCED CONCRETE BOX				CROSSING	
	RCP	REINFORCED CONCRETE PIPE	SYM	SYMMETRICAL SUBFACE 4 SIDES	XING	ChOssilva	
	RCPA	REINFORCED CONCRETE PIPE ARCH ROAD	S4S	SURFACE 4 SIDES SAN JOAQUIN VALLEY RAILROAD		Y	
_	RD REINF	REINFORCED, REINFORCEMENT,	SJVRR	SAN JOAQUIN VALLET HAILHOAD	YR	YEAR	
≥	HEINF	REINFORCING		T	YRS	YEARS	
≥ <u>Ľ</u>	REL	RELOCATE	т	SEMI-TANGENT	mo	ILANO	
<u>п</u>	REPL	REPLACEMENT	TAB	TABLET			
	RET	RETAINING	TAN	TANGENT			
<u> </u>	REV	REVISED	TBB	THRIE BEAM BARRIER			
¥	RDWY	ROADWAY	TBD	TO BE DETERMINED			
General Mevil (GENERAL ORIEE I O EIN VS. IVI	RM	ROAD-MIXED	TBR	TIMBER			
5	RP	RADIUS POINT, REFERENCE POINT	TC	TOP OF CURB, TANGENT TO CURVE			
TA H	RR	RAILROAD	TCB	TRAFFIC CONTROL BOX			
	RSP	ROCK SLOPE PROTECTION	TEL	TELEPHONE			
a a a a a a a a a a a a a a a a a a a	RT	RIGHT	TELCOM	TELEPHONE COMMUNICATIONS			
	RTE	ROUTE	TEMP	TEMPORARY			
3	RW	REDWOOD, RETAINING WALL	TG	TOP OF GRADE			
<u> </u>	R/W, ROW	RIGHT OF WAY	TM	TECHNICAL MEMORANDUM			
	RWY	RAILWAY	TOR	TOP OF RAIL			
		C	TOT	TOTAL			
2   2		(S)	TP	TELEPHONE POLE			
	S	SOUTH, SUPPLEMENT	TPB	TREATED PERMEABLE BASE			
5	SAE	STRUCTURE APPROACH EMBANKMENT	TPM	TREATED PERMEABLE MATERIAL			
5	SALV	SALVAGE	TPSS	TRACTION POWER SUPPLY STATION			
2	SAPP	STRUCTURAL ALUMINUM PLATE PIPE	TRANS	TRANSITION, TRANSVERSE, TRANSPORTATION			
5 <sub>.</sub>	SB	SOUTHBOUND	TS	TRAFFIC SIGNAL, TUBULAR STEEL,			
<u> </u>	SC	SPIRAL TO CURVE		TANGET TO SPIRAL			
	SCSP	SLOTTED CORRUGATED STEEL PIPE	TVM	TICKET VENDING MACHINE			
F.M. 1025_ I MAN_UNS_HSM_Fresho-FalmdaleVUCADUNG.	SD	STORM DRAIN	TYP	TYPICAL			
ē	SEC	SECOND		U			
- [	SECT	SECTION					
1	SEP	SEPARATION	UC	UNDERCROSSING			
≥	SF, sf		UD	UNDERDRAIN			
7	sqft	SQUARE FOOT, SQUARE FEET	UON	UNLESS OTHERWISE NOTED			
95.	SG	SUBGRADE	UP	UNDERPASS			
5)30/2012 0.39304 PIN	SHLD	SHOULDER	UPRR	UNION PACIFIC RAILROAD			
DY I	01.17		USFW	UNITED STATES FISH AND WILDLIFE SERVICE			
76 T	SHT	SHEET					
$\vdash$	SHT	SHEET		DESIGNED BY			CALIEODAIIA LIIOLI OD
	SHT	SHEET		E. NAOR  DRAWN BY  RECORD SET 15%			CALIFORNIA HIGH-SP
	SHT	SHEET		E. NAOR  DRAWN BY D. BACKMAN  DESIGN SUBMISSION	JRS   HMM   ARL		FRESNO TO B
	SHT	SHEET		E. NAOR DRAWN BY D. BACKMAN CHECKED BY  E. NAOR  RECORD SET 15% DESIGN SUBMISSION	JRS   HMM   ARL		FRESNO TO B STATIONS
	SHT	SHEET		E. NAOR DRAWN BY D. BACKMAN CHECKED BY F. KING IN CHARGE  E. NAOR RECORD SET 15% DESIGN SUBMISSION NOT FOR CONSTRUCTION	JRS   HMM   ARL	CALIFORNIA	FRESNO TO B
REV DATE	SHT			E. NAOR  DRAWN BY D. BACKMAN CHECKED BY F. KING  RECORD SET 15% DESIGN SUBMISSION NOT FOR		CALIFORNIA	FRESNO TO B STATIONS


I-SPEED TRAIN PROJECT
D BAKERSFIELD
ONS DRAWINGS
ATIONS AND SECTIONS


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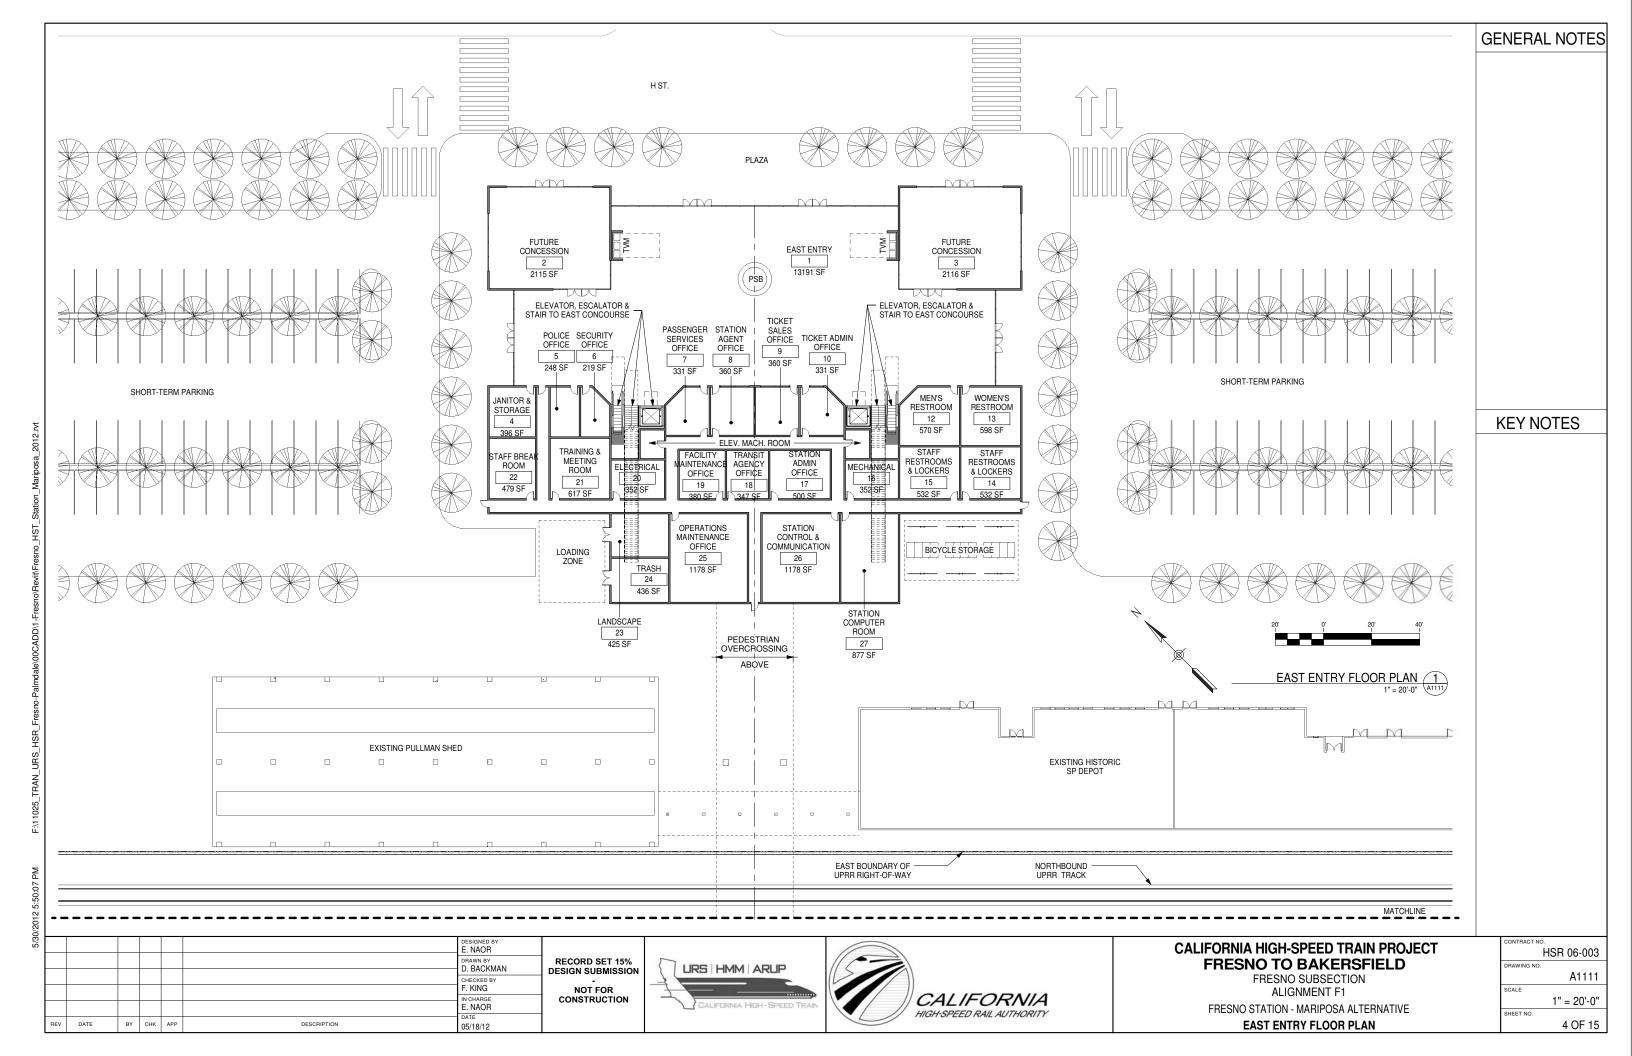
HSR 06-0003


GENERAL ABBREVIATIONS




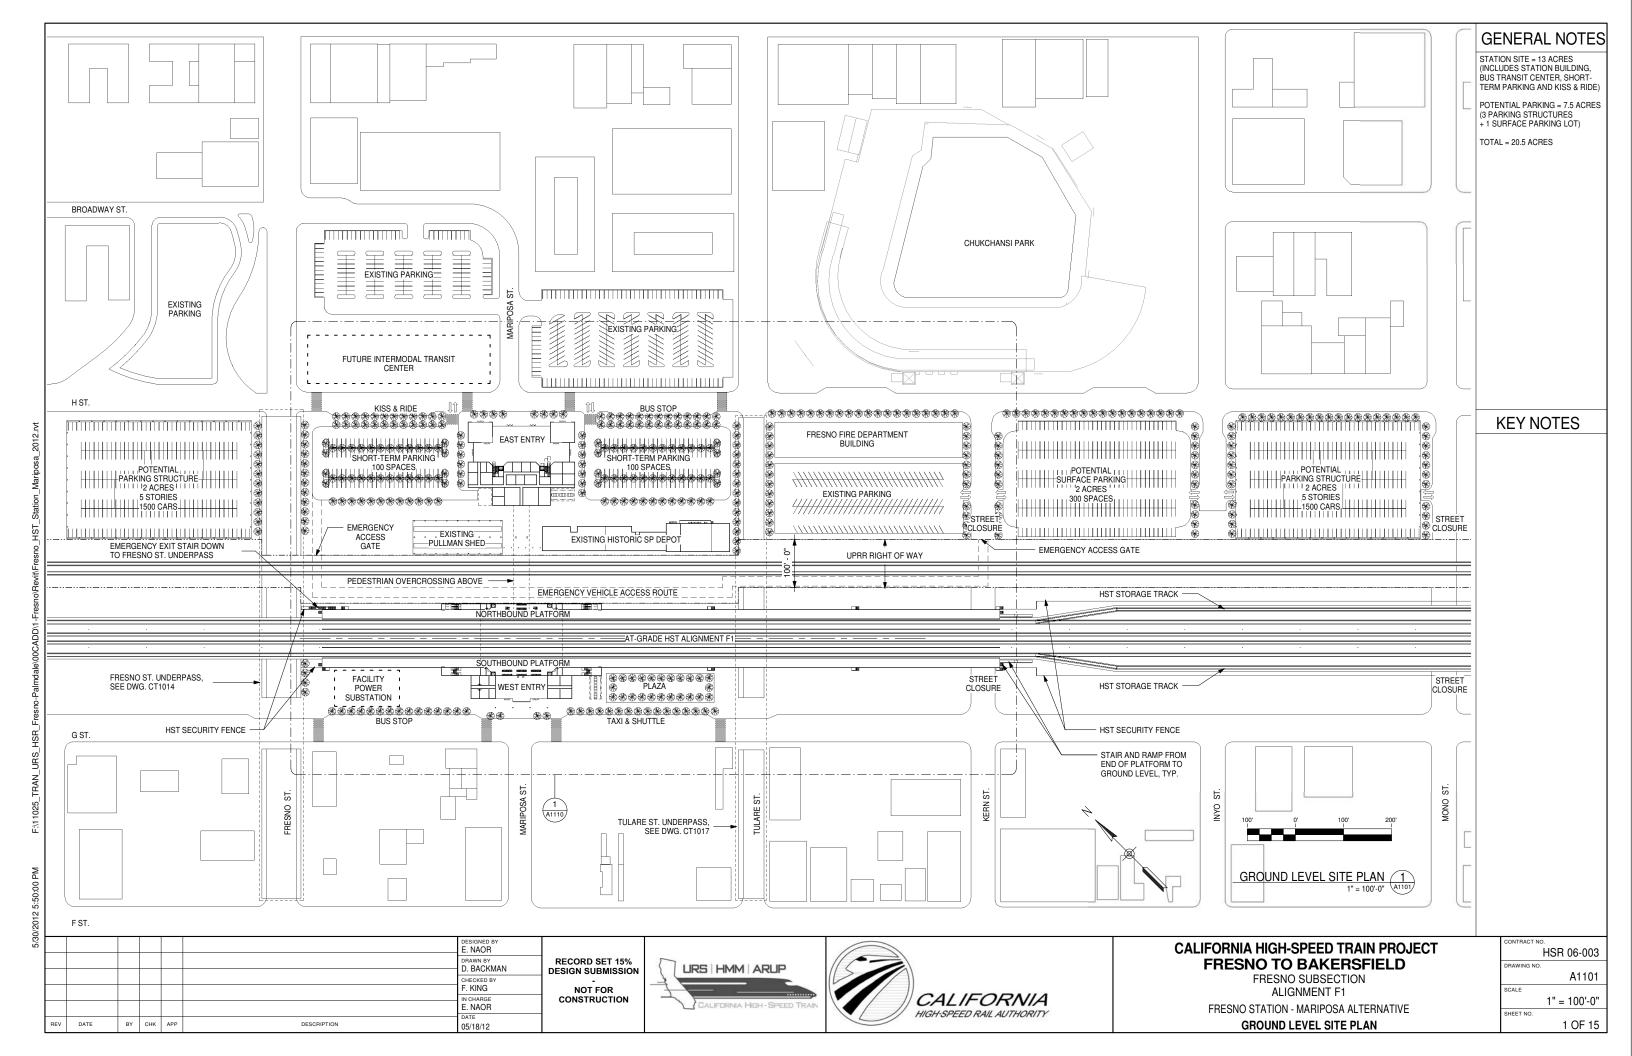


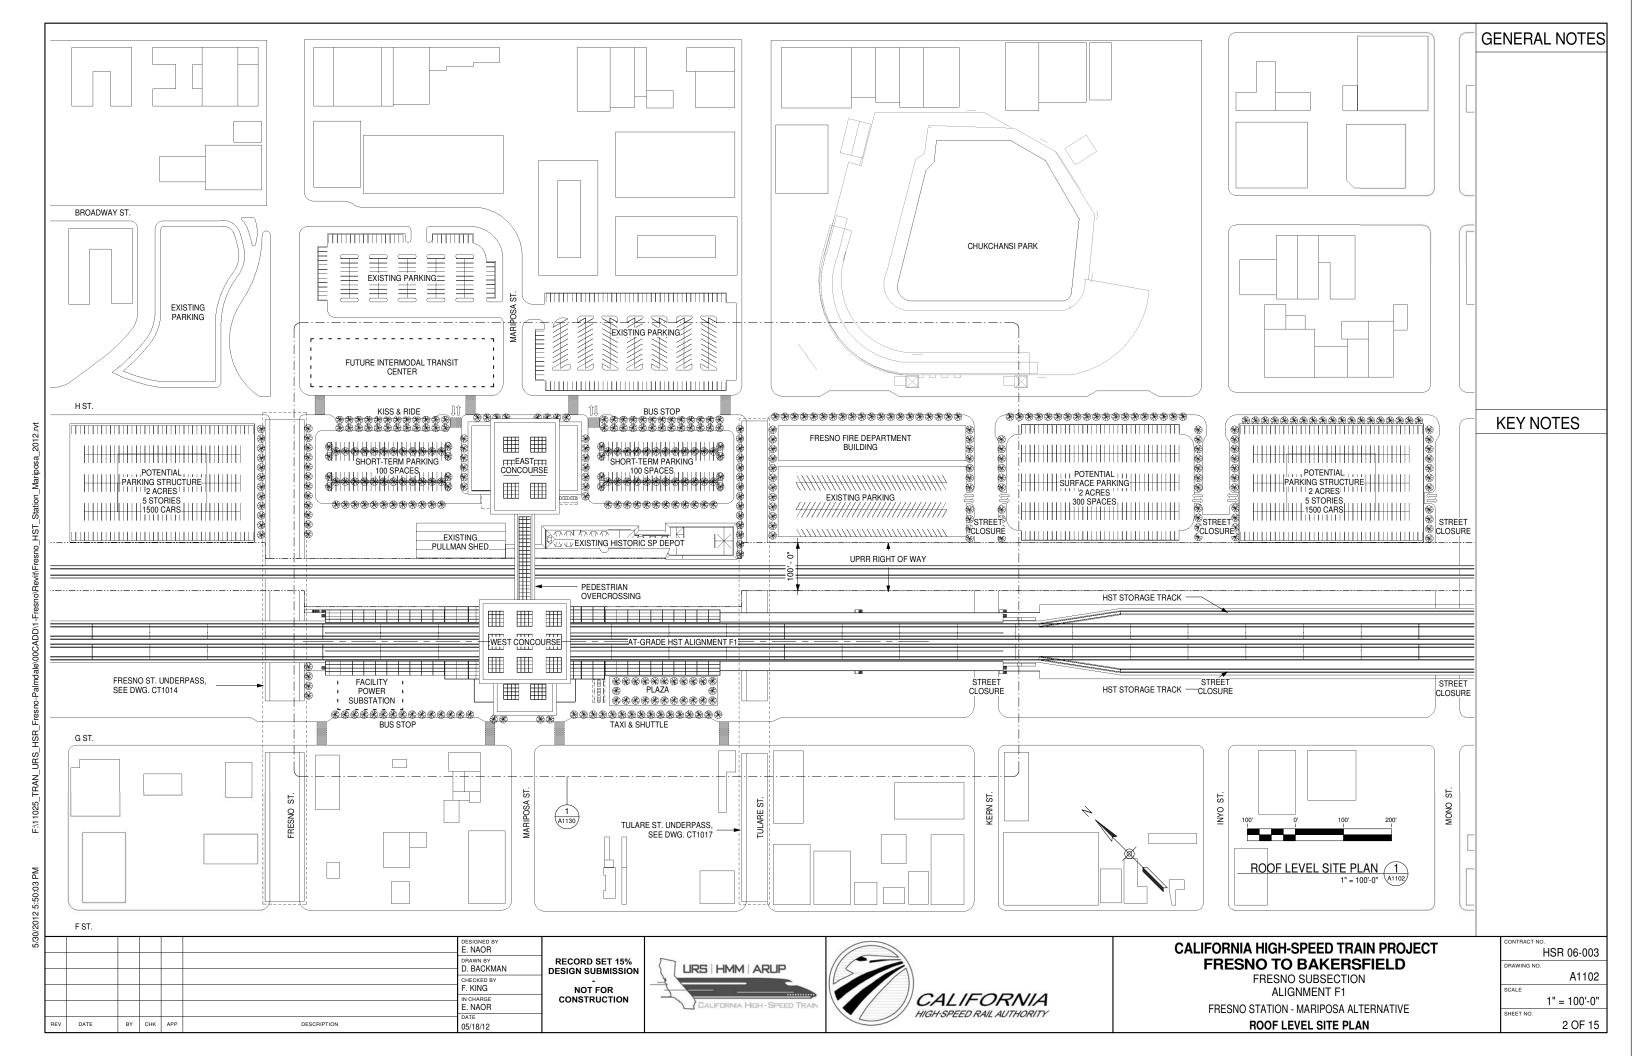


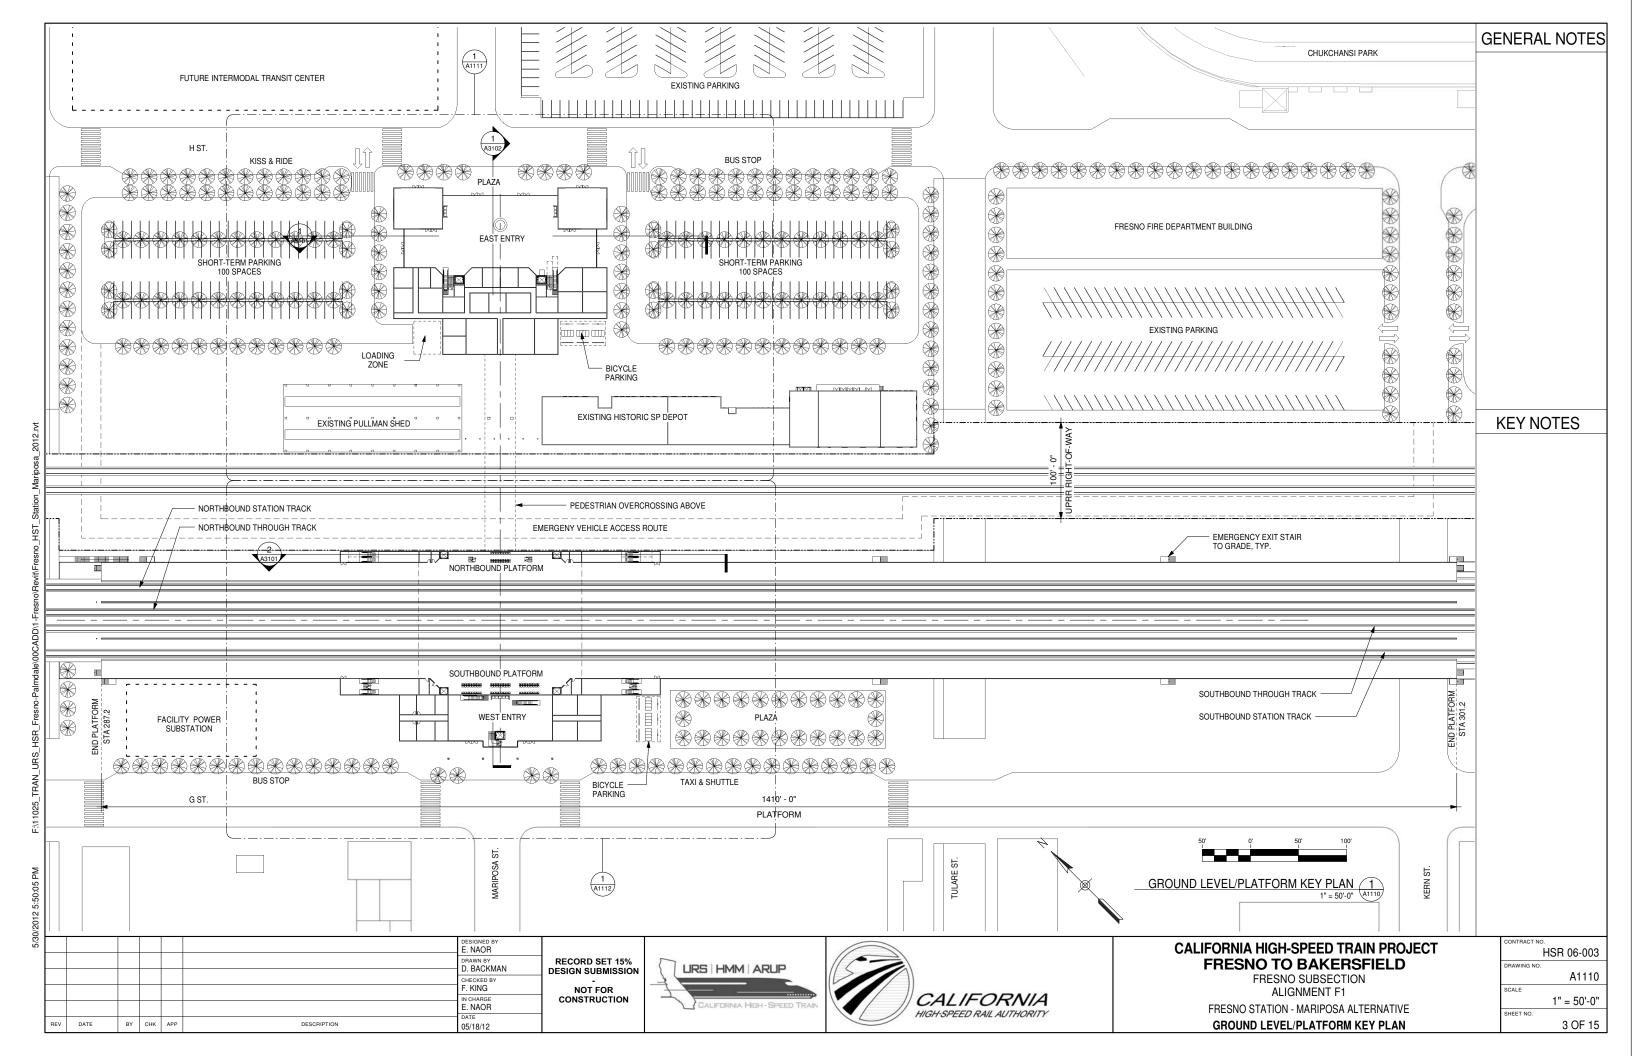


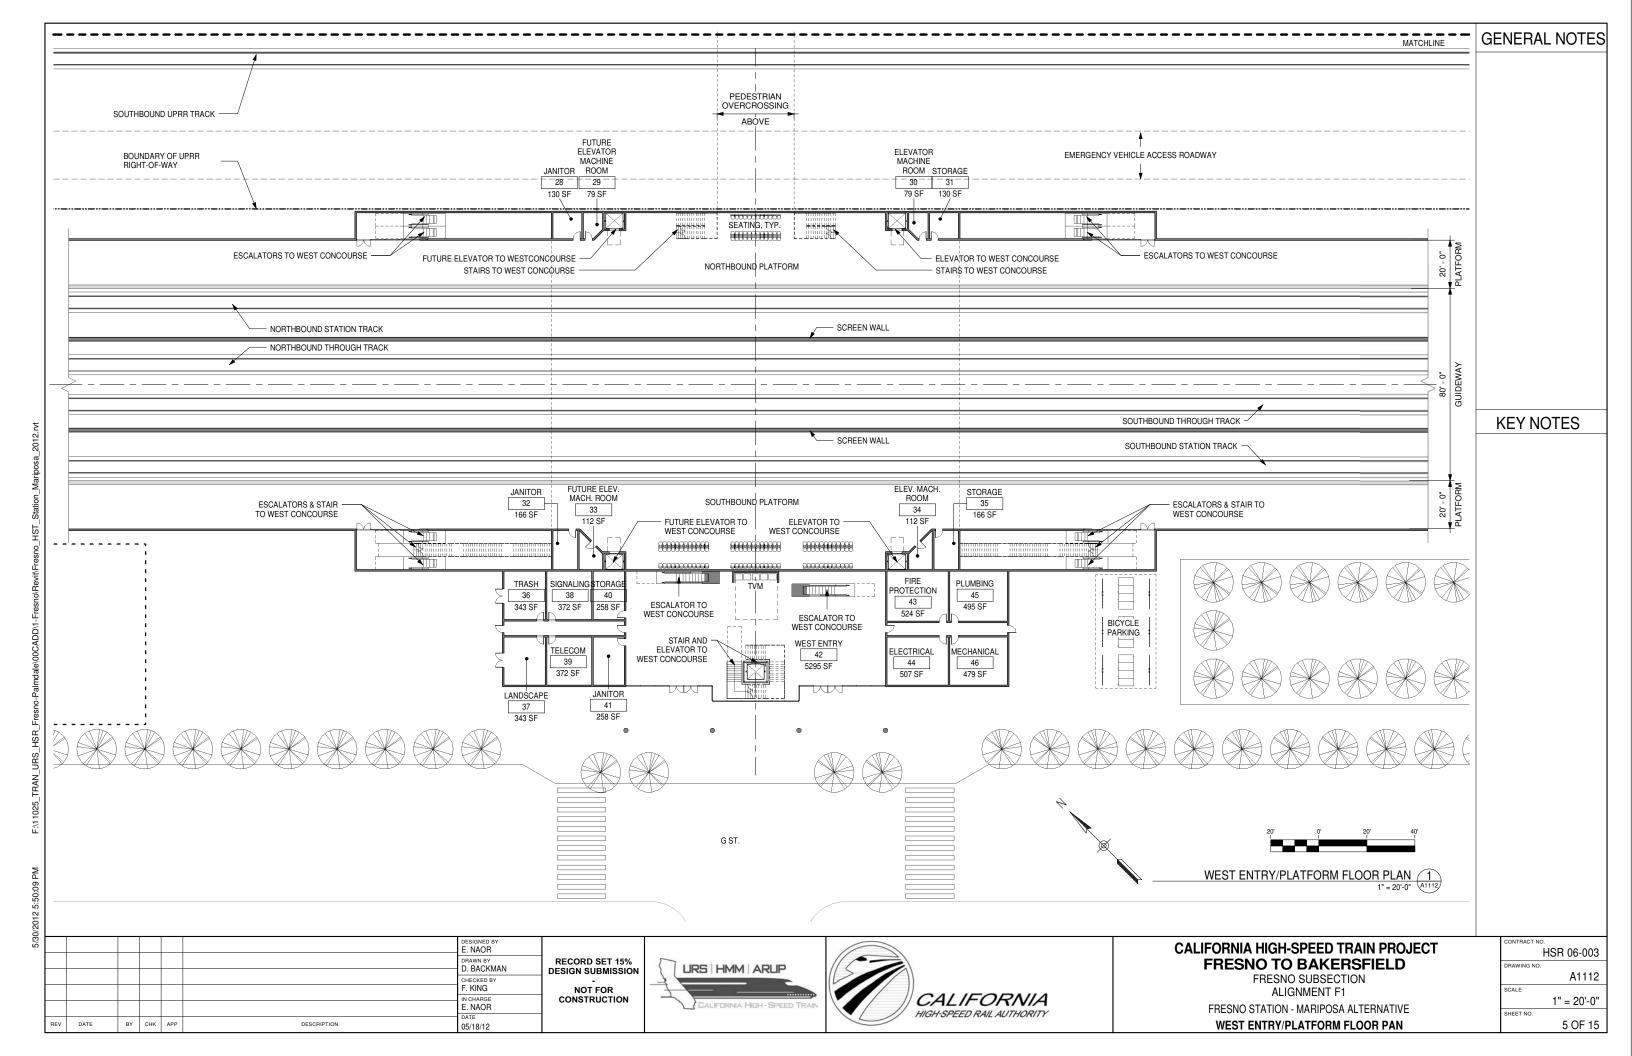


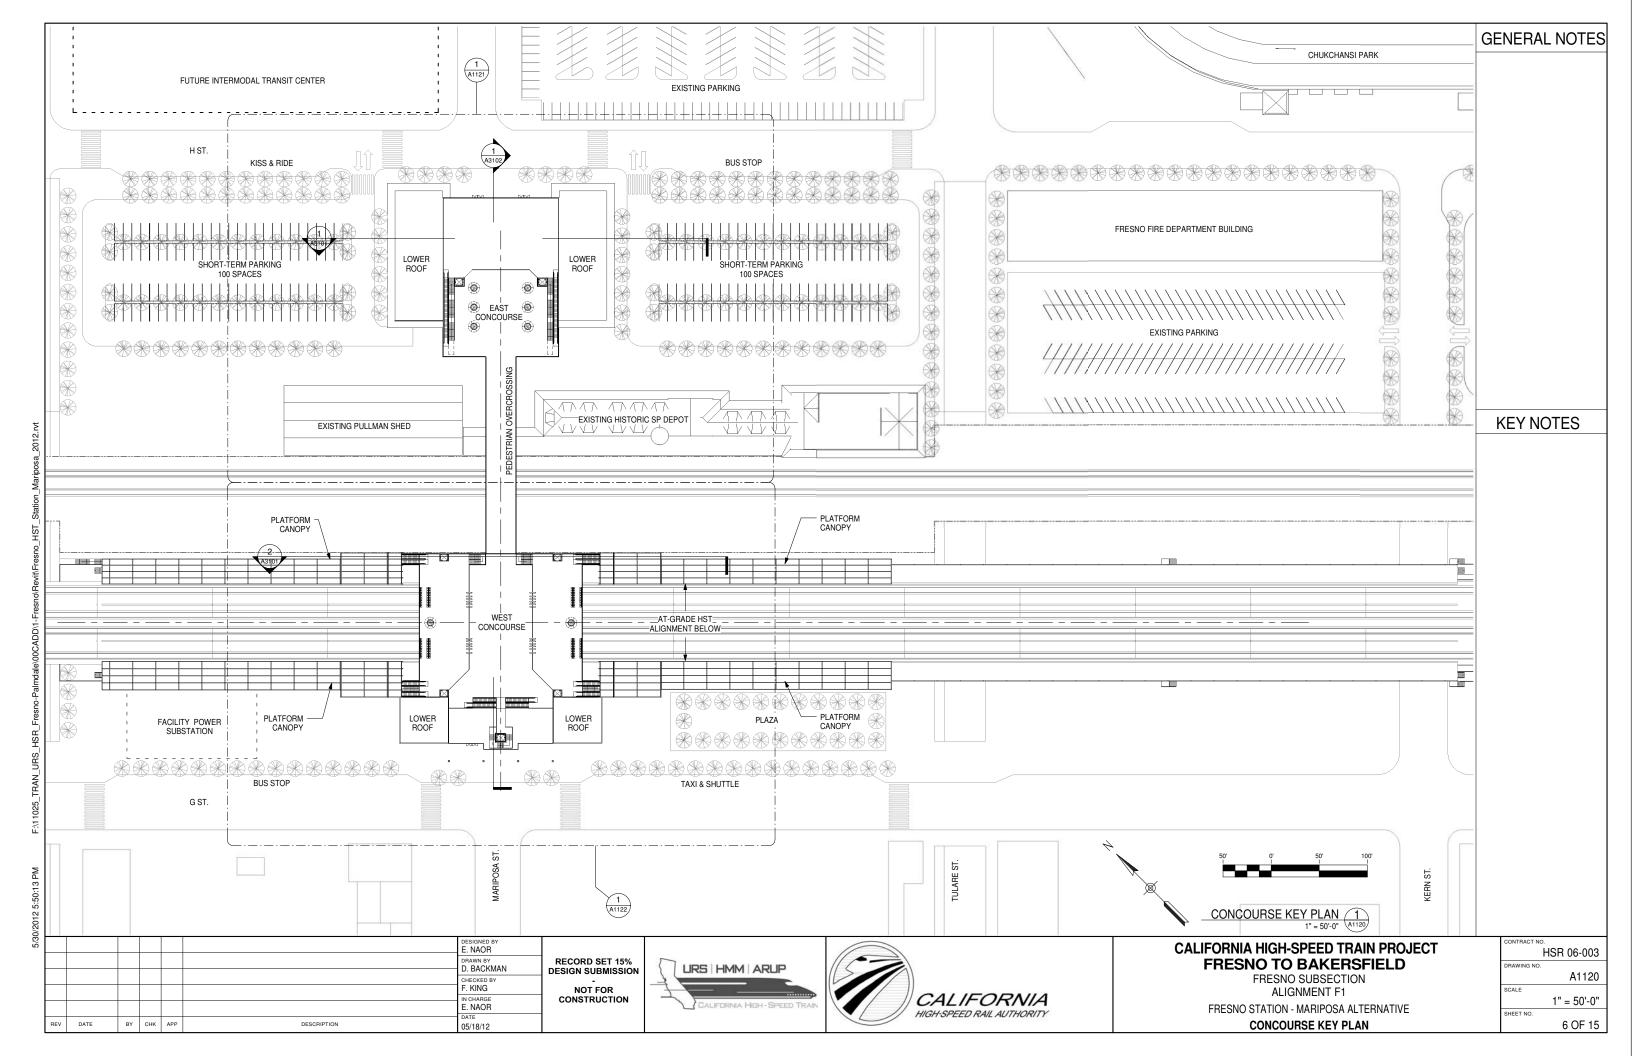


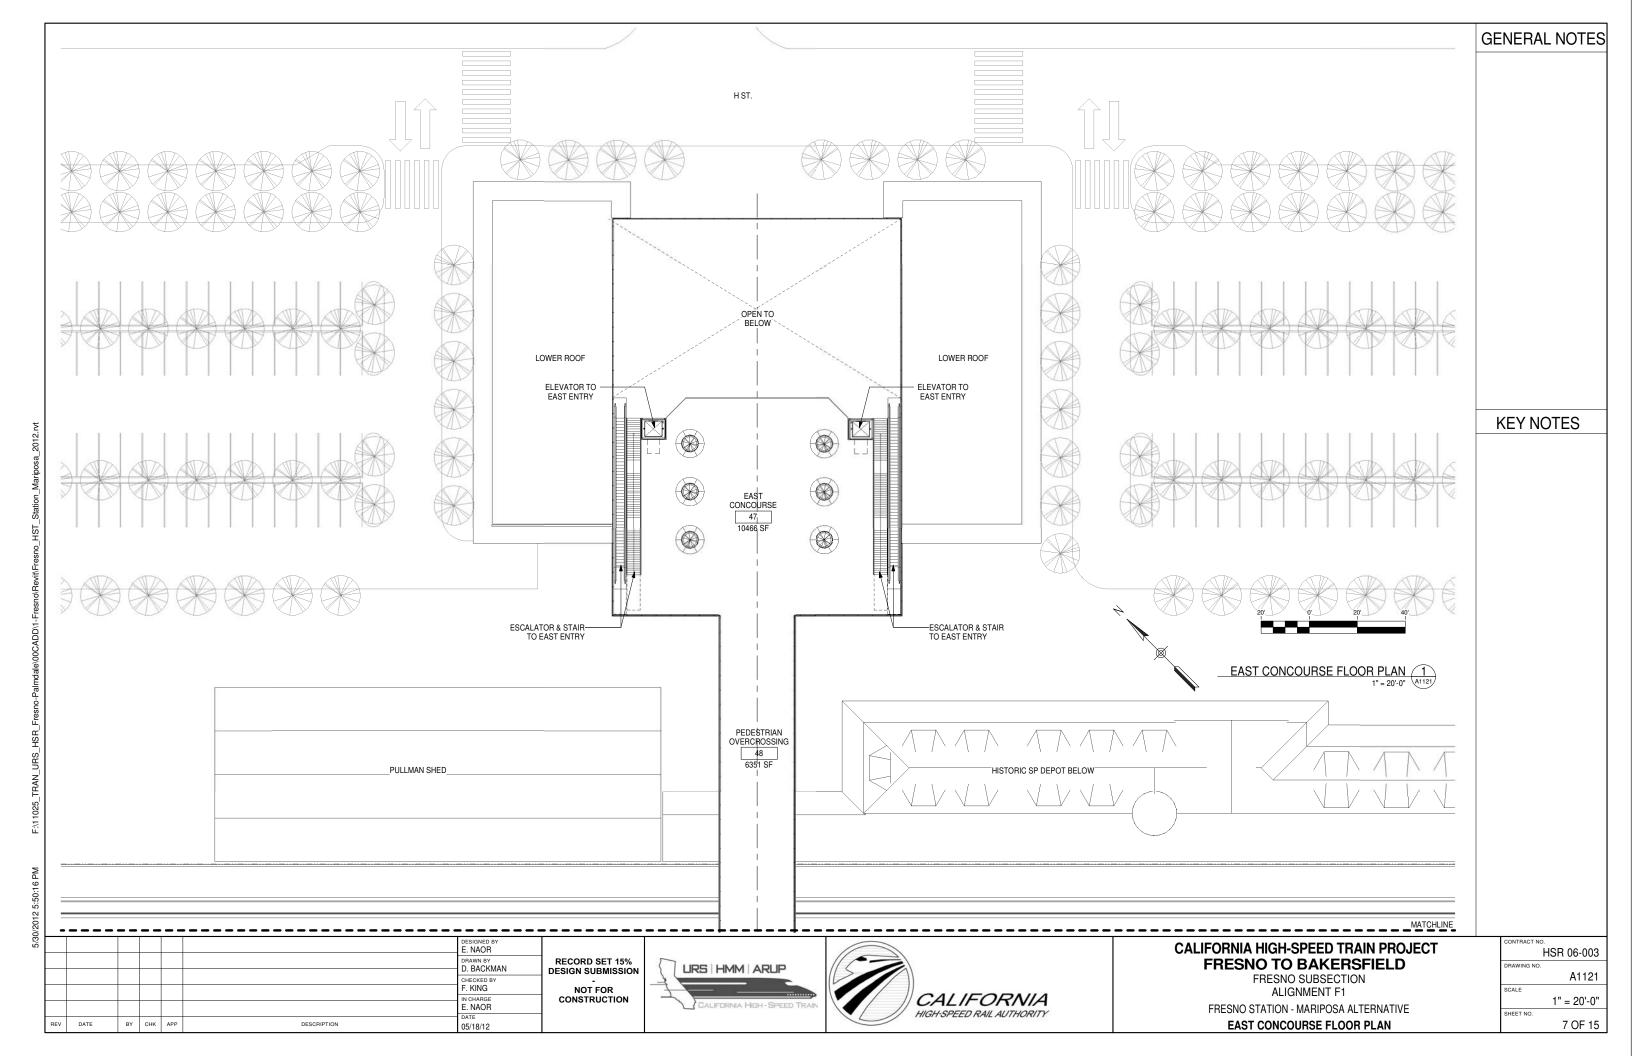

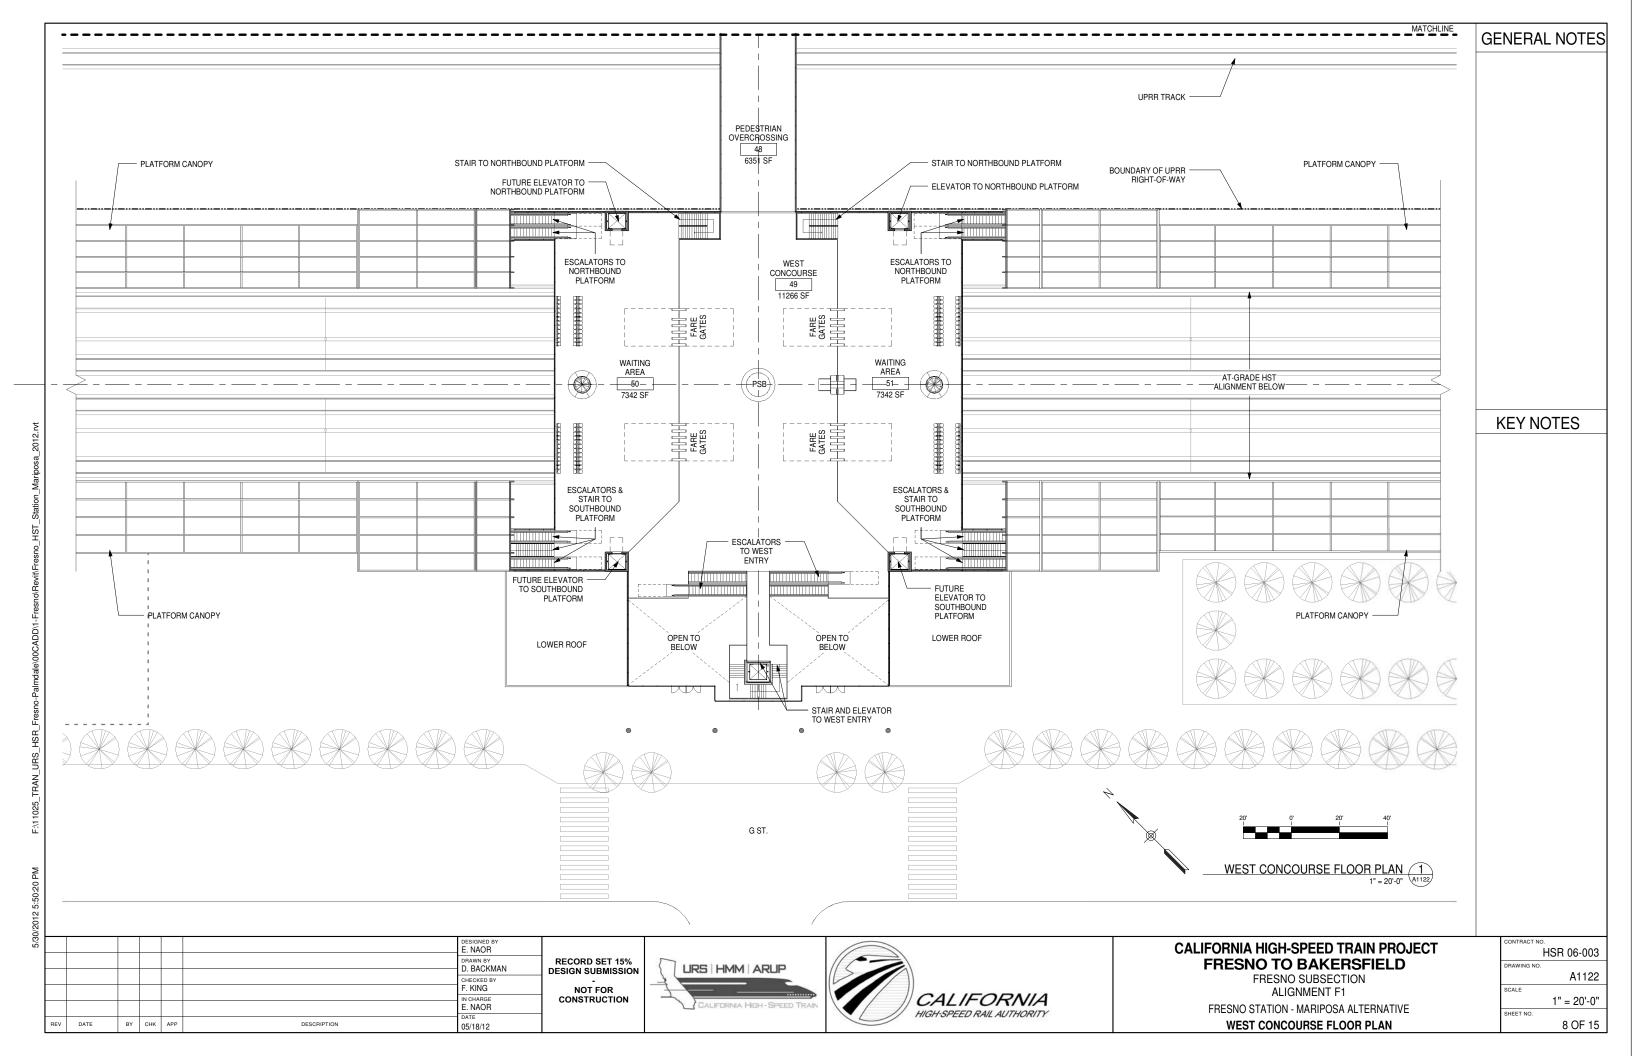

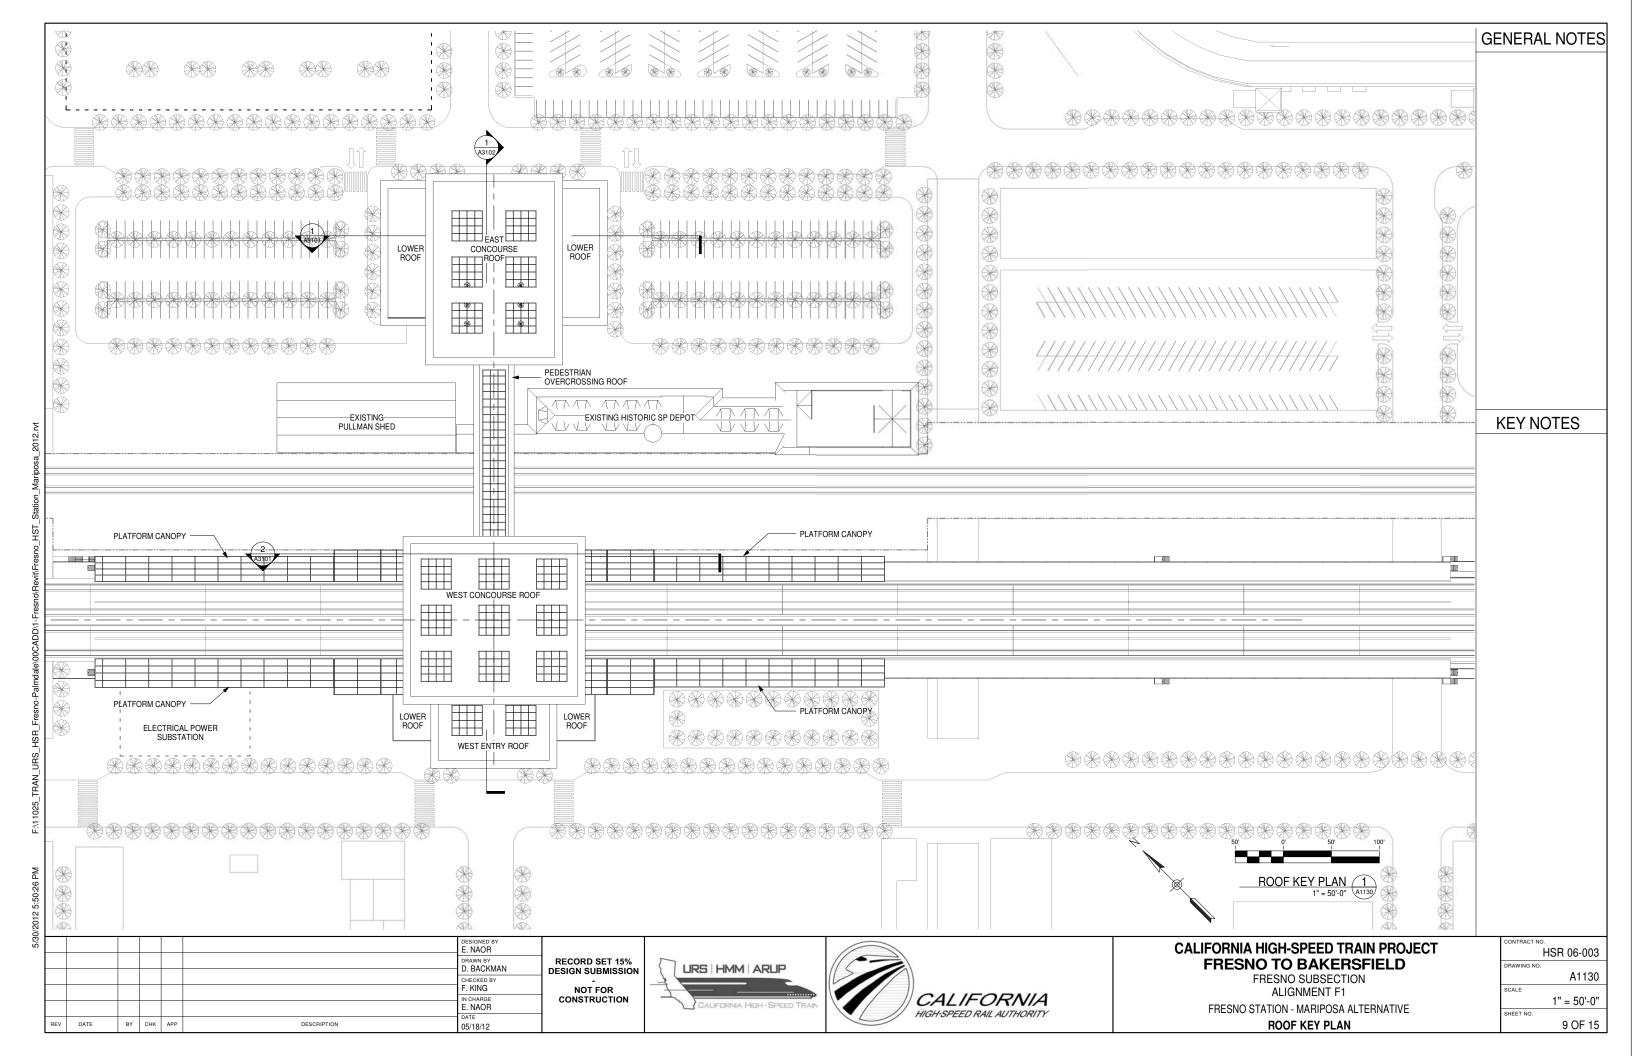

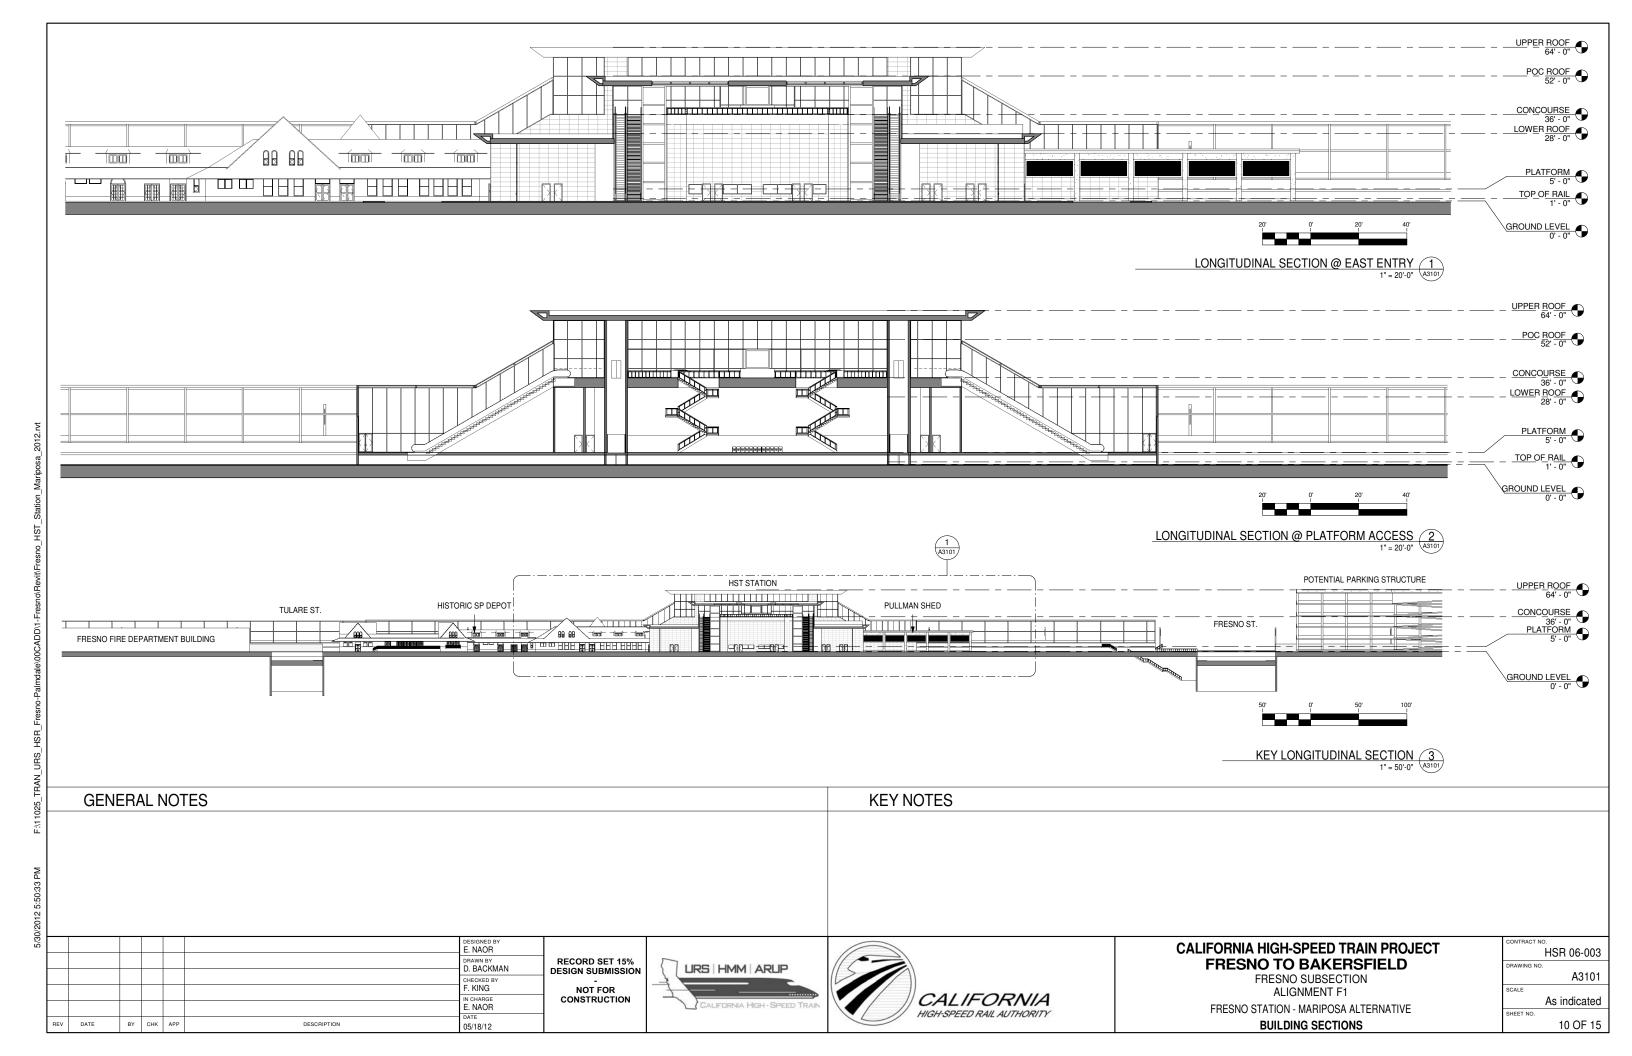

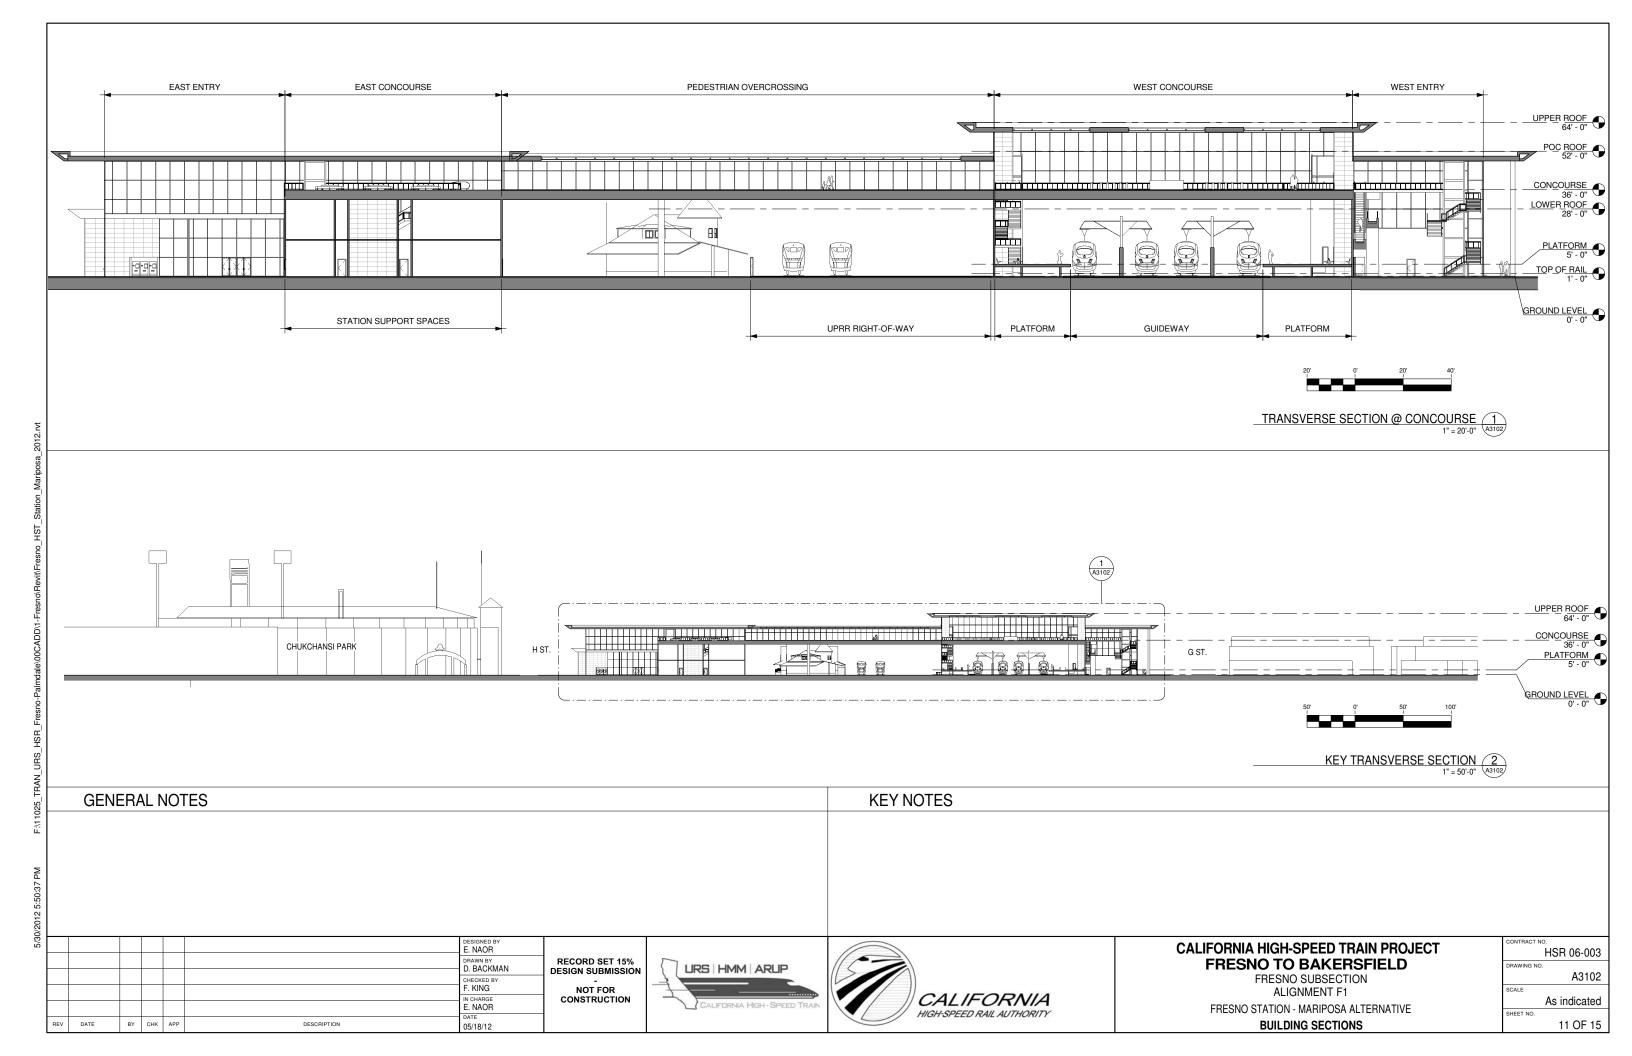

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			REQUIRED			
NO.	ROOM NAME	AREA	AREA	FORMULA	TM 2.2.2	COMMENTS
1101			1	1000000		• • • • • • • • • • • • • • • • • • • •
1 EAST EI	NTRY	13191 SF	11115 SF	P15x30sf/person	6.2.3.2	
	E CONCESSION	2115 SF	1111001	TBD	6.2.3.6	
	E CONCESSION	2116 SF		TBD	6.2.3.6	
	R & STORAGE	396 SF	110 SF	110 SF x 3	6.2.6.2.16	
	OFFICE	248 SF	160 SF	160 SF	6.2.6.2.8	
	ITY OFFICE	219 SF	160 SF	160 SF	6.2.6.2.7	
	NGER SERVICES OFFICE	331 SF	160 SF	160 SF	6.2.6.1.3	
	N AGENT OFFICE	360 SF	270 SF	270 SF	6.2.6.1.5.	
	SALES OFFICE	360 SF	143 SF	(((P60bx.15)/(1.5 x 60)) x 75) sqft	6.2.6.1.1	
	ADMIN OFFICE	331 SF	160 SF	160 SF	6.2.6.2.6	
	RESTROOM	570 SF	371 SF	P15	6.2.3.5	
	N'S RESTROOM	598 SF	371 SF	P15	6.2.3.5	
	RESTROOMS & LOCKERS	532 SF	3/13F	Local Codes	6.2.6.12/13	
	RESTROOMS & LOCKERS	532 SF		Local Codes	6.2.6.12/13	
16 MECHA		352 SF		TBD	6.4.6	
	N ADMIN OFFICE	500 SF			6.2.6.2.1	
	IT AGENCY OFFICE	347 SF	205.05	Based on Demand	6.2.6.11	
	TY MAINTENANCE OFFICE	380 SF	325 SF	325 SF	6.2.6.2.9	
20 ELECTF		352 SF	500.05	TBD (90.4) (9.4) (9.4) (9.4)	6.4.2	
	NG & MEETING ROOM	617 SF	500 SF	(20sqft x max staff per shift x 1.25)	6.2.6.2.2	
	BREAK ROOM	479 SF	125 SF		6.2.6.2.14	
23 LANDSO		425 SF		TBD	6.2.6.2.18	
24 TRASH		436 SF	54 SF	54 SF	6.2.6.2.15	
	TIONS MAINTENANCE OFFICE	1178 SF	1080 SF	1080 SF	6.2.6.2.10	
	N CONTROL & COMMUNICATION	1178 SF	1080 SF	1080 SF	6.2.6.2.3	
	N COMPUTER ROOM	877 SF	525 SF	525 SF	6.2.6.2.4	
28 JANITOI		130 SF	110 SF	110 SF	6.2.6.2.16	
	E ELEVATOR MACHINE ROOM	79 SF		TBD	6.2.5.2.4	
	FOR MACHINE ROOM	79 SF		TBD	6.2.5.2.4	
31 STORAG		130 SF	130 SF	130 SF	6.2.6.2.17	
32 JANITOI		166 SF	110 SF	110 SF	6.2.6.2.16	
	E ELEV. MACH. ROOM	112 SF		TBD	6.2.5.2.4	
	MACH. ROOM	112 SF		TBD	6.2.5.2.4	
35 STORAG		166 SF	130 SF	130 SF	6.2.6.2.17	
36 TRASH		343 SF	54 SF	54 SF	6.2.6.2.15	
37 LANDSO		343 SF		TBD	6.2.6.2.18	
38 SIGNAL		372 SF		TBD	6.4.7	
39 TELECC		372 SF		TBD	6.4.7	
40 STORAG	GE	258 SF	130 SF		6.2.6.2.17	
41 JANITOI	R	258 SF	110 SF	110 SF	6.2.6.2.16	
42 WEST E	ENTRY	5295 SF	11115 SF	P15x30sf/person	6.2.3.2	
43 FIRE PF	ROTECTION	524 SF		TBD	6.4.4	
44 ELECTF	RICAL	507 SF		TBD	6.4.2	
45 PLUMBI	ING	495 SF		TBD	6.4.3	
46 MECHA	NICAL	479 SF		TBD	6.4.6	
47 EAST C	ONCOURSE	10466 SF	11117 SF	P15x30sqft	6.2.4.1	
48 PEDEST	TRIAN OVERCROSSING	6351 SF		TBD	6.2.4.1	
49 WEST C	CONCOURSE	11266 SF	11117 SF	P15x30sqft	6.2.4.1	
50 WAITING		7342 SF	5187 SF	P15x14sqft or Pbmax x 10sqft or Pbmax x 10sqft	6.2.4.2	
51 WAITING	G AREA	7342 SF	5187 SF	P15x14sqft or Pbmax x 10sqft or Pbmax x 10sqft	6.2.4.2	

						DESIGNED BY E. NAOR	
						D. BACKMAN	R
						F. KING	
						IN CHARGE E. NAOR	
REV	DATE	BY	СНК	APP	DESCRIPTION	DATE 05/18/12	

RECORD SET 15% DESIGN SUBMISSION NOT FOR CONSTRUCTION







#### CALIFORNIA HIGH-SPEED TRAIN PROJECT FRESNO TO BAKERSFIELD


FRESNO SUBSECTION ALIGNMENT F1


FRESNO STATION - MARIPOSA ALTERNATIVE ROOM SCHEDULE


CONTRACT NO.
HSR 06-003
DRAWING NO.
A6101
SCALE
SHEET NO.
12 OF 15

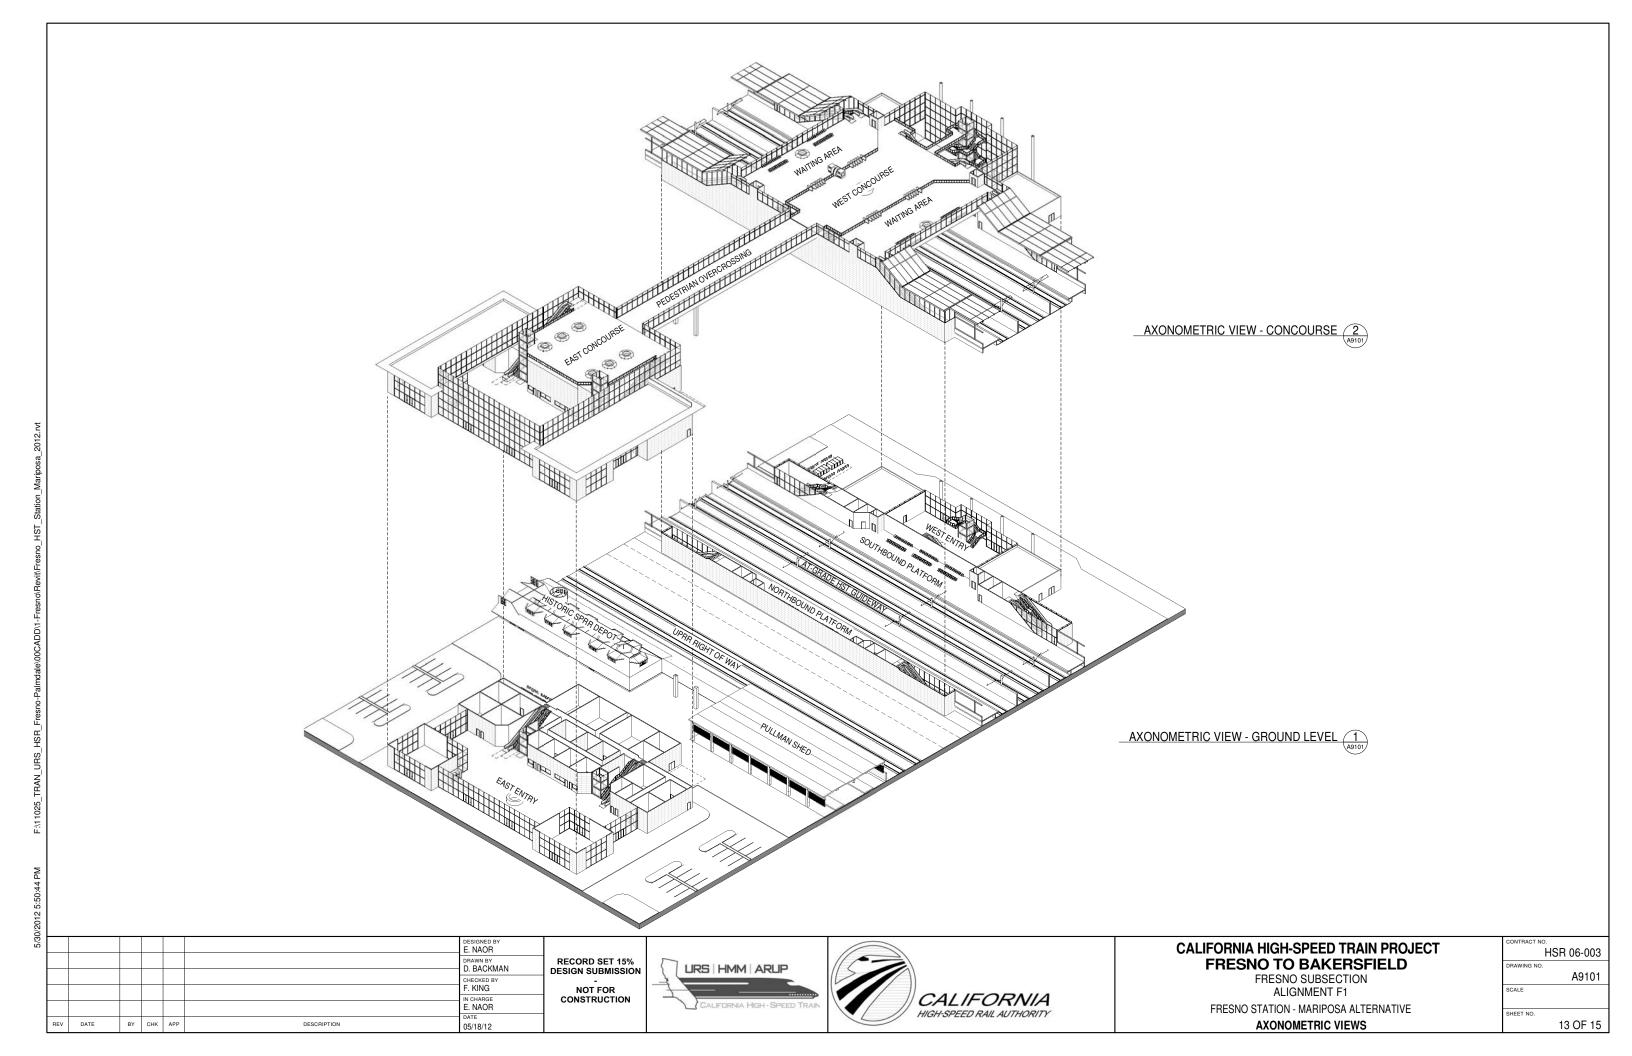


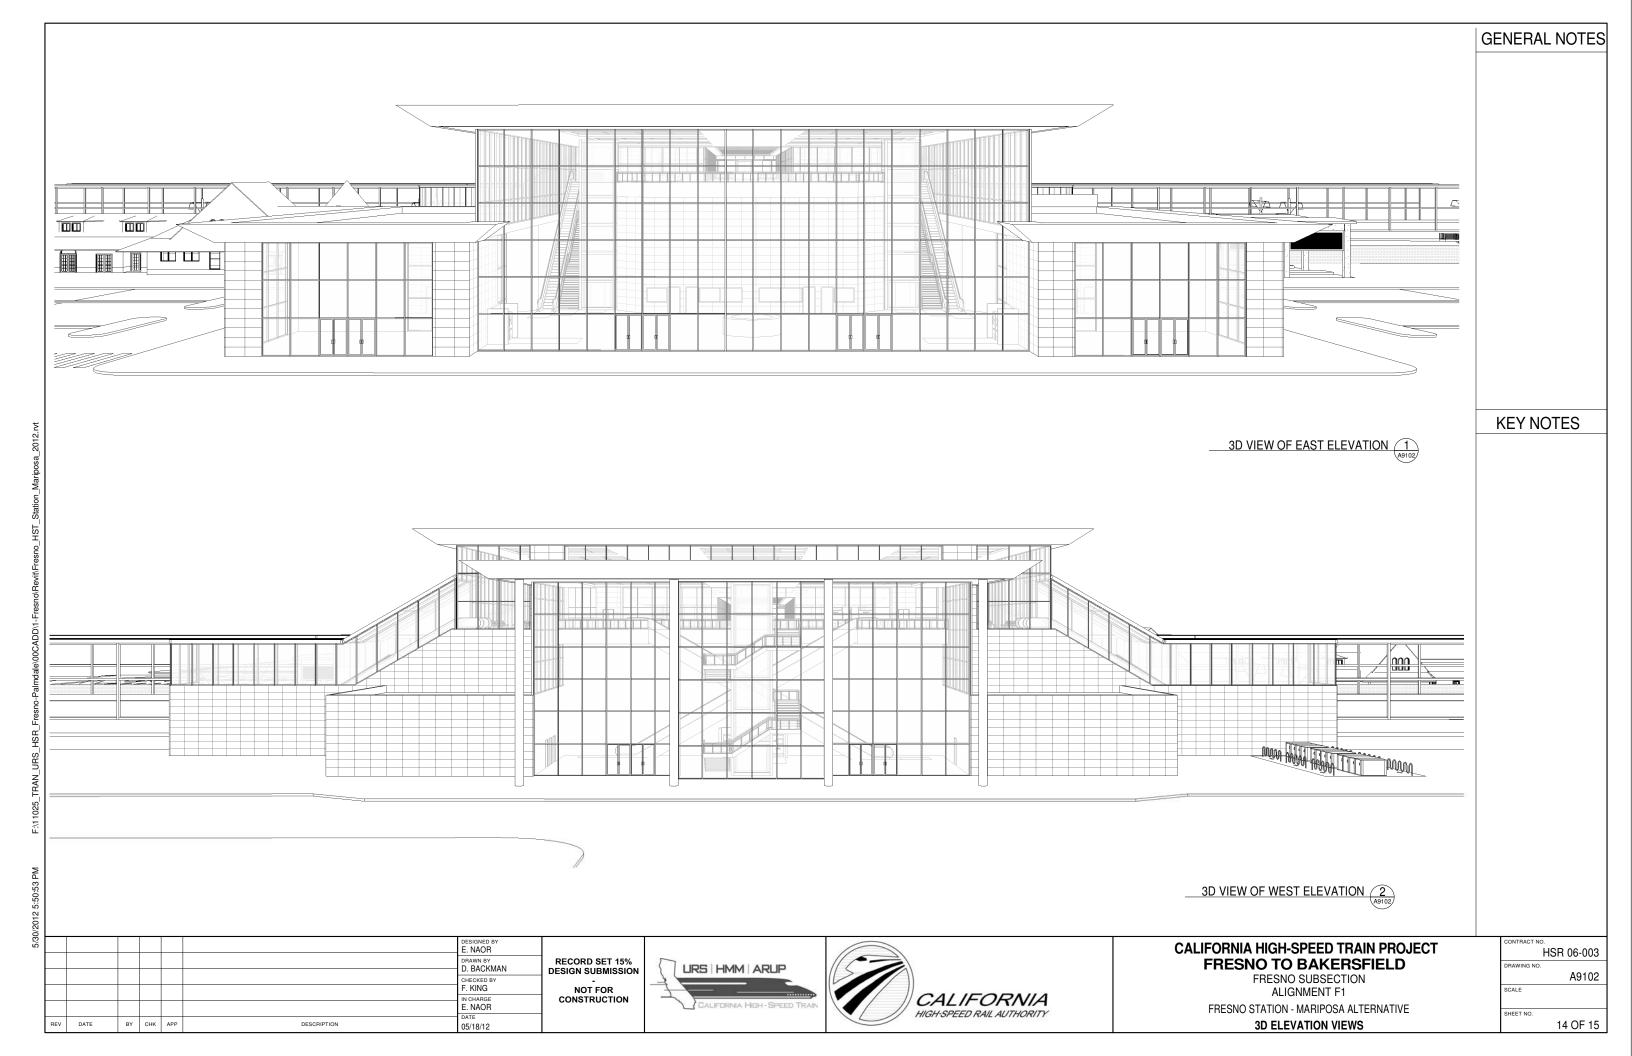


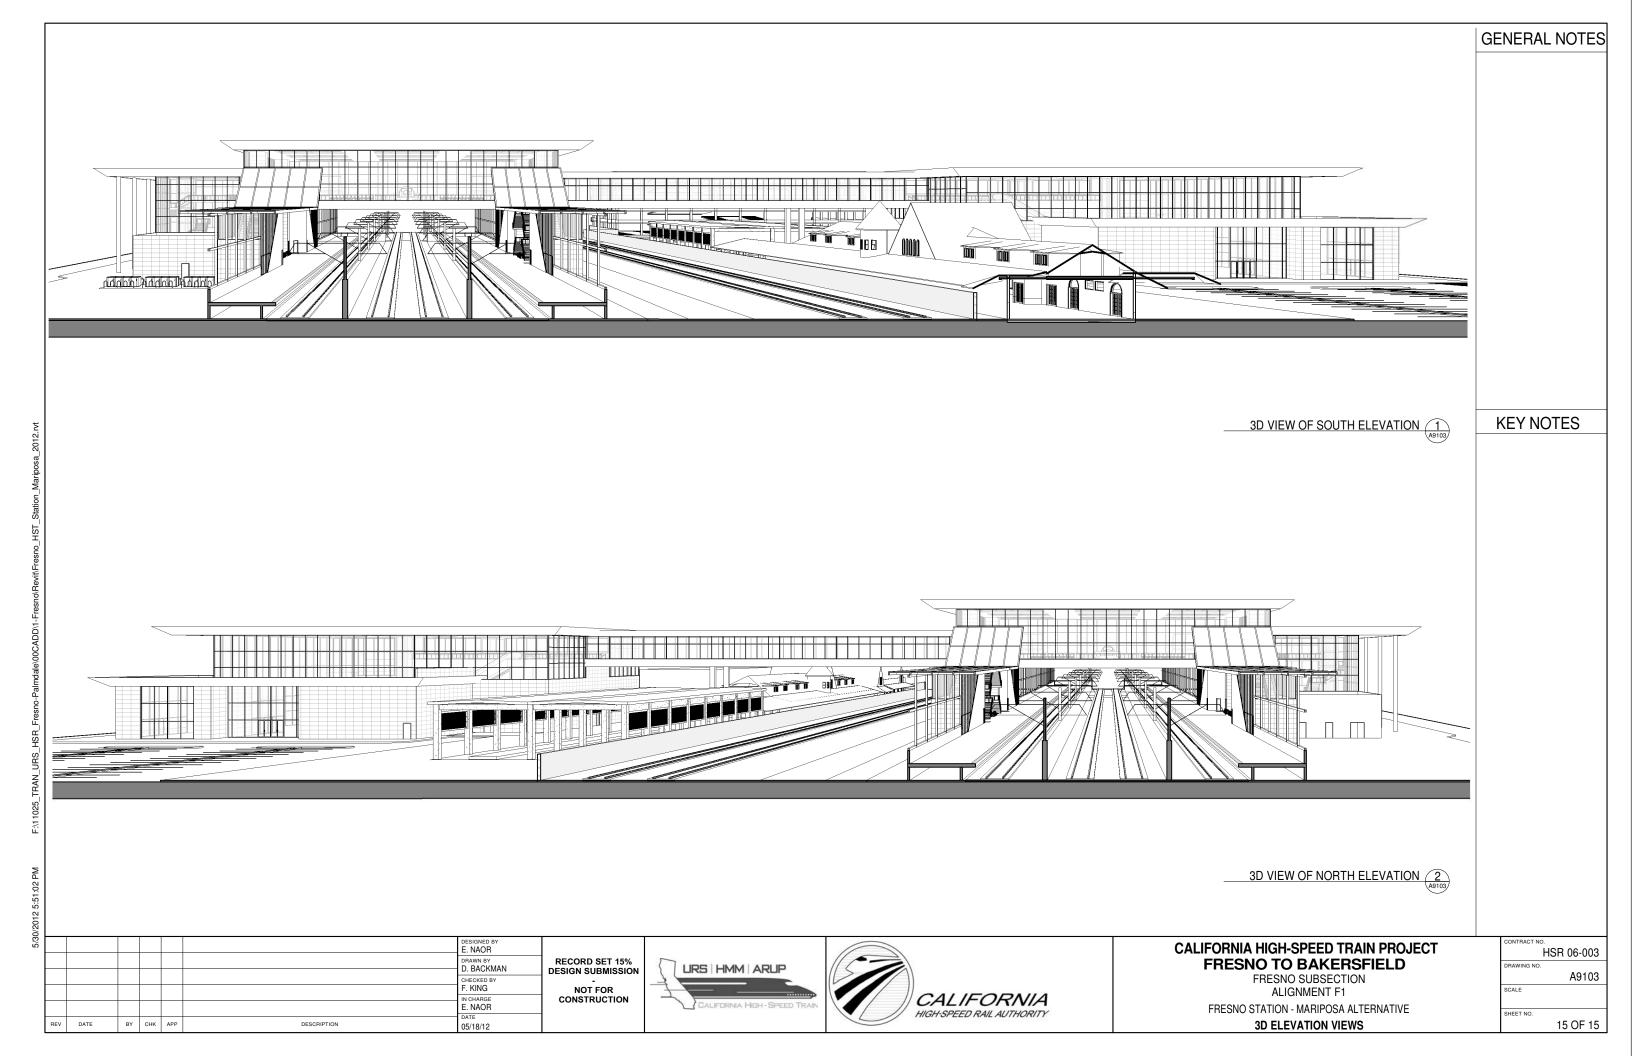


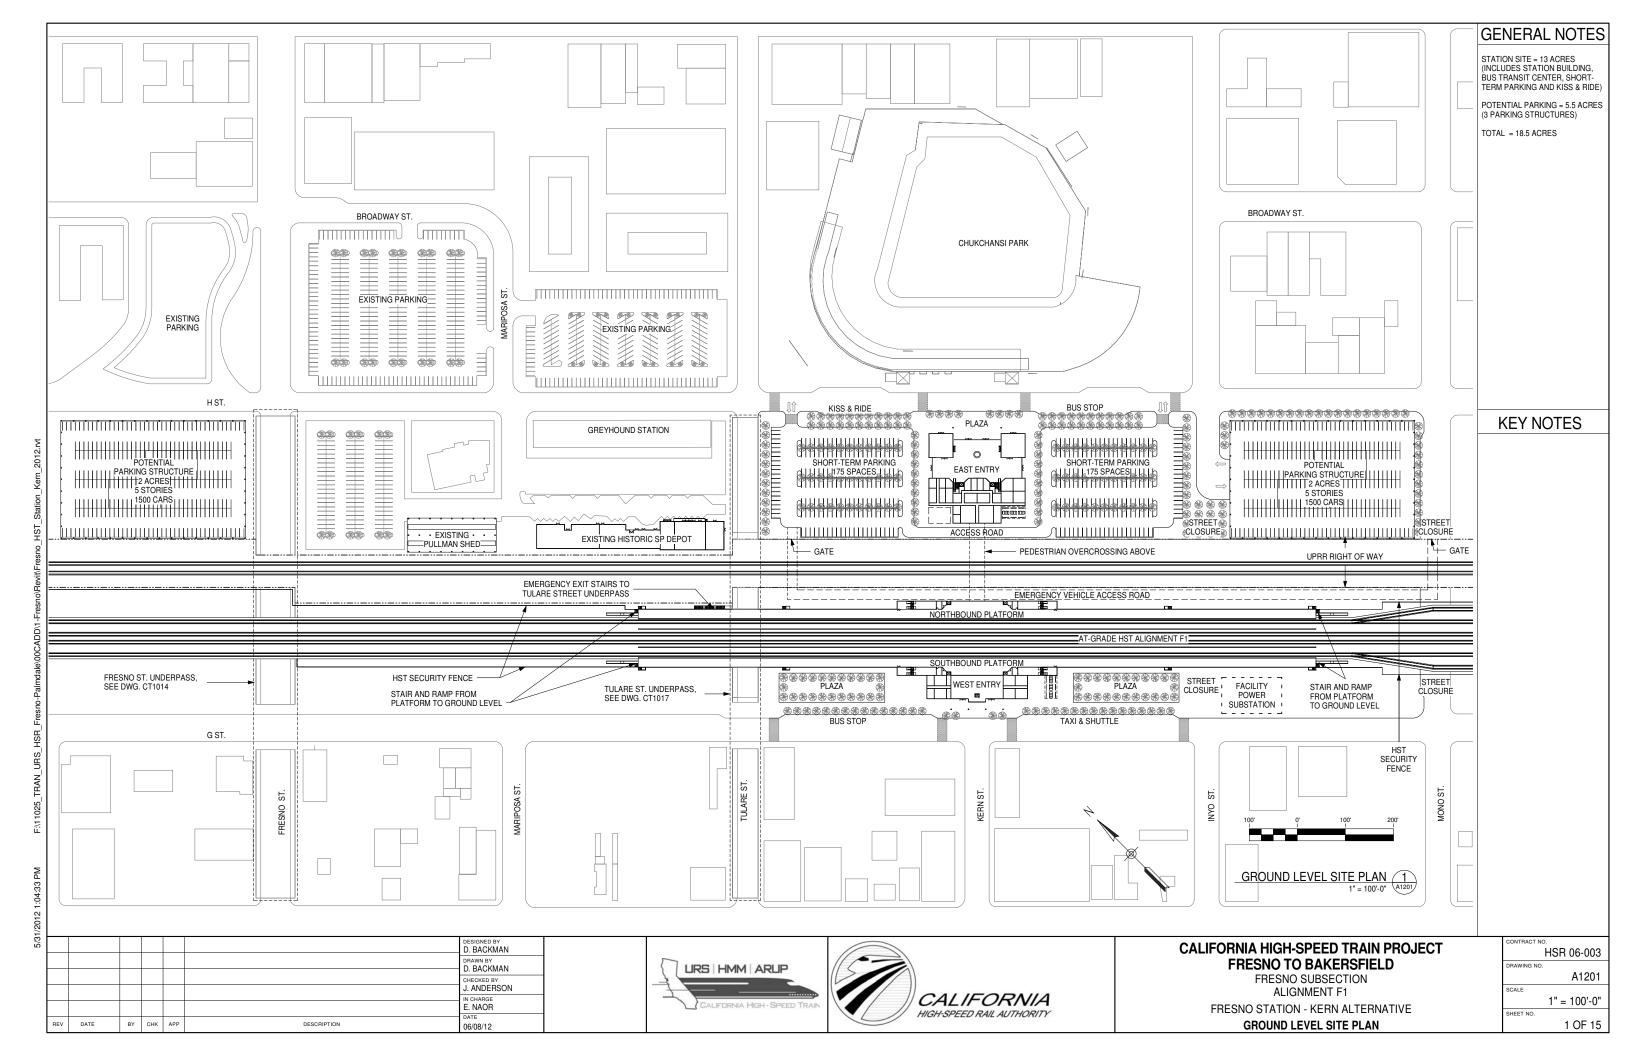


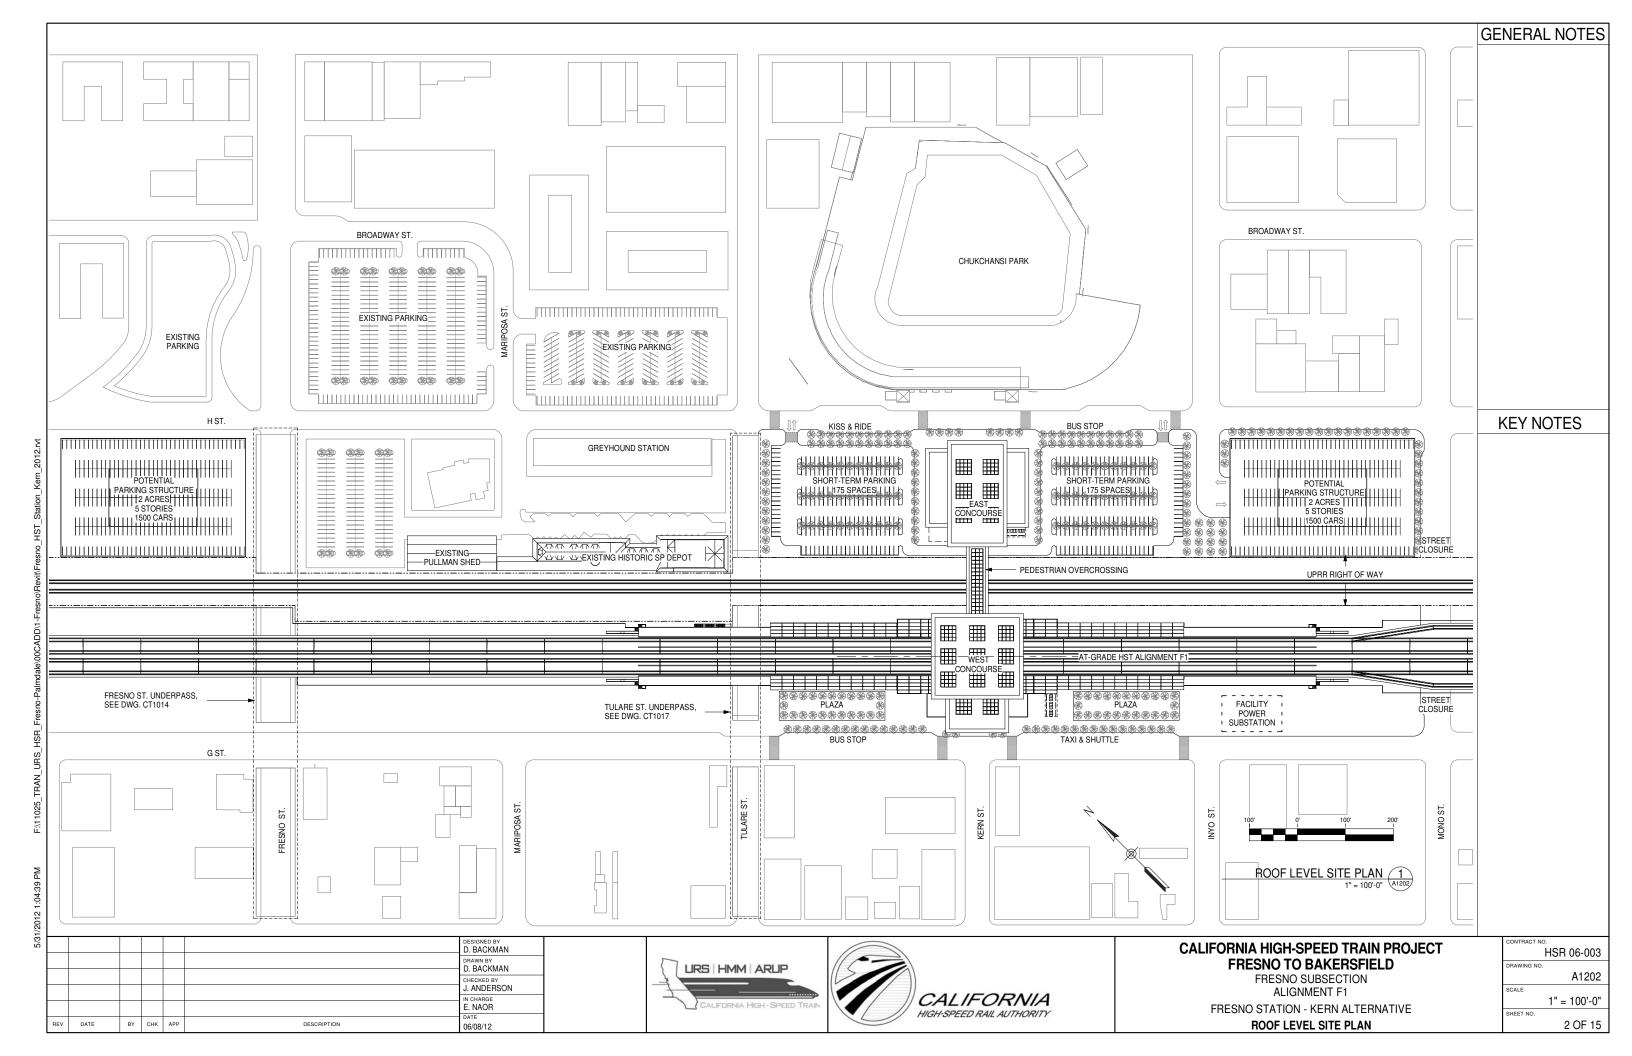


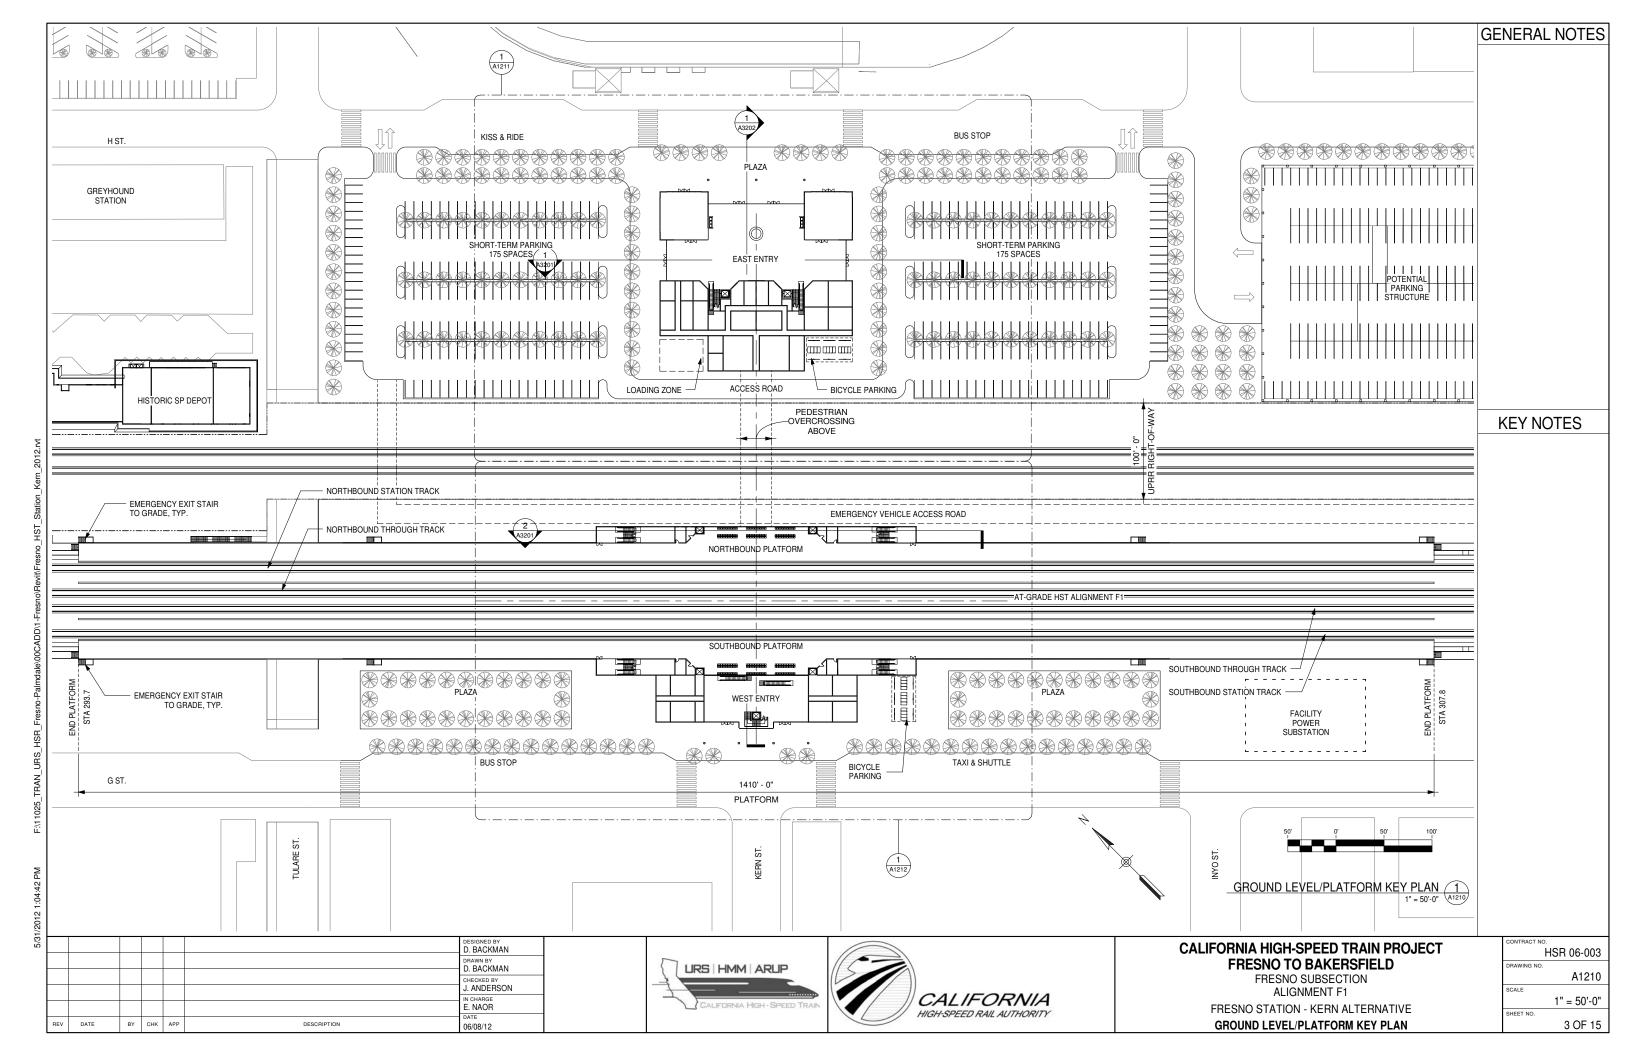


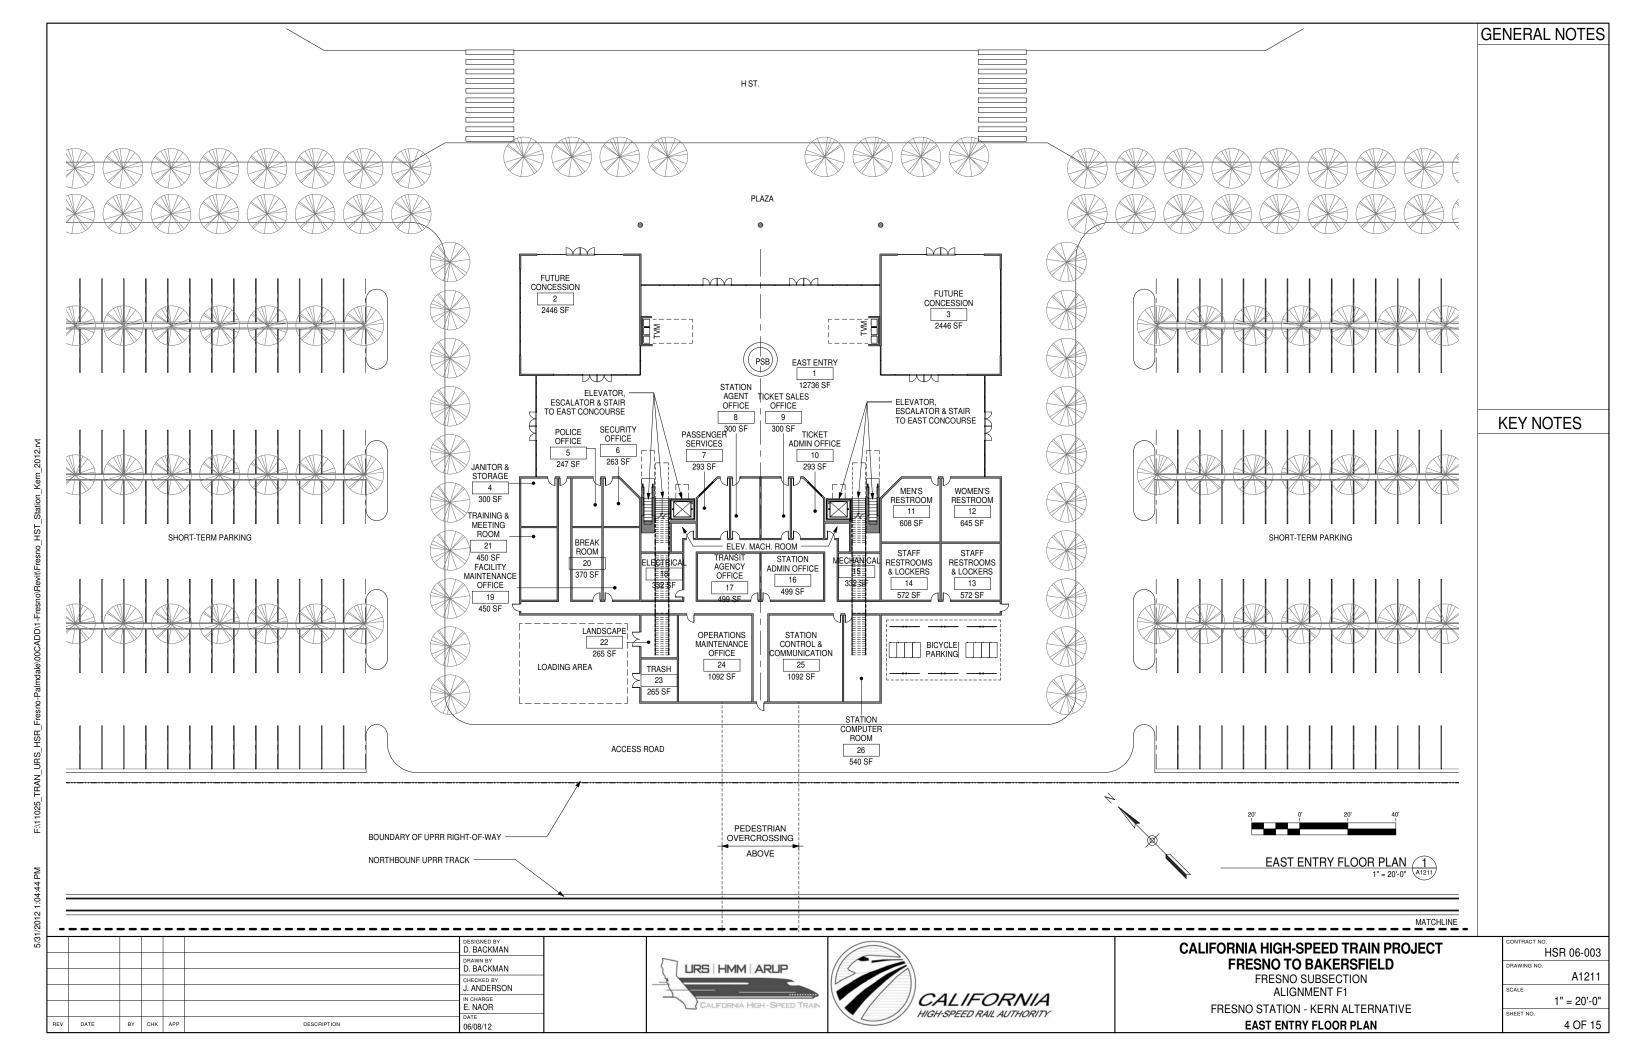


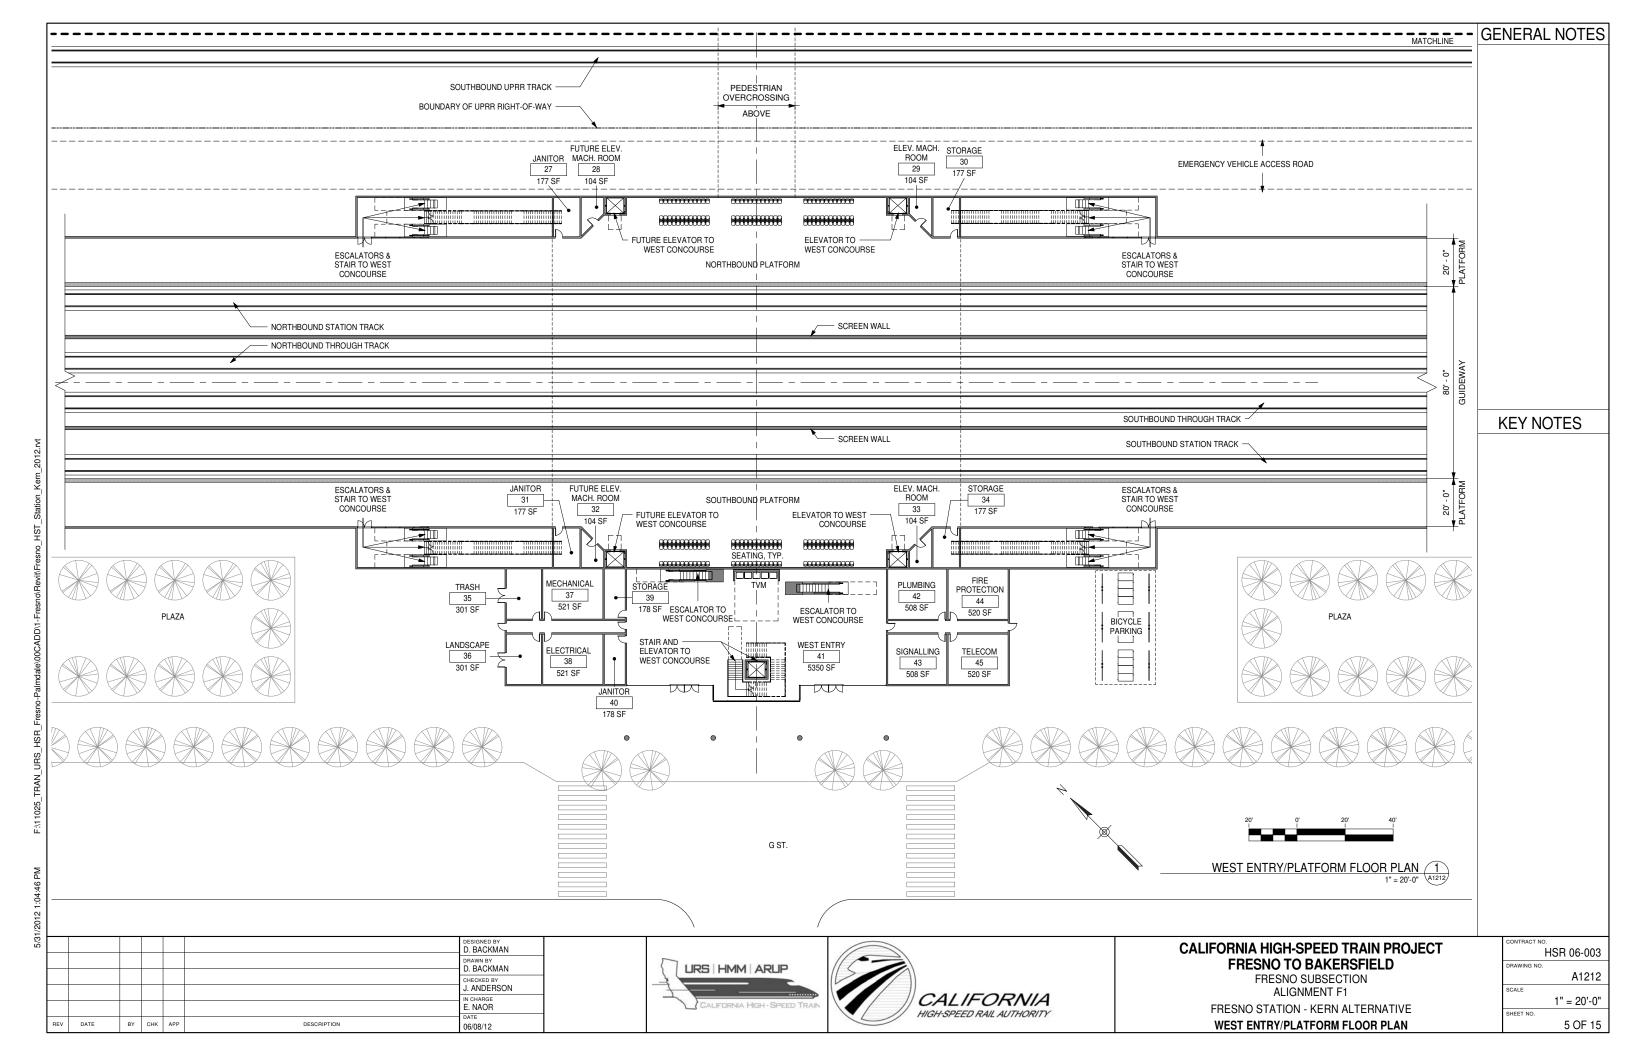


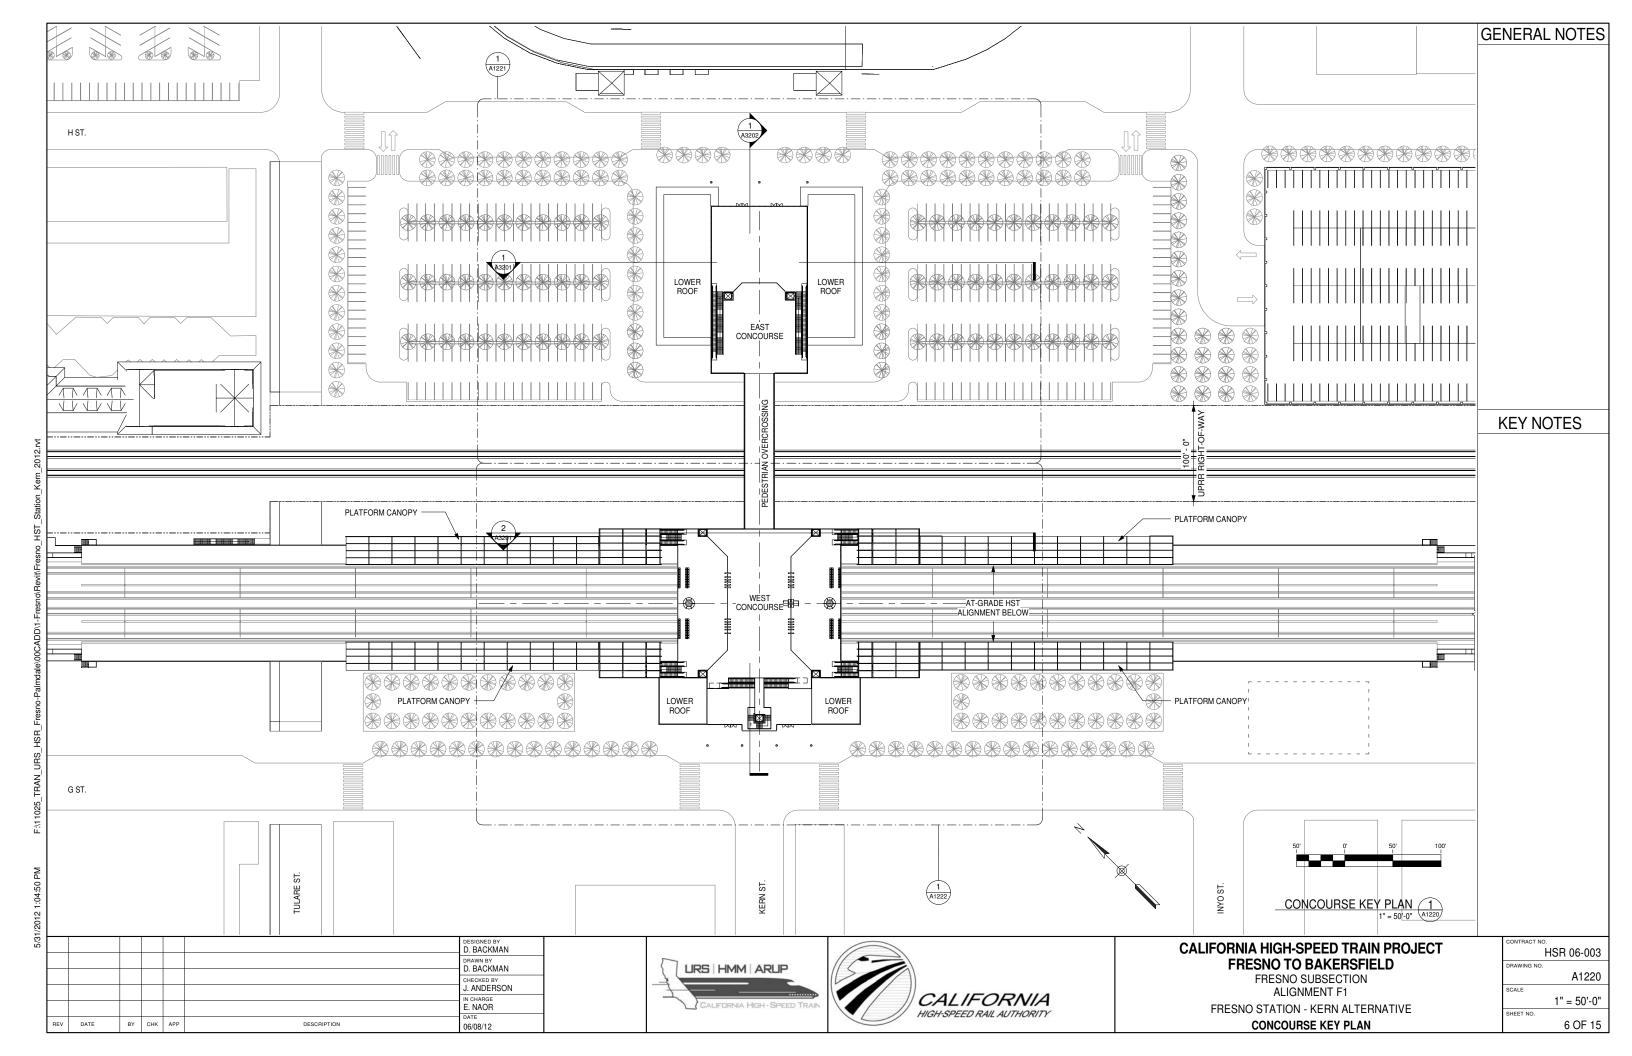


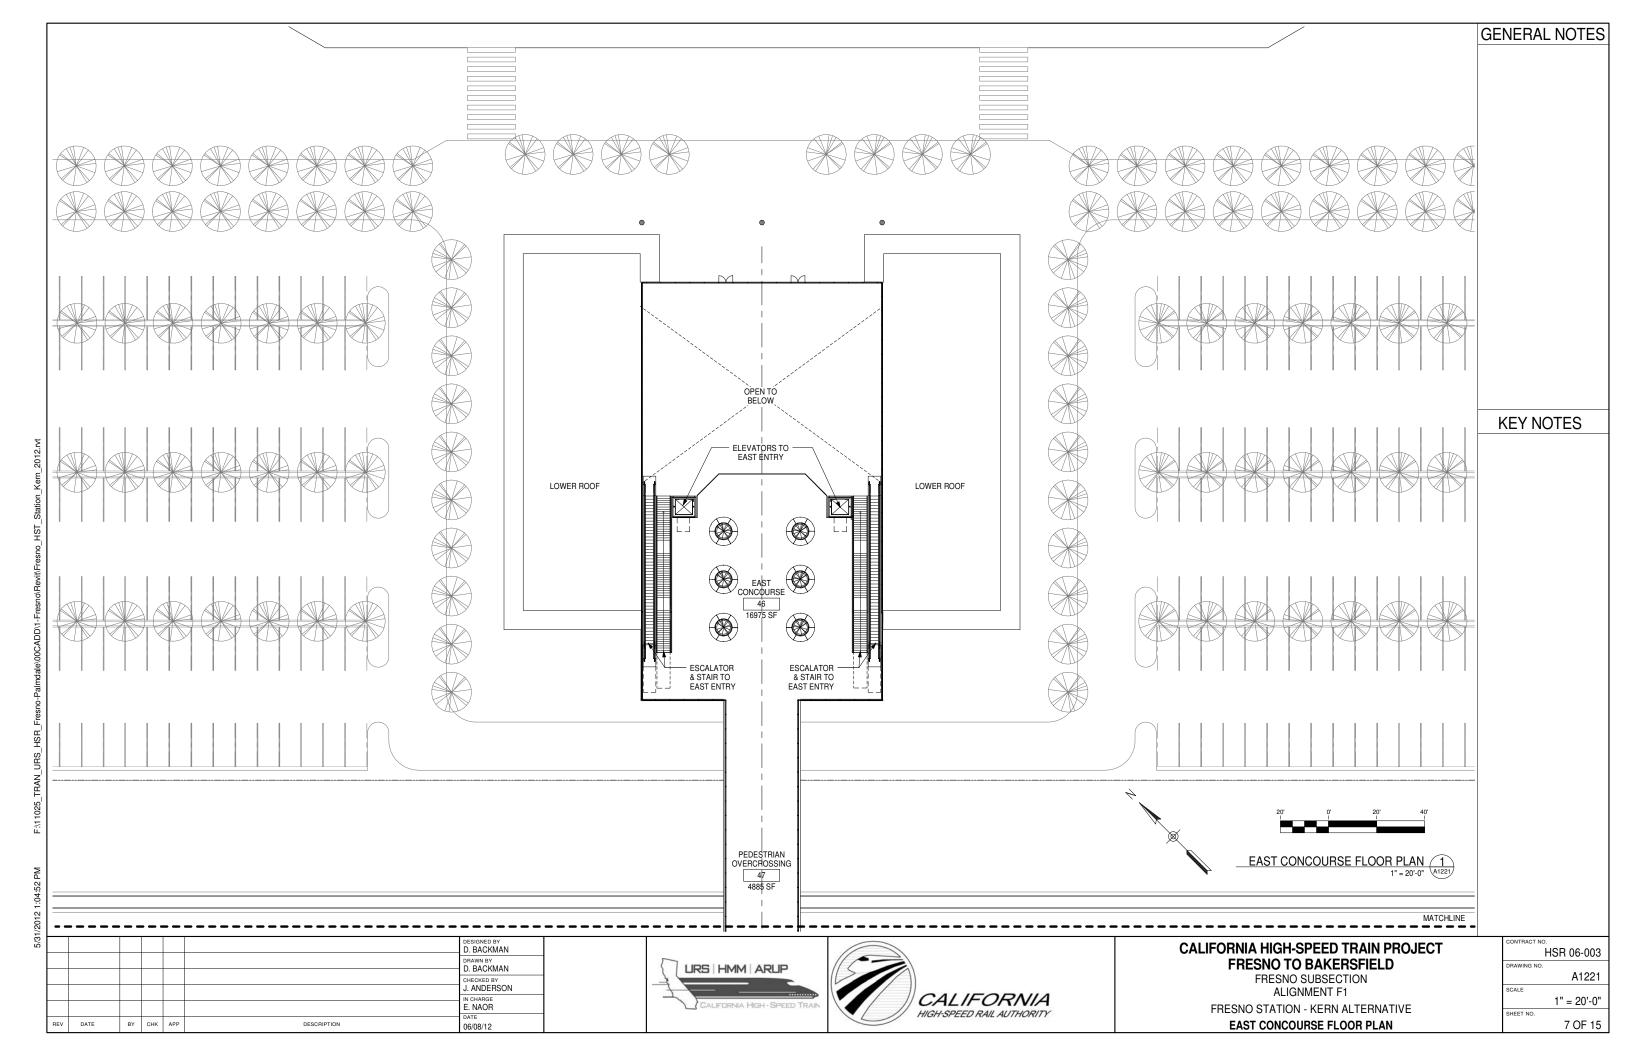

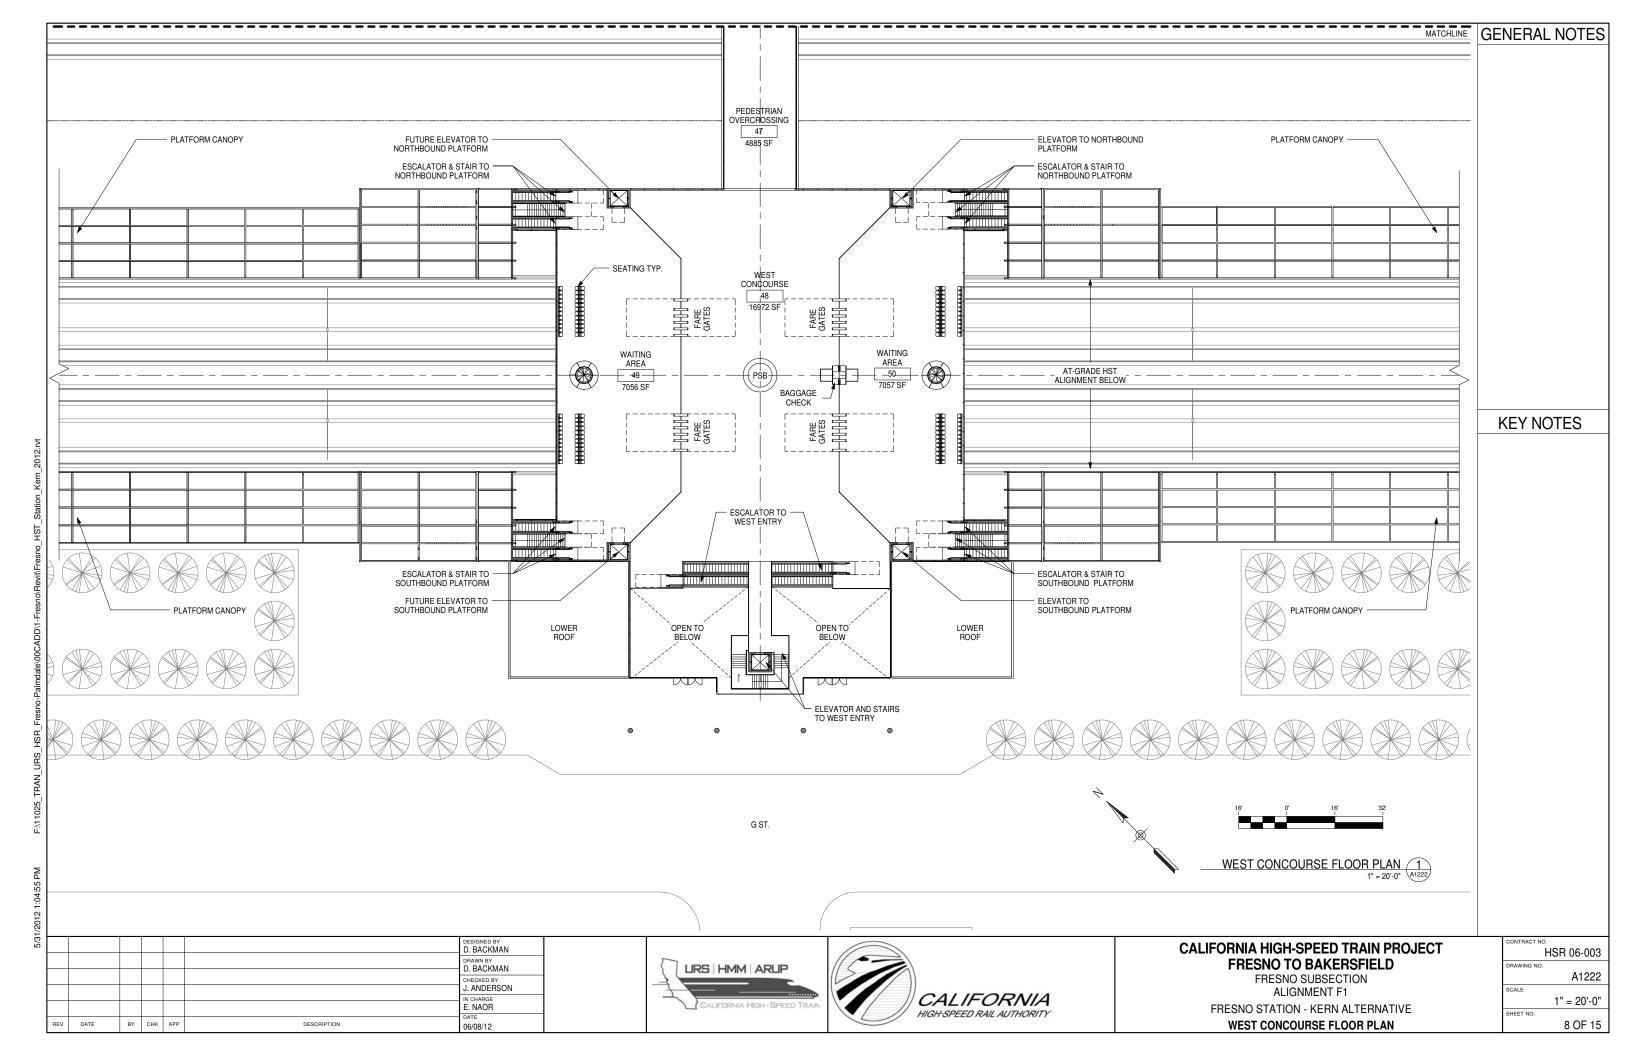

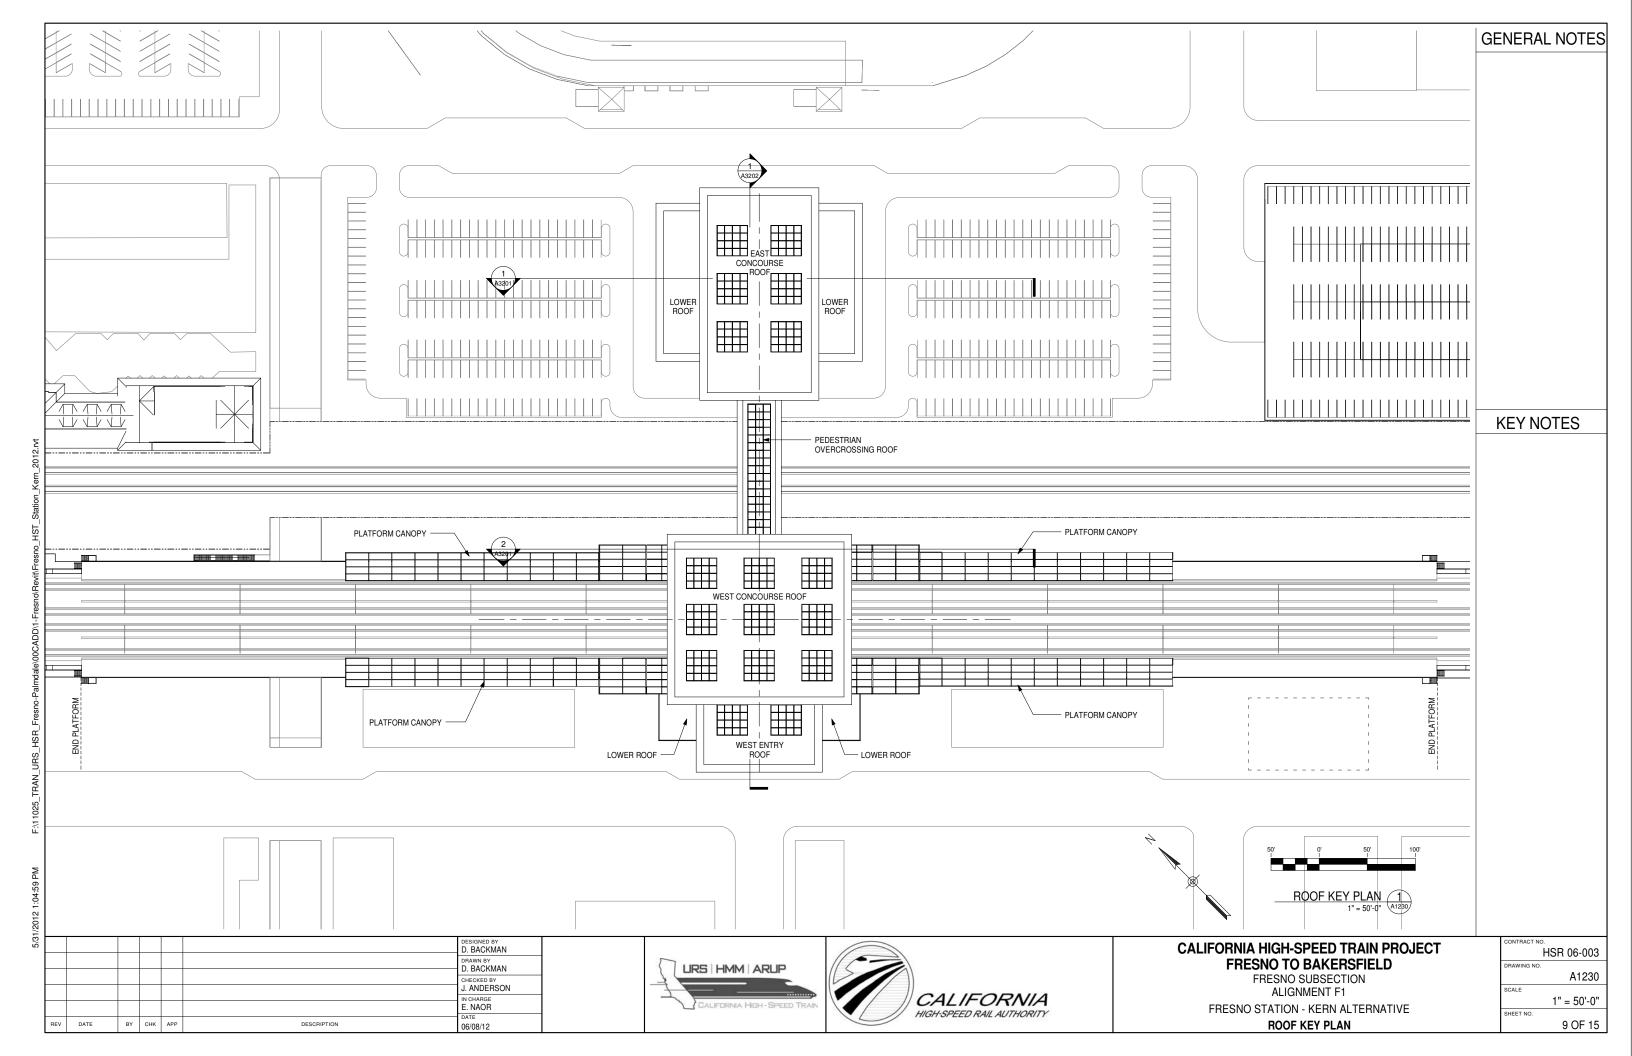

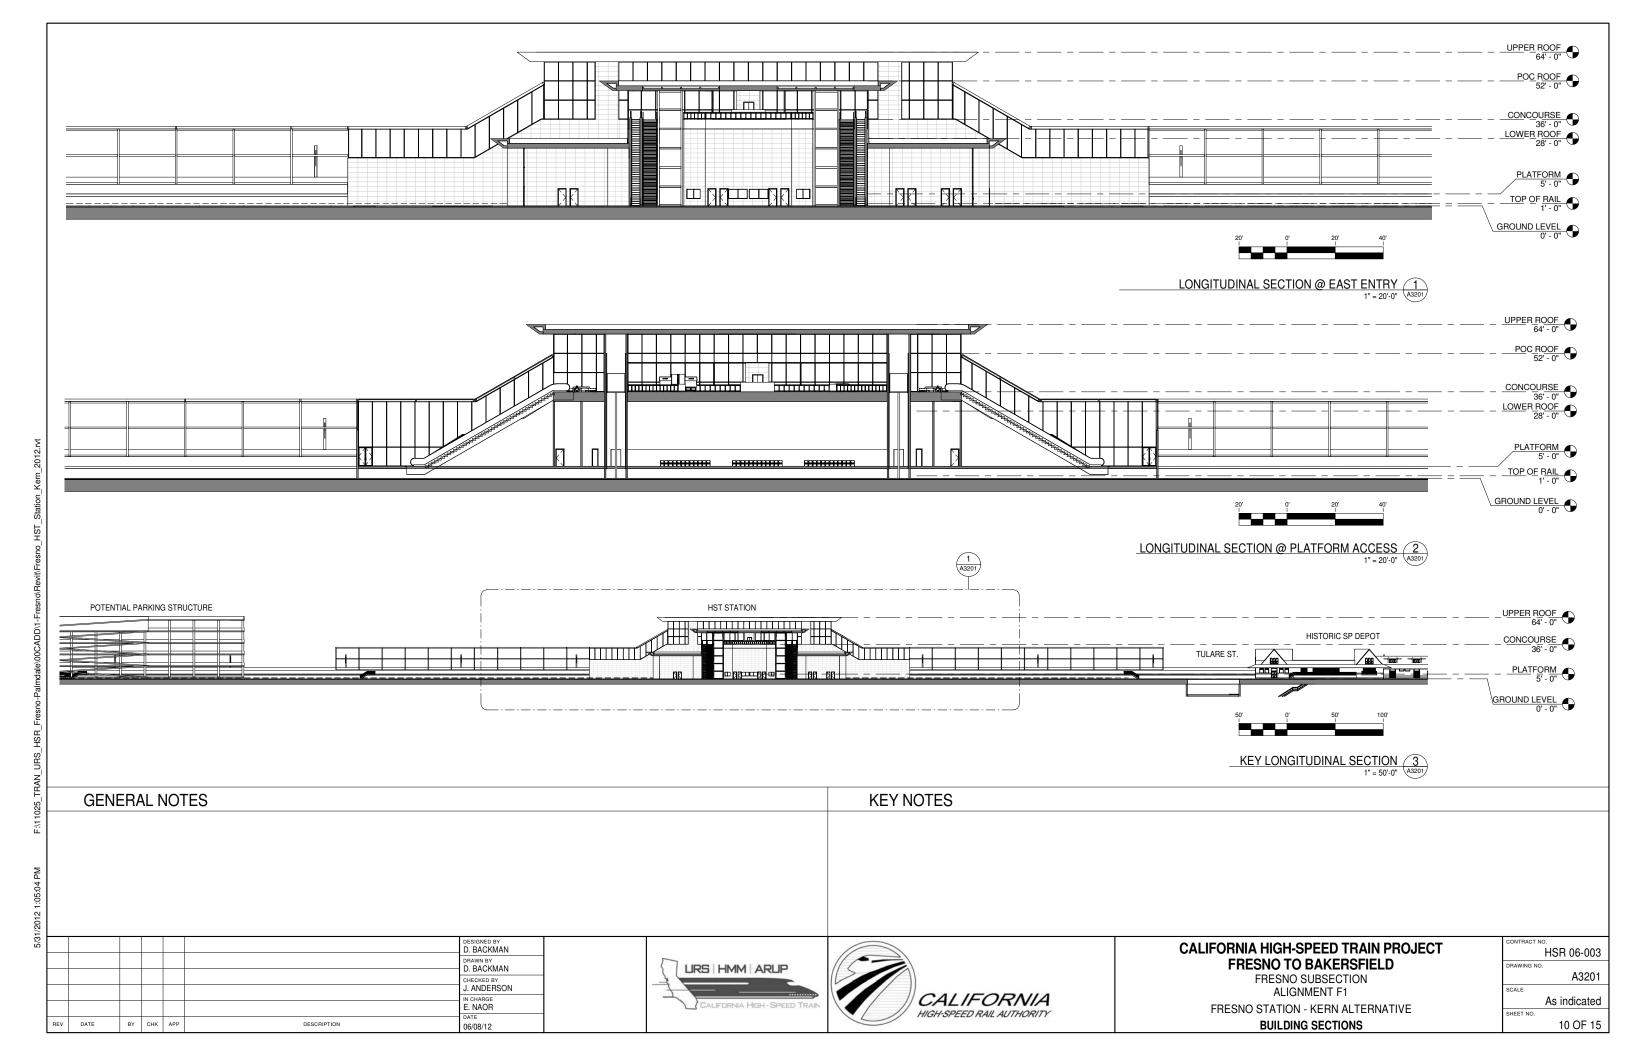

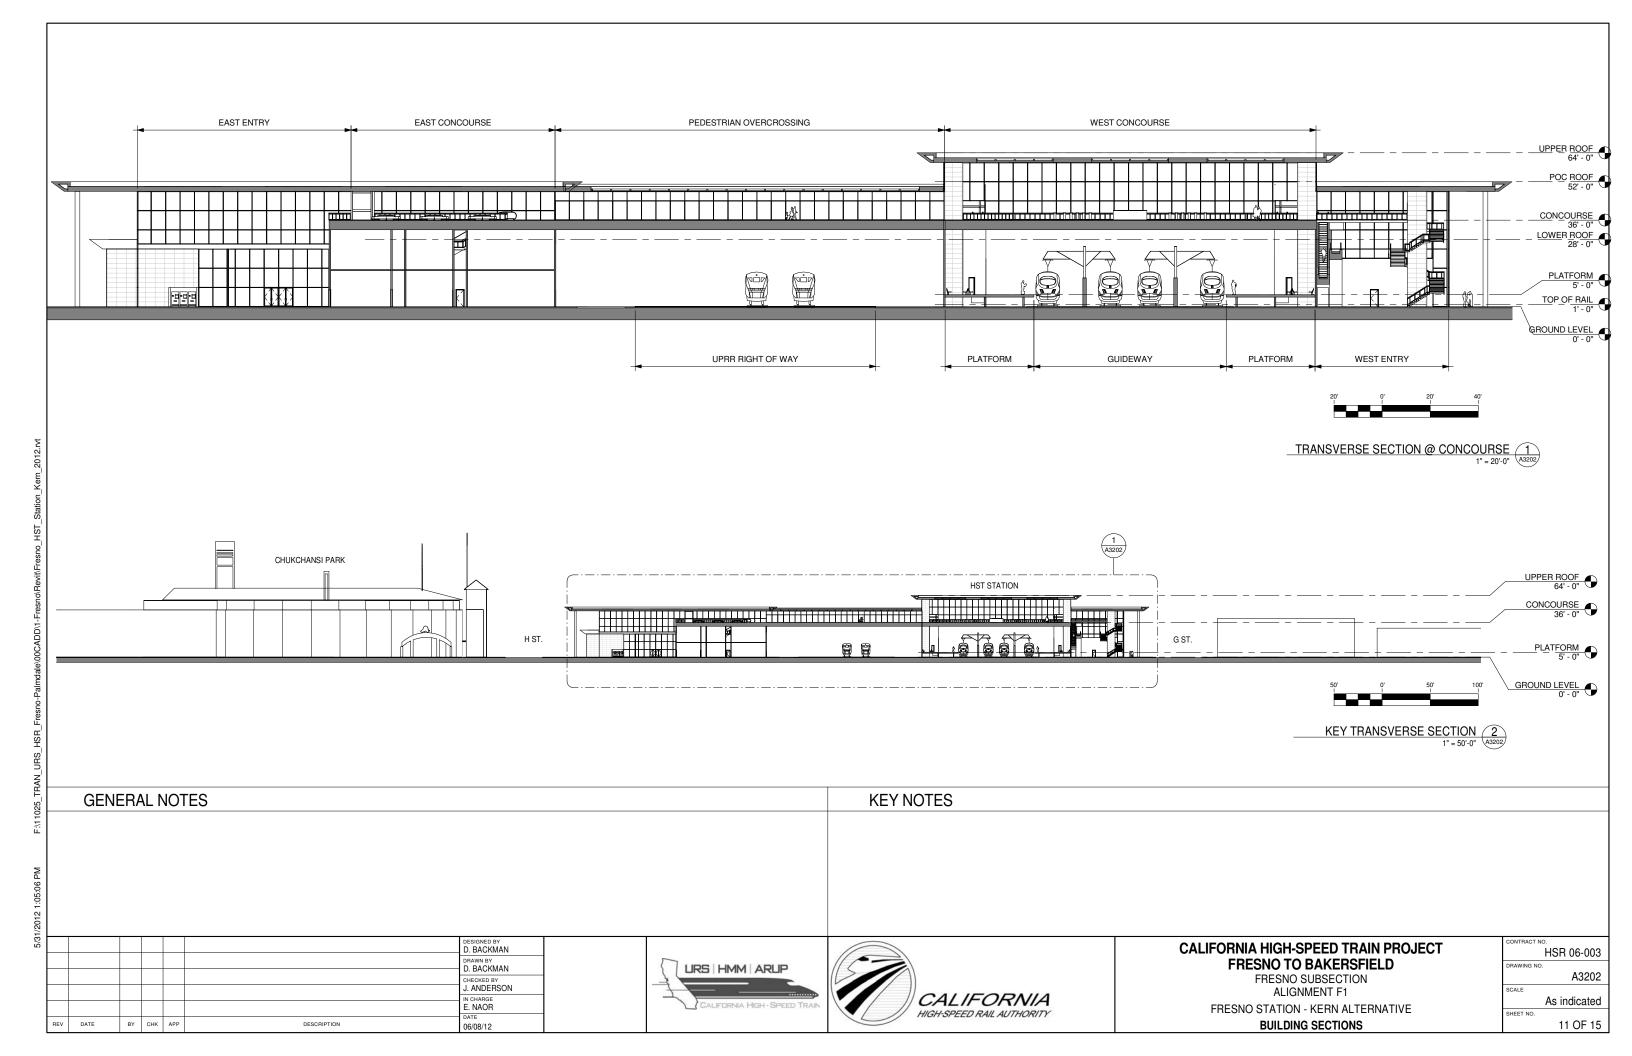

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NO. ROOM NAME	AREA	AREA	FORMULA	TM 2.2.2	COMMENTS
1 EAST ENTRY	12736 SF	11115 SF	P15x30sf/person	6.2.3.2	
2 FUTURE CONCESSION	2446 SF	11113 31	Not specified in Technical Memorandum 2.2.2	6.2.3.6	
3 FUTURE CONCESSION	2446 SF		Not specified in Technical Memorandum 2.2.2	6.2.3.6	
4 JANITOR & STORAGE	300 SF	110 SF	110 SF x 3	6.2.6.2.16	
5 POLICE OFFICE	247 SF	160 SF	160 SF	6.2.6.2.8	
6 SECURITY OFFICE	263 SF	160 SF	160 SF	6.2.6.2.7	
7 PASSENGER SERVICES	293 SF	160 SF	160 SF	6.2.6.1.3	
8 STATION AGENT OFFICE	300 SF	270 SF	270 SF	6.2.6.1.5.	
9 TICKET SALES OFFICE	300 SF	143 SF	(((P60bx.15)/(1.5 x 60)) x 75) sqft	6.2.6.1.1	
10 TICKET ADMIN OFFICE	293 SF	160 SF	160 SF	6.2.6.2.6	
11 MEN'S RESTROOM	608 SF	371 SF	P15	6.2.3.5	
12 WOMEN'S RESTROOM	645 SF	371 SF	P15	6.2.3.5	
13 STAFF RESTROOMS & LOCKERS	572 SF		Local Codes	6.2.6.12/13	
14 STAFF RESTROOMS & LOCKERS	572 SF		Local Codes	6.2.6.12/13	
15 MECHANICAL	332 SF		TBD	6.4.6	
16 STATION ADMIN OFFICE	499 SF		((65sqft x staff with own workspace) + (43sqft x staff with shared workspace))x1.25	6.2.6.2.1	
17 TRANSIT AGENCY OFFICE	499 SF		Based on Demand	6.2.6.11	
18 ELECTRICAL	332 SF		TBD	6.4.2	
19 FACILITY MAINTENANCE OFFICE	450 SF	325 SF	325 SF	6.2.6.2.9	
20 BREAK ROOM	370 SF	125 SF	(20sqft x .25 x max staff per shift x 1.25)	6.2.6.2.14	
21 TRAINING & MEETING ROOM	450 SF	500 SF	(20sqft x max staff per shift x 1.25)	6.2.6.2.2	
22 LANDSCAPE	265 SF	000 01	TBD	6.2.6.2.18	
23 TRASH	265 SF	54 SF	54 SF	6.2.6.2.15	
24 OPERATIONS MAINTENANCE OFFICE	1092 SF	1080 SF	1080 SF	6.2.6.2.10	
25 STATION CONTROL & COMMUNICATION	1092 SF	1080 SF	1080 SF	6.2.6.2.3	
26 STATION CONTROL & COMMINIONICATION  26 STATION COMPUTER ROOM	540 SF	525 SF	525.00 SF	6.2.6.2.4	
	177 SF	110 SF	110 SF	6.2.6.2.16	
28 FUTURE ELEV. MACH. ROOM	104 SF		TBD	6.2.5.2.4	
29 ELEV. MACH. ROOM	104 SF		TBD	6.2.5.2.4	
30 STORAGE	177 SF	130 SF	130 SF	6.2.6.2.17	
31 JANITOR	177 SF	110 SF	110 SF	6.2.6.2.16	
32 FUTURE ELEV. MACH. ROOM	104 SF		TBD	6.2.5.2.4	
33 ELEV. MACH. ROOM	104 SF		TBD	6.2.5.2.4	
34 STORAGE	177 SF	130 SF	130 SF	6.2.6.2.17	
35 TRASH	301 SF	54 SF	54 SF	6.2.6.2.15	
36 LANDSCAPE	301 SF		TBD	6.2.6.2.18	
37 MECHANICAL	521 SF		TBD	6.4.6	
38 ELECTRICAL	521 SF		TBD	6.4.2	
39 STORAGE	178 SF		TBD	6.2.6.2.17	
40 JANITOR	178 SF	110 SF	110 SF	6.2.6.2.16	
41 WEST ENTRY	5350 SF		P15x30sf/person	6.2.3.2	
42 PLUMBING	508 SF		TBD	6.4.3	
43 SIGNALLING	508 SF		TBD	6.4.7	
44 FIRE PROTECTION	520 SF		TBD	6.4.4	
45 TELECOM	520 SF		TBD	6.4.7	
46 EAST CONCOURSE	16975 SF		TBD	6.2.3.2	
47 PEDESTRIAN OVERCROSSING	4885 SF		TBD	6.2.3.2	
48 WEST CONCOURSE	16972 SF	11117 SF	P15x30sqft	6.2.4.1	
49 WAITING AREA	7056 SF	5187 SF	P15x14sqft or Pbmax x 10sqft or Pbmax x 10sqft	6.2.4.2	
	7057 SF	5187 SF		6.2.4.2	
50 WAITING AREA	1001 00	010/ SF	P15x14sqft or Pbmax x 10sqft or Pbmax x 10sqft	0.2.4.2	

						DESIGNED BY D. BACKMAN	
						DRAWN BY D. BACKMAN	1
						CHECKED BY J. ANDERSON	1
						IN CHARGE E. NAOR	1
REV	DATE	BY	СНК	APP	DESCRIPTION	06/08/12	







#### CALIFORNIA HIGH-SPEED TRAIN PROJECT FRESNO TO BAKERSFIELD


FRESNO SUBSECTION ALIGNMENT F1 FRESNO STATION - KERN ALTERNATIVE

ROOM SCHEDULE

CONTRACT NO	).
	HSR 06-003
DRAWING NO.	
	A6201
SCALE	
SHEET NO.	
	12 OF 15

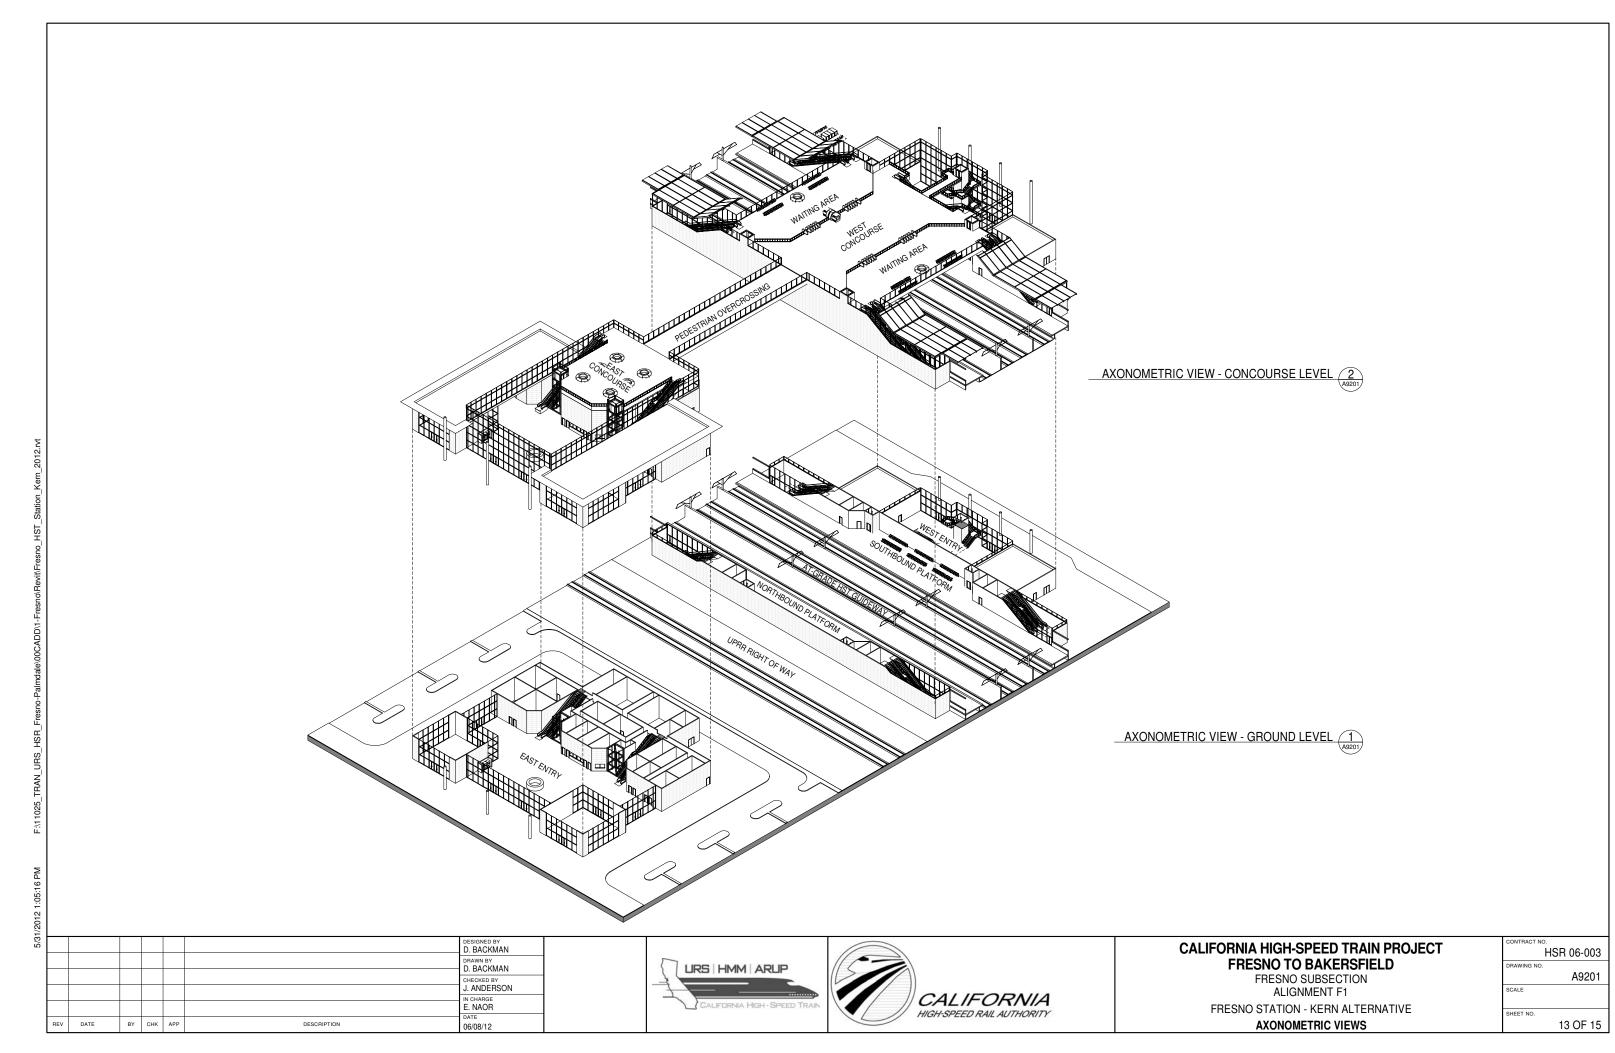

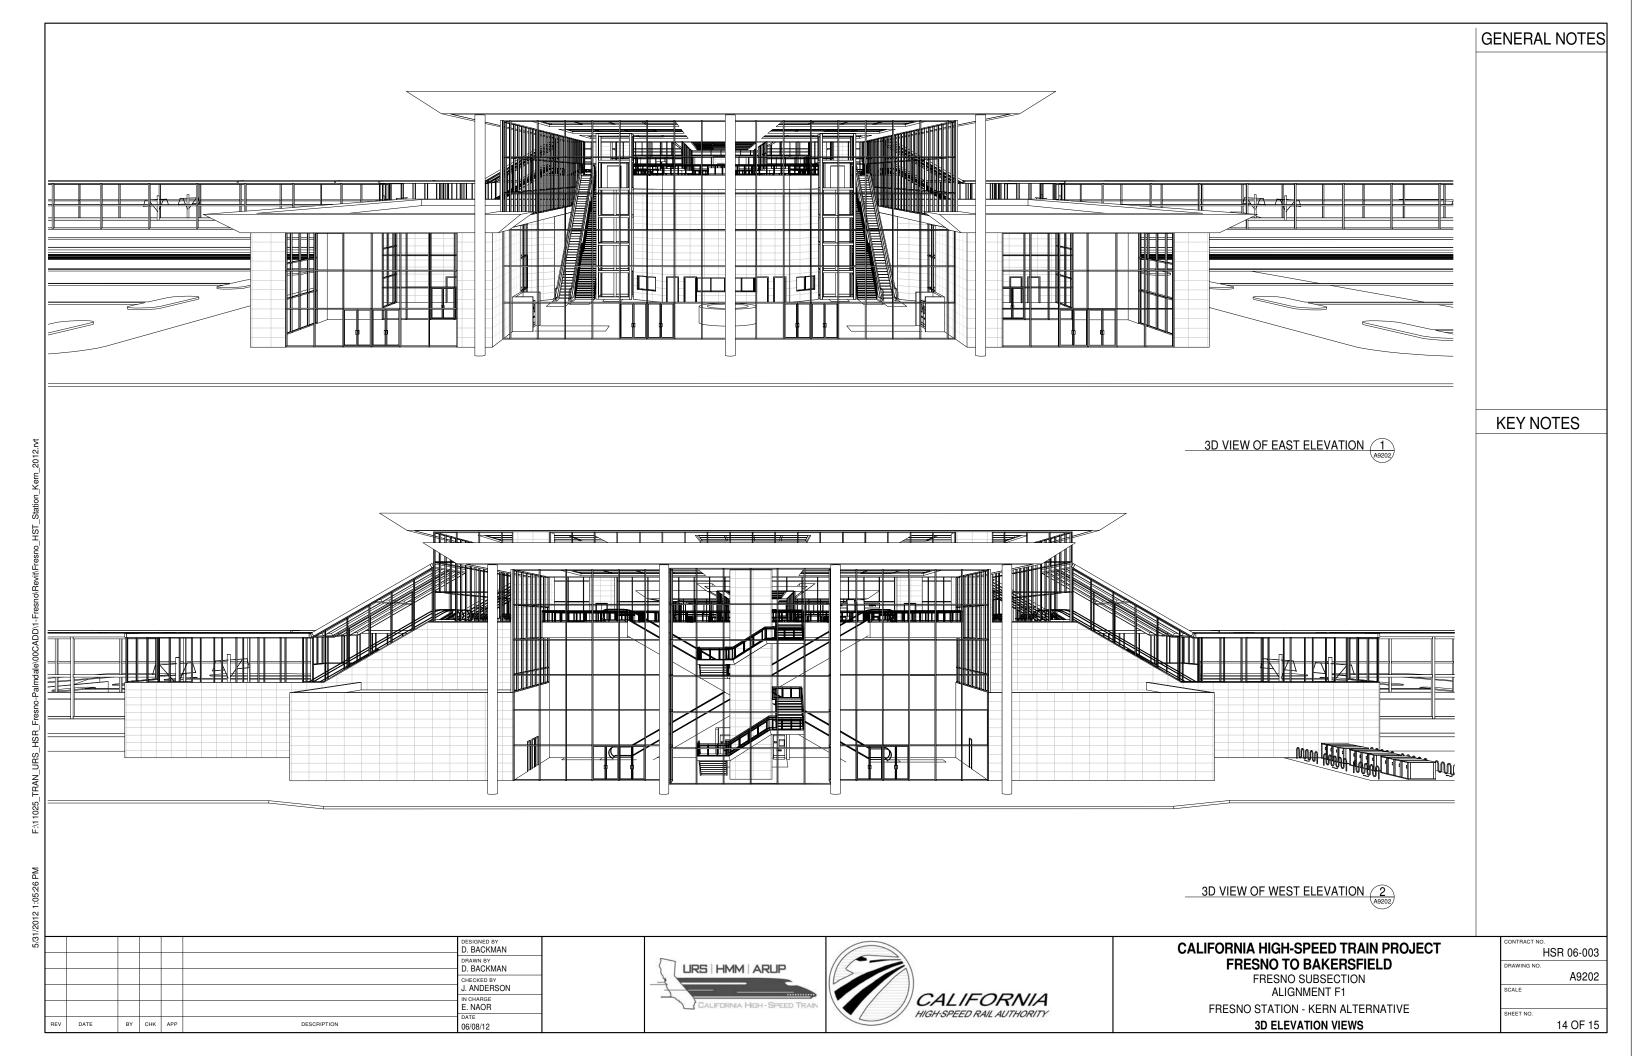

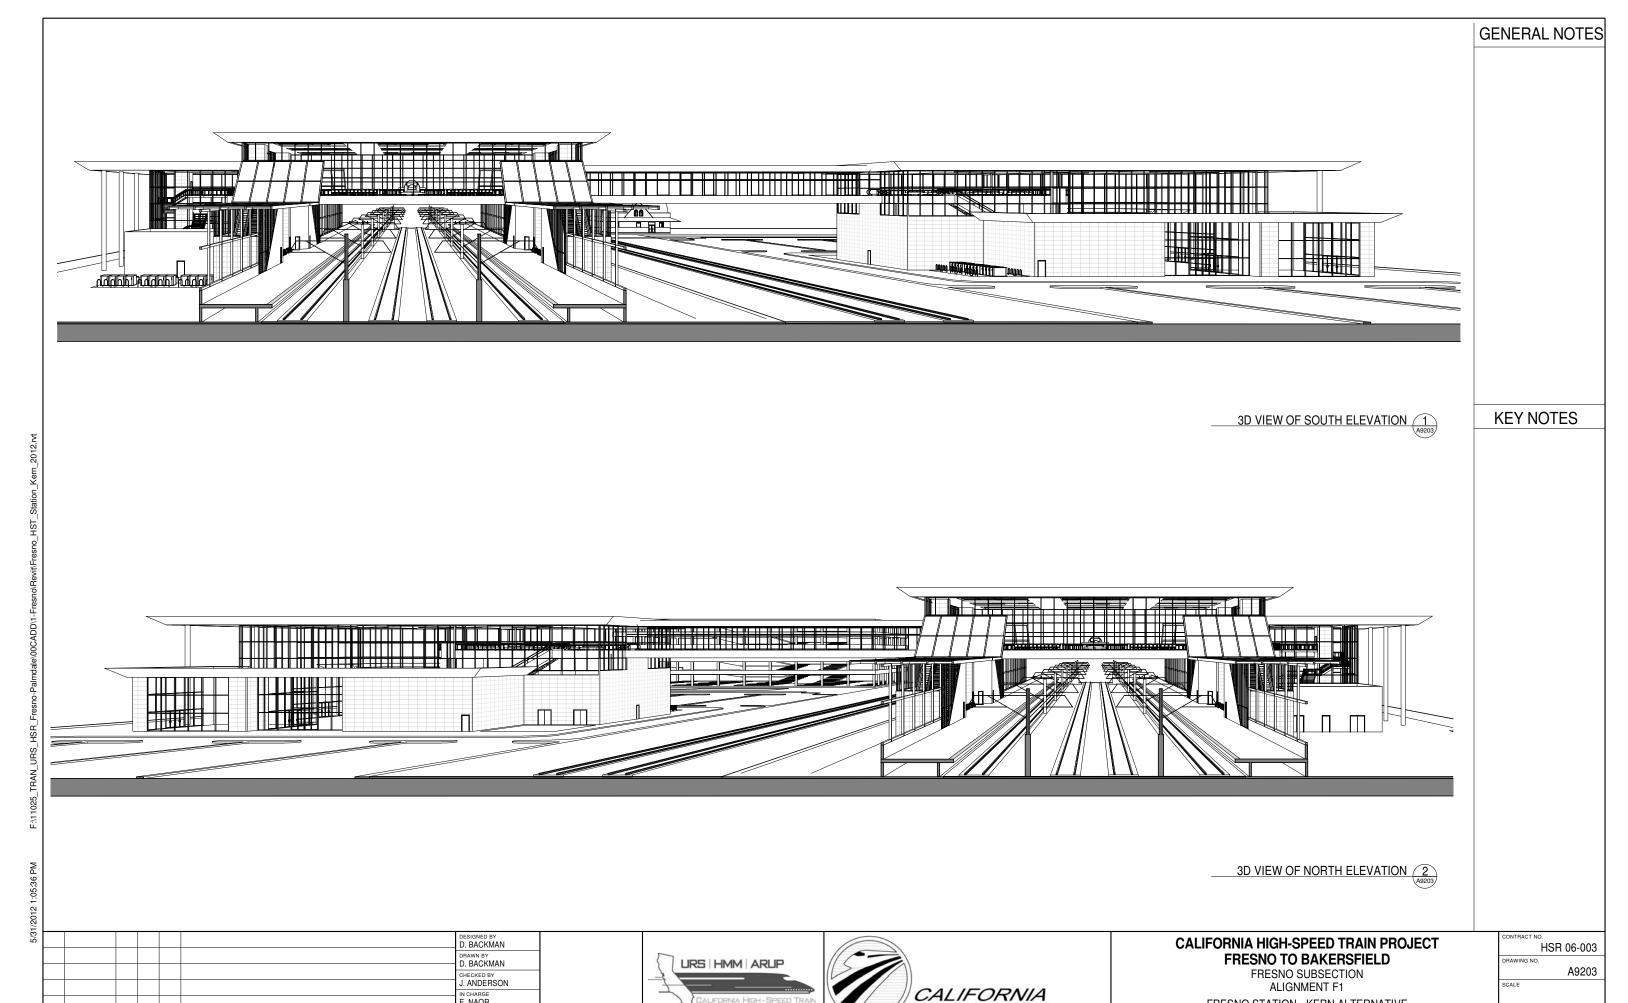

HIGH-SPEED RAIL AUTHORITY

E. NAOR

DATE 06/08/12

DESCRIPTION

BY CHK APP

FRESNO STATION - KERN ALTERNATIVE

3D ELEVATION VIEWS

15 OF 15



CHECKED BY F. KING IN CHARGE E. NAOR DATE 06/08/12 DESCRIPTION

NOT FOR CONSTRUCTION








HANFORD SUBSECTION ALIGNMENT H


KINGS / TULARE REGIONAL STATION - EAST ALTERNATIVE ROOF LEVEL SITE PLAN


CONTRACT NO	),
Н	ISR 06-0003
DRAWING NO.	
	A1301
SCALE	
	1" = 200'-0"
SHEET NO.	
	1 OE 12

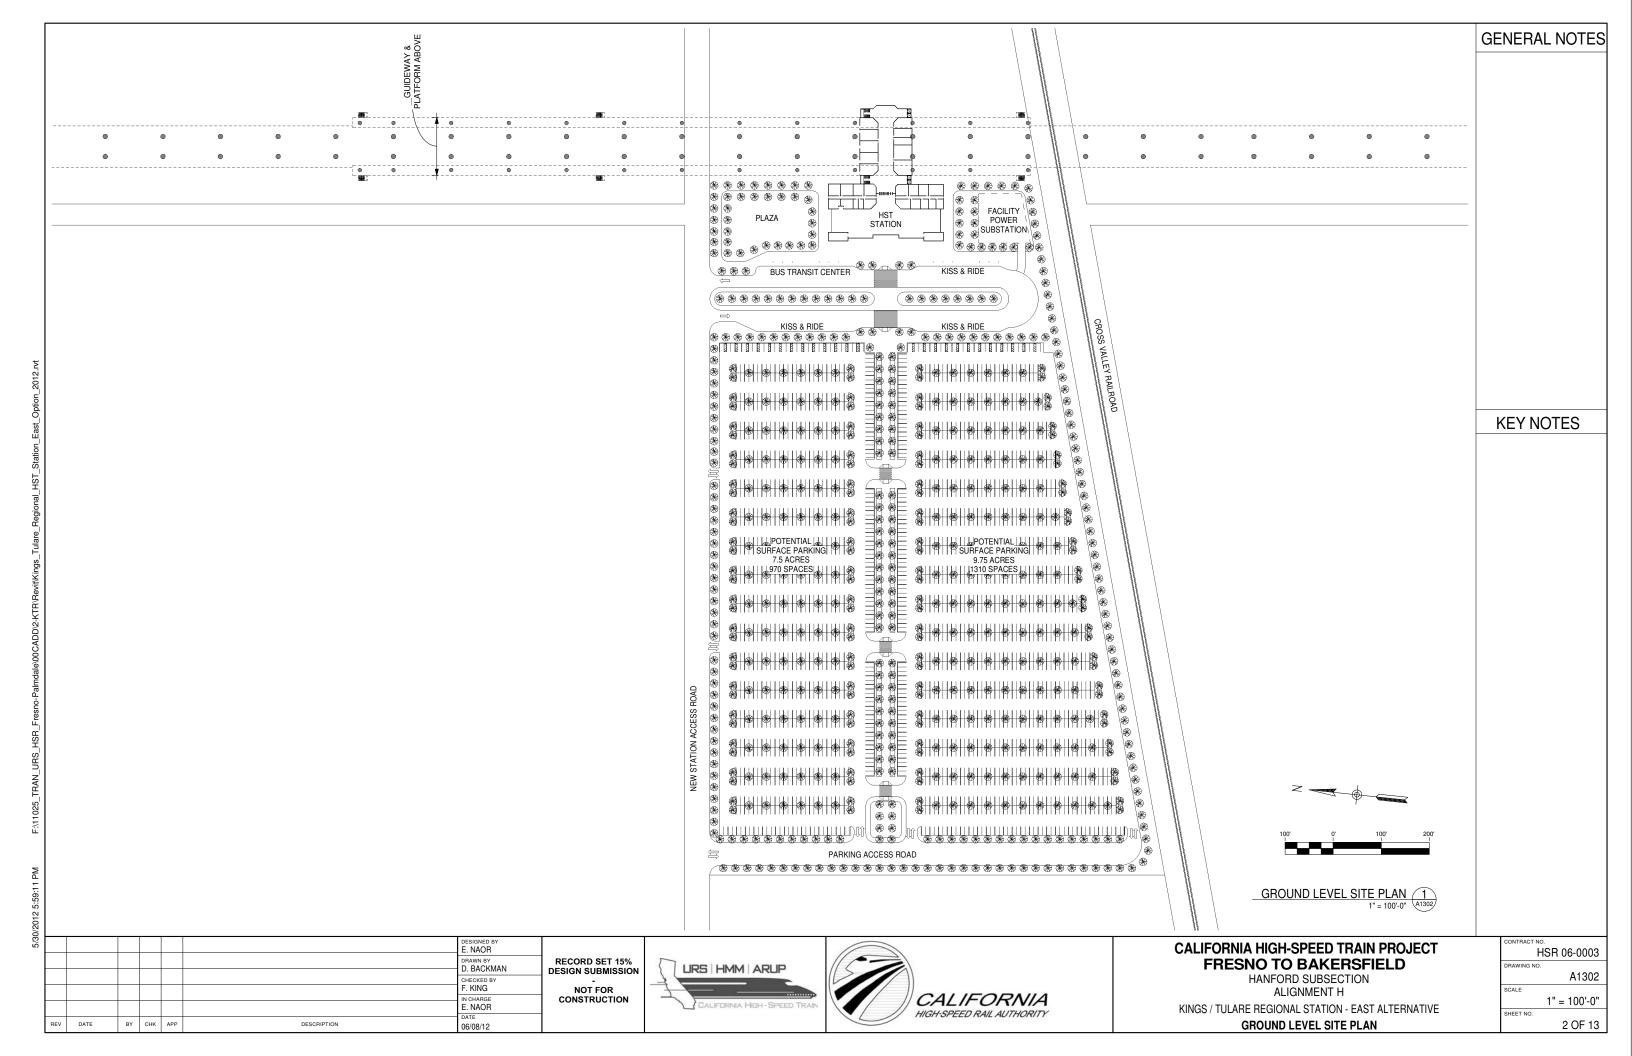


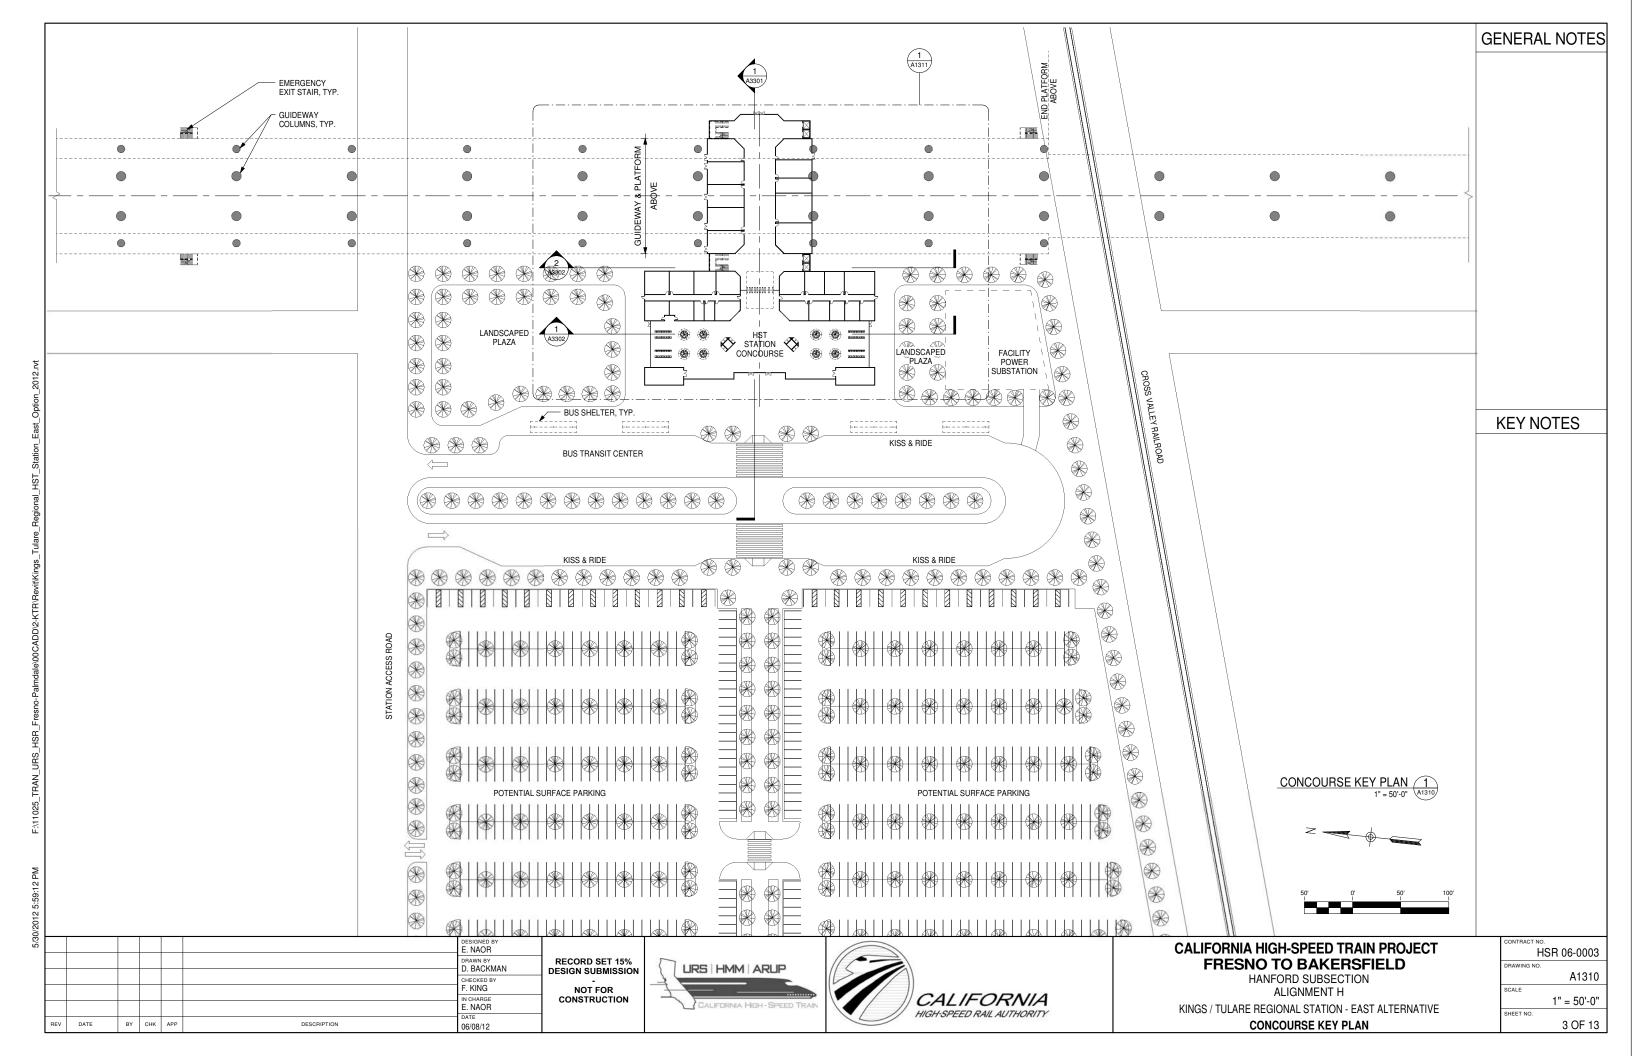


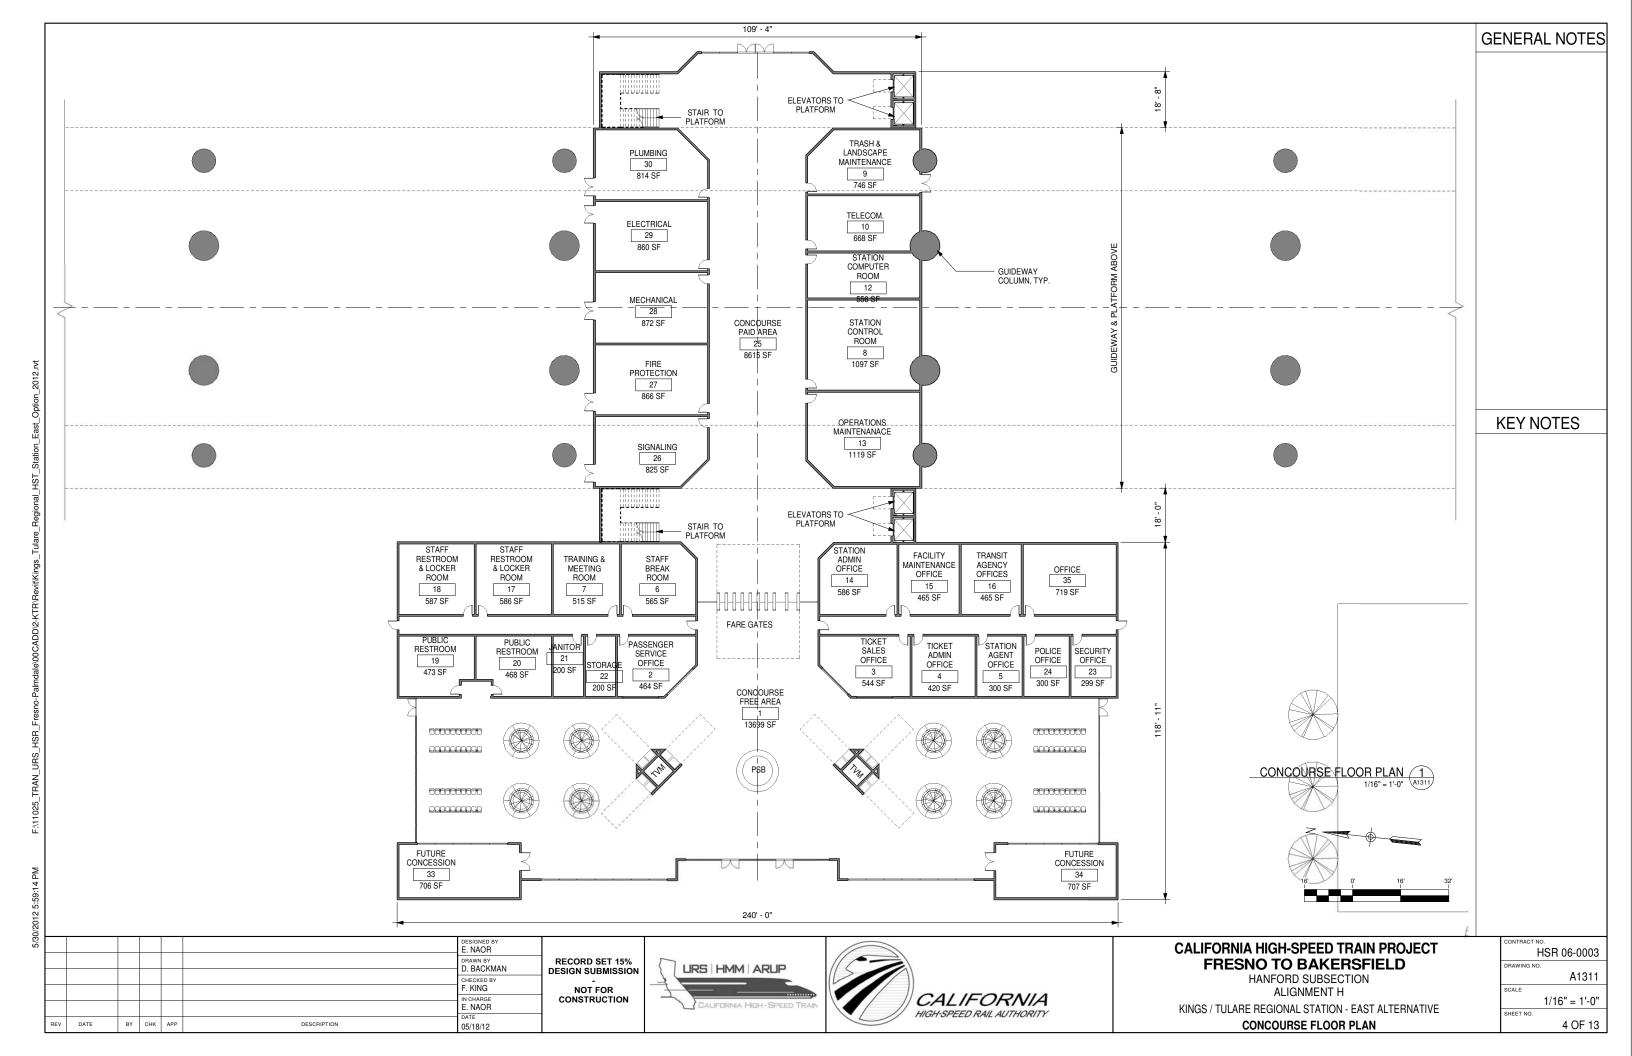


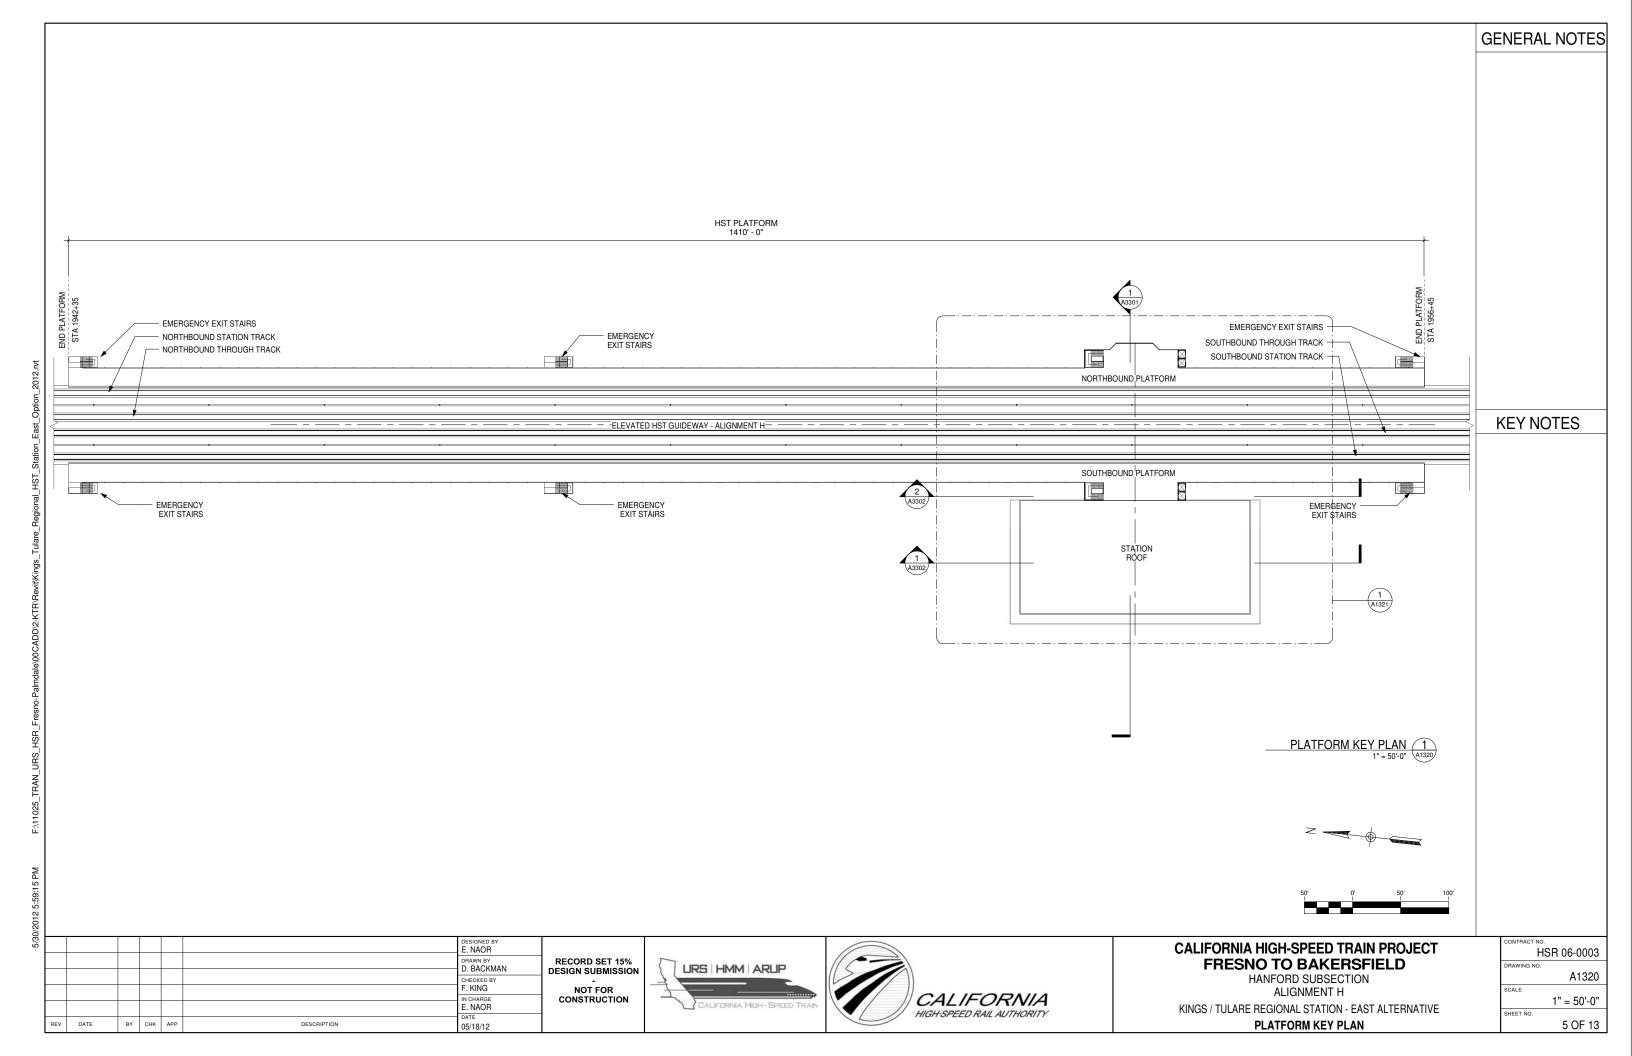

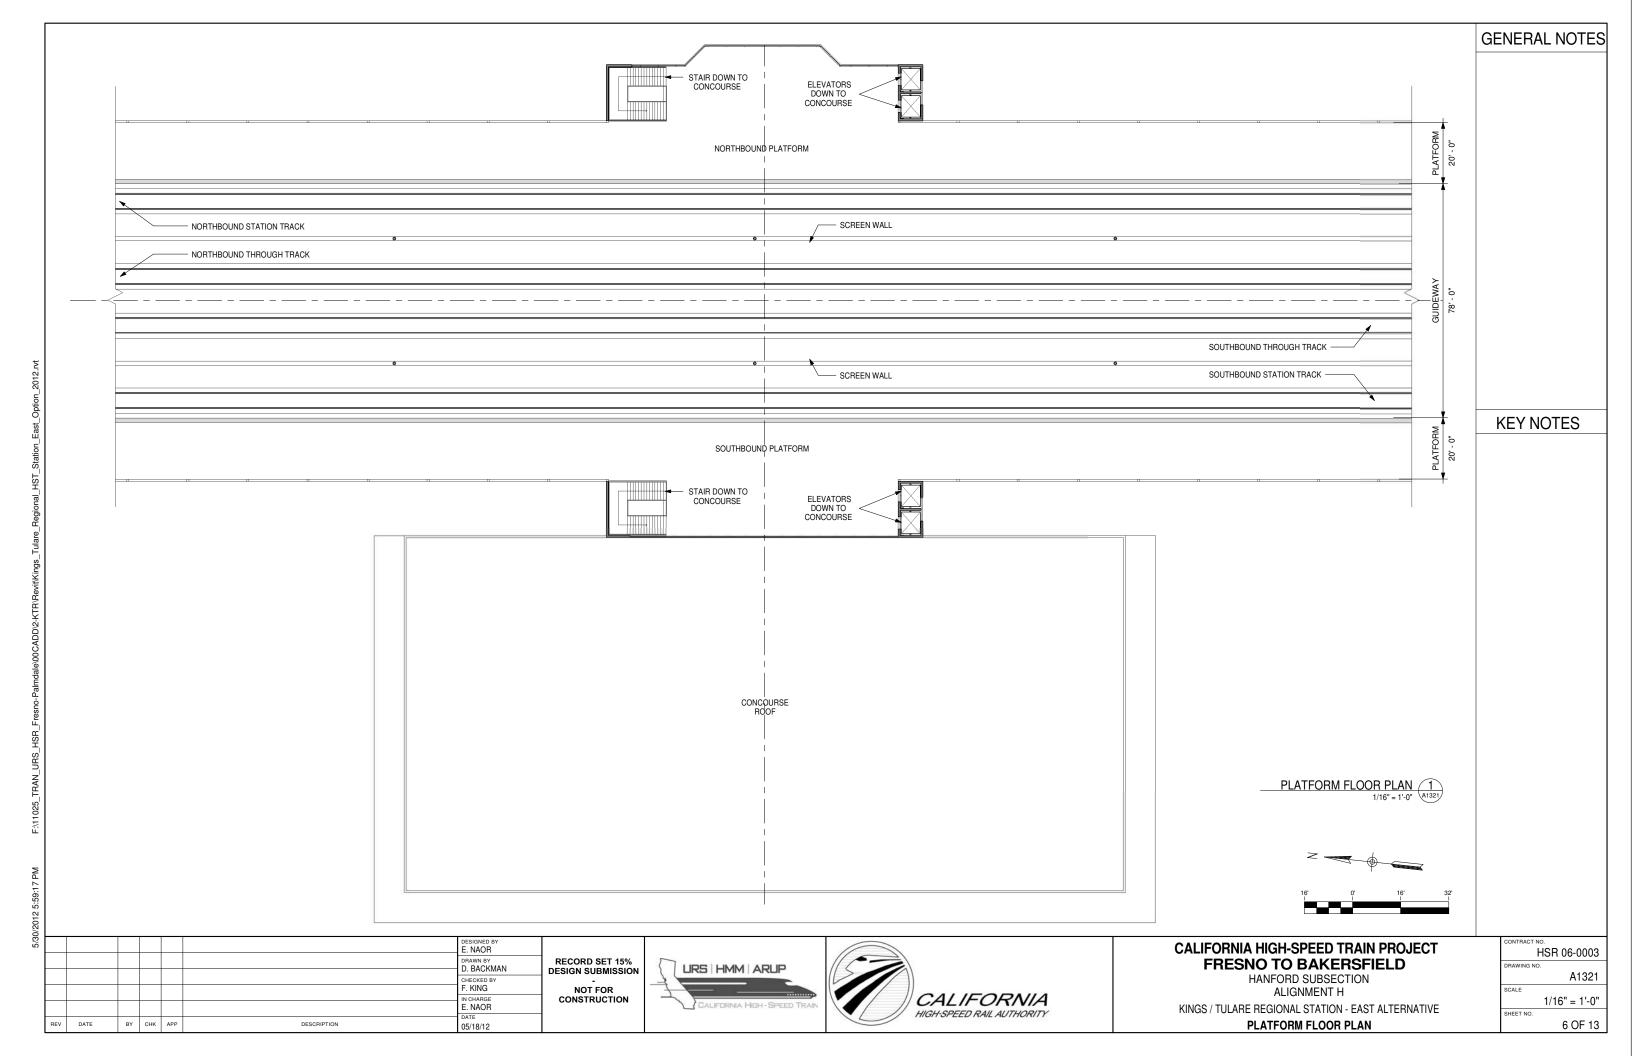

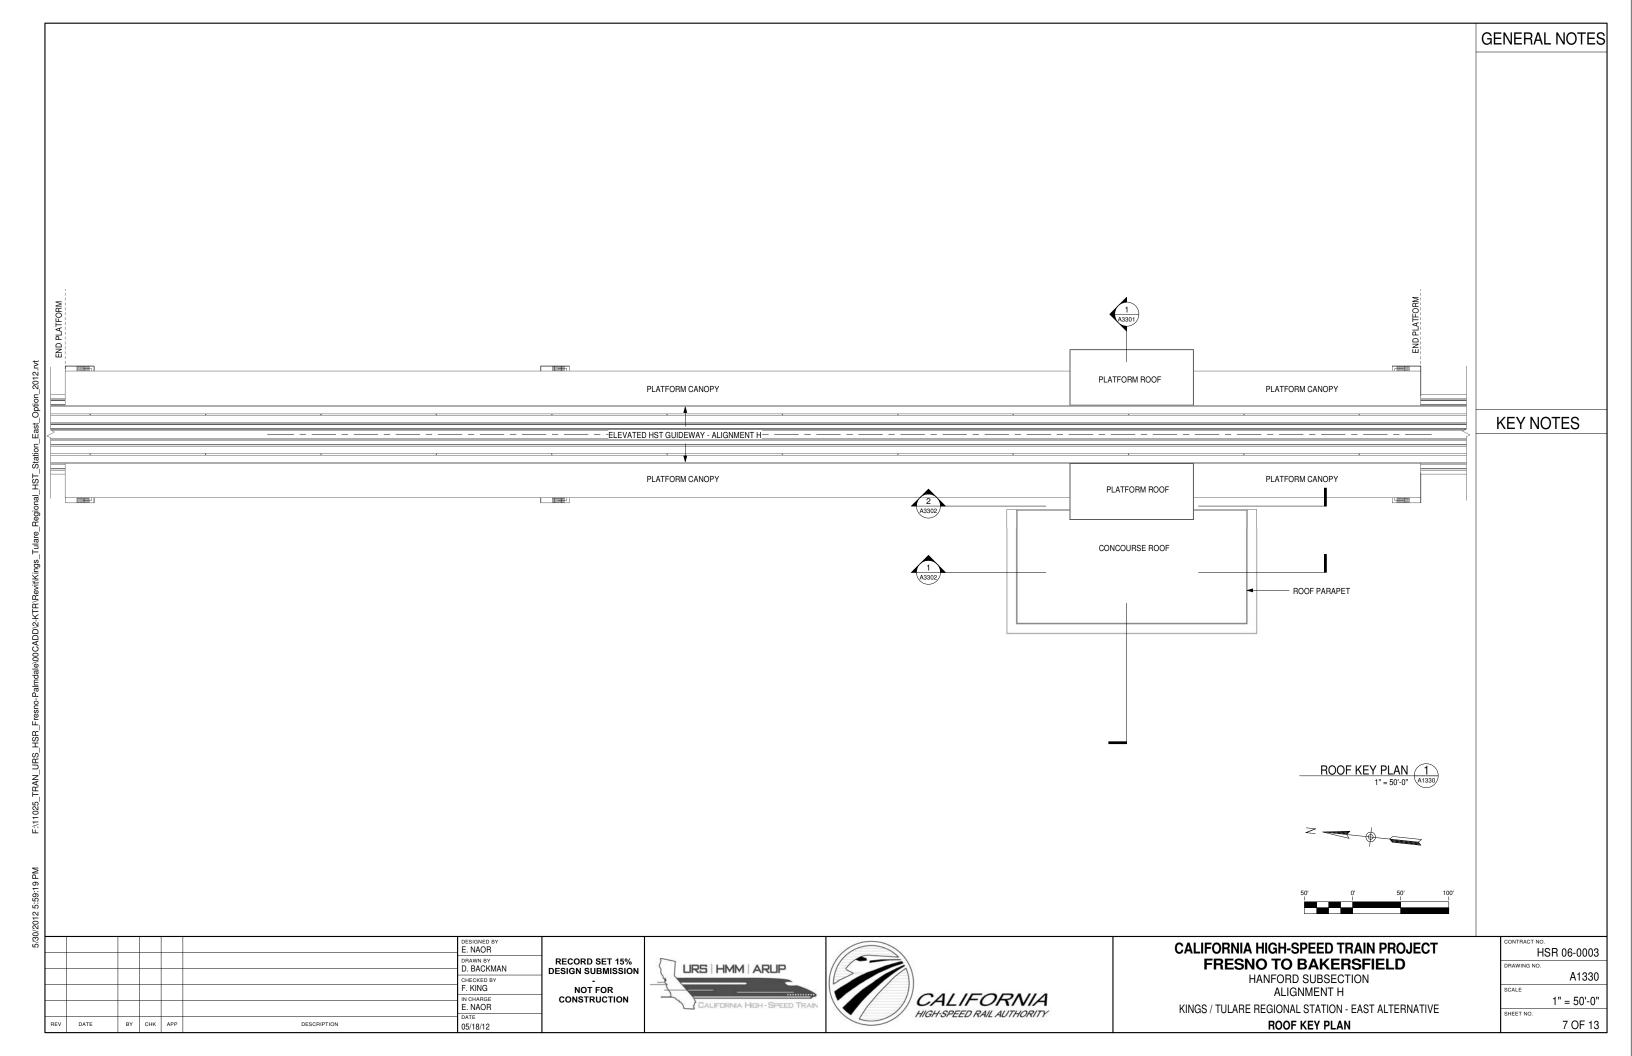

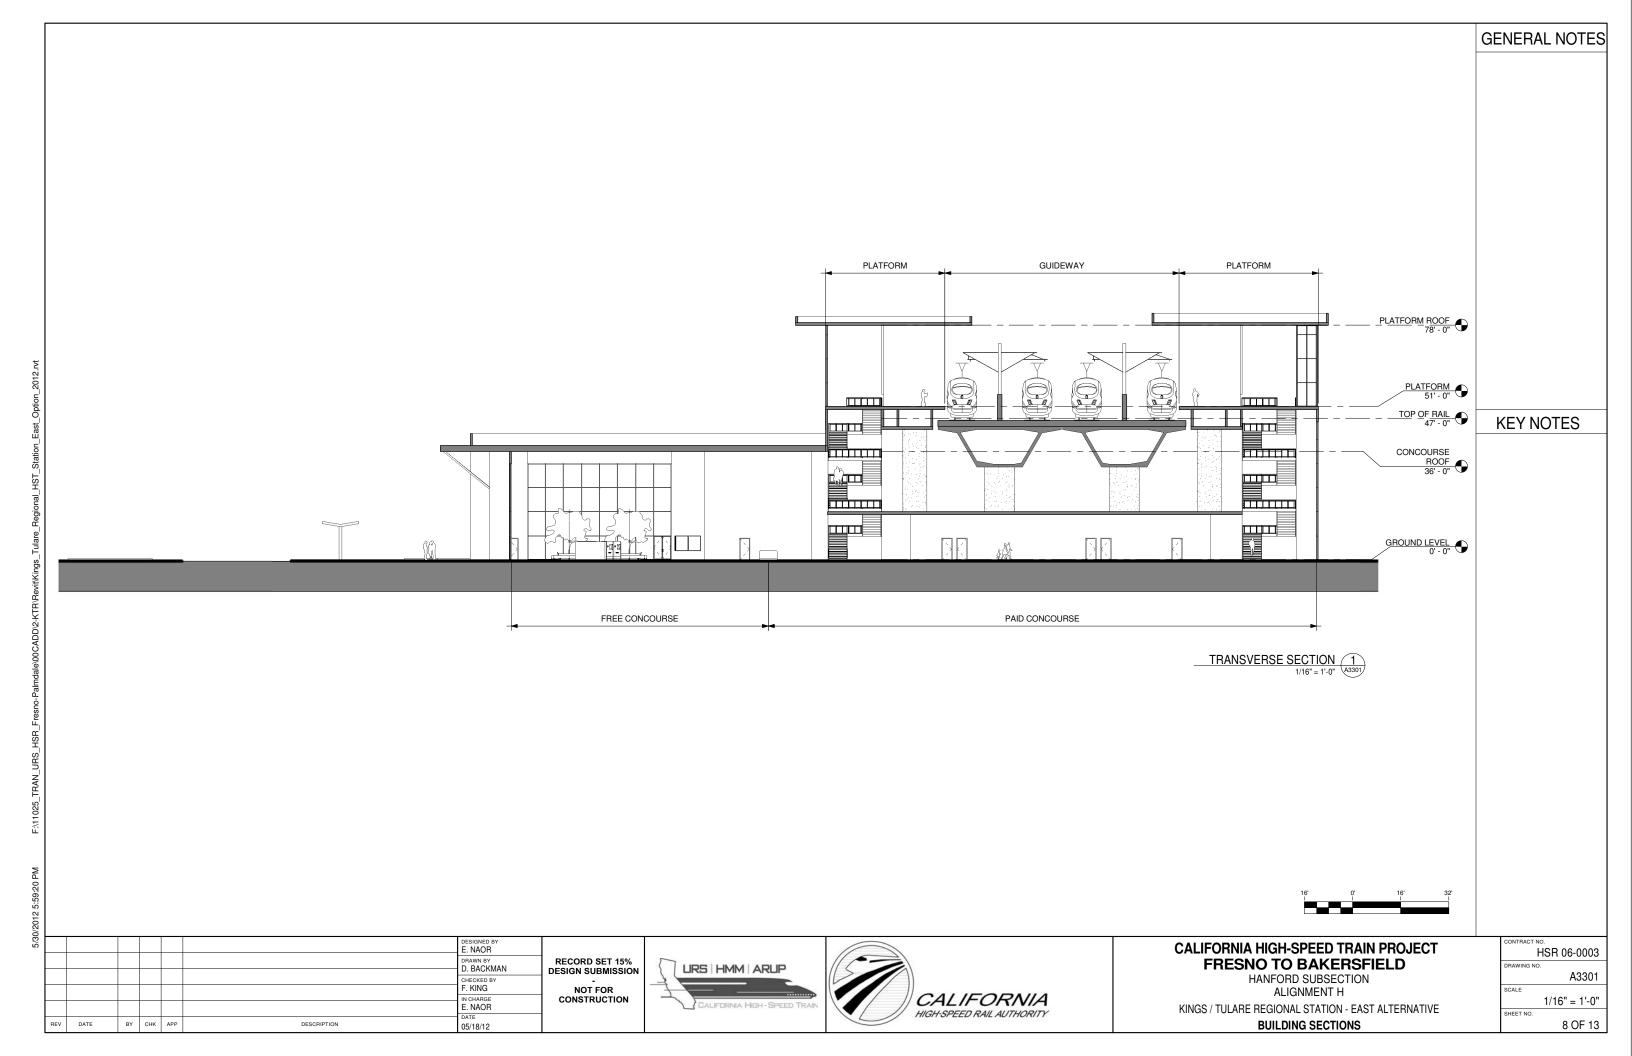

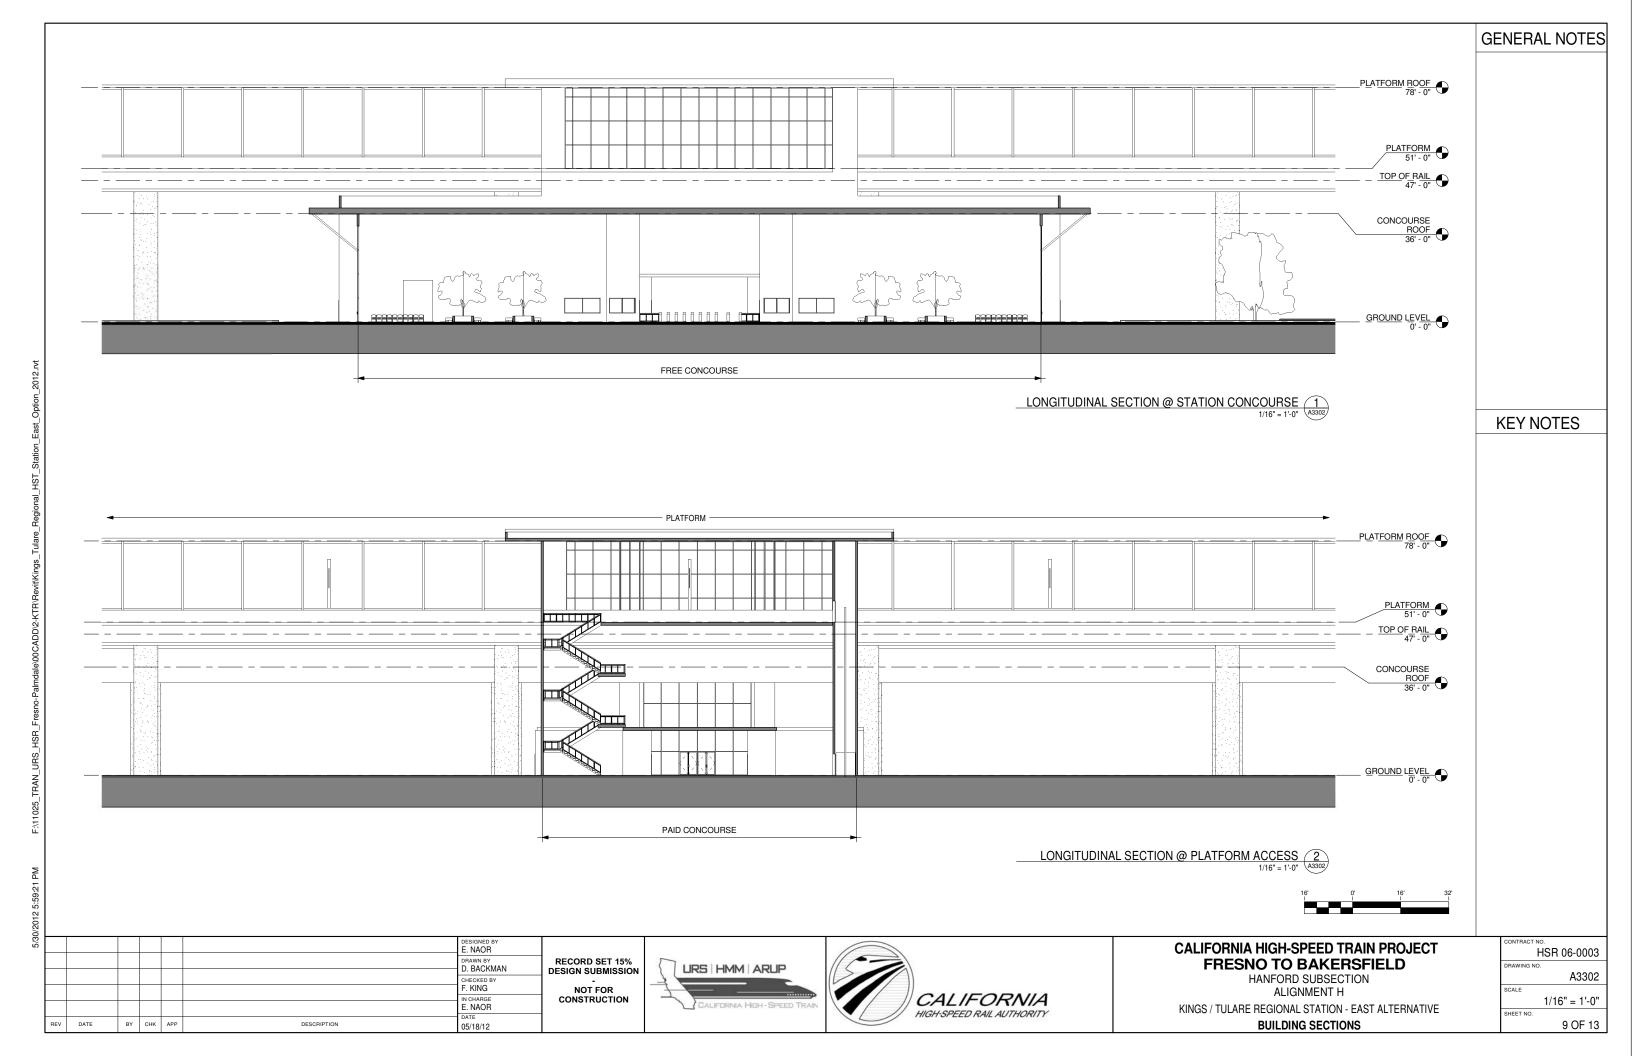

No.

ROOM NAME

CONCOURSE FREE AREA

TICKET SALES OFFICE

TICKET ADMIN OFFICE

STATION AGENT OFFICE

STAFF BREAK ROOM

PASSENGER SERVICE OFFICE

TRAINING & MEETING ROOM

TRASH & LANDSCAPE MAINTENANCE

STATION CONTROL ROOM

						DESIGNED BY E. NAOR	
						DRAWN BY D. BACKMAN	R
						CHECKED BY F. KING	DES
						IN CHARGE E. NAOR	(
REV	DATE	BY	СНК	APP	DESCRIPTION	DATE 05/18/12	

RECORD SET 15% ESIGN SUBMISSION NOT FOR CONSTRUCTION



TM 2.2.2.

REFERENCE

6.2.3.2

6.2.6.1.3

6.2.6.1.1

6.2.6.2.6

6.2.6.1.5

6.2.6.2.14

6.2.6.2.2

6.2.6.2.3

6.2.6.2.15/18

COMMENTS



## **CALIFORNIA HIGH-SPEED TRAIN PROJECT** FRESNO TO BAKERSFIELD

HANFORD SUBSECTION

ALIGNMENT H	SCALE
KINGS / TULARE REGIONAL STATION - EAST ALTERNATIVE	SHEET NO.
ROOM SCHEDULE	

CONTRACT NO.
HSR 06-0003
DRAWING NO.
A6301
SCALE
SHEET NO.
10 OF 13

10 TELECOM.12 STATION COMPUTER ROOM 668 SF TBD 6.2.6.3 556 SF 520 SF 520 SF 6.2.6.2.4 13 OPERATIONS MAINTENANACE
14 STATION ADMIN OFFICE 1119 SF 1080 SF 1080 SF 6.2.6.2.10 586 SF ((65sqft x staff with own workspace) + (43sqft x staff with shared workspace))x1.25 6.2.6.2.1 15 FACILITY MAINTENANCE OFFICE 325 SF 465 SF 325 SF 6.2.6.2.9 16 TRANSIT AGENCY OFFICES17 STAFF RESTROOM & LOCKER ROOM 465 SF 6.2.6.2.11 586 SF Local Codes 6.2.6.2.12/13 18 STAFF RESTROOM & LOCKER ROOM 587 SF Local Codes 6.2.6.2.12/13 19 PUBLIC RESTROOM 473 SF 137 SF P15 6235 20 PUBLIC RESTROOM 21 JANITOR 468 SF 137 SF P15 6235 200 SF 110 SF 110 SF x 3 6.2.6.2.16 22 STORAGE 23 SECURITY OFFICE 200 SF 130 SF 130 SF x 3 6.2.6.2.17 299 SF 160 SF 6.2.6.2.7 160 SF 24 POLICE OFFICE 300 SF 160 SF 160 SF 6.2.6.2.8 25 CONCOURSE PAID AREA 26 SIGNALING 8615 SF 5950 SF P15x25sqft 6.2.4.1 6.2.6.3 27 FIRE PROTECTION
28 MECHANICAL
29 ELECTRICAL TBD 866 SF 6.2.6.3 872 SF TBD 6.2.6.3 860 SF TBD 6.2.6.3 30 PLUMBING 814 SF TBD 6.2.6.3 33 FUTURE CONCESSION 34 FUTURE CONCESSION 706 SF TBD 6.2.7 707 SF TBD 6.2.7 35 OFFICE TBD 719 SF 6.2.6.3

**FORMULA** 

REQUIRED

P15x30sf/person

(((P60bx.15)/(1.5 x 60)) x 75) sqft

(20sqft x .25 x max staff per shift x 1.25)

(20sqft x max staff per shift x 1.25)

160 SF

160 SF

270 SF

1080 SF

TBD

AREA

464 SF

544 SF

420 SF

300 SF

565 SF

515 SF

746 SF

1097 SF

13699 SF 4110 SF

160 SF

75 SF


160 SF

270 SF

125 SF

500 SF


1080 SF

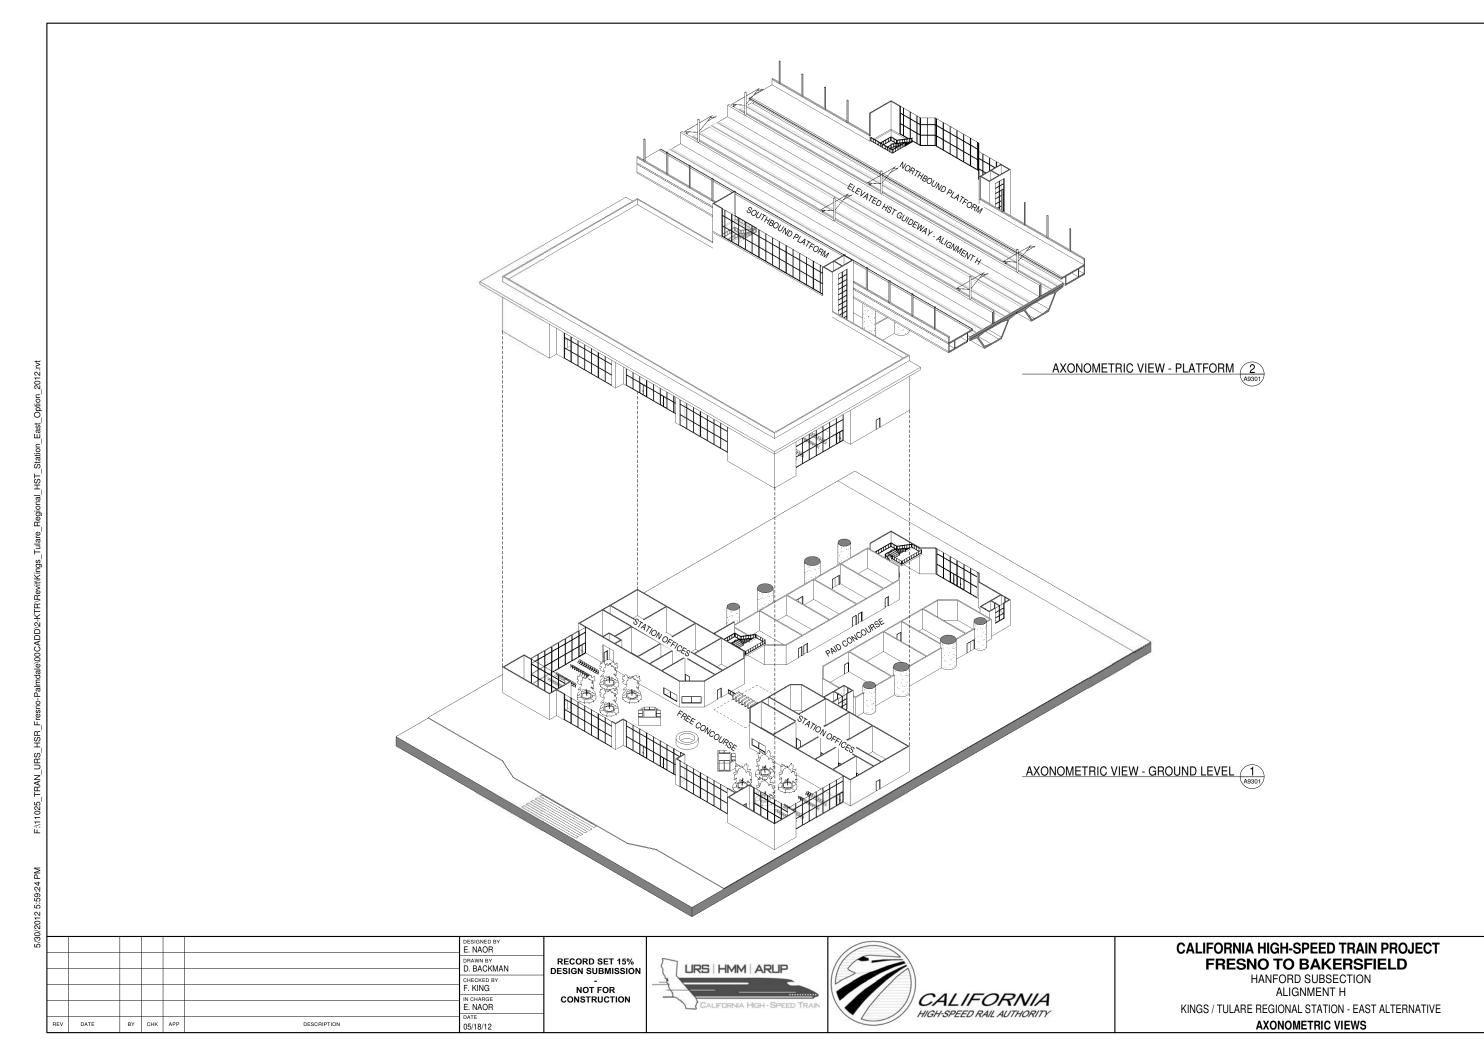



HSR 06-0003


A9301


11 OF 13

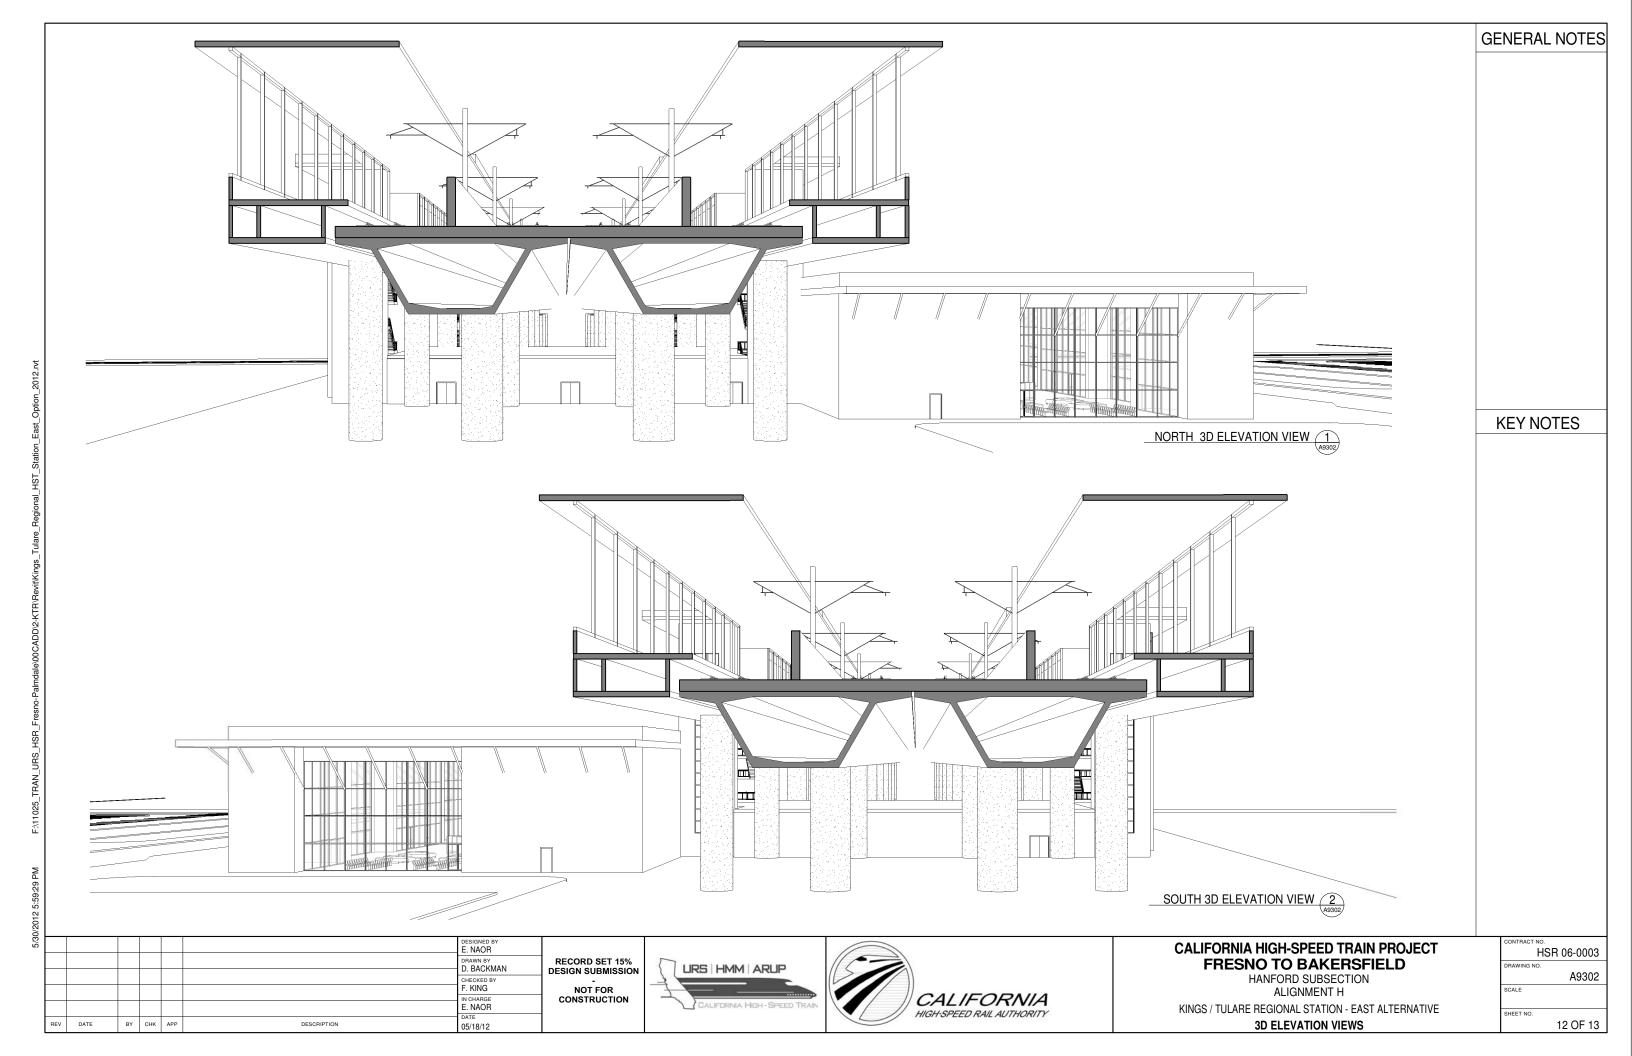


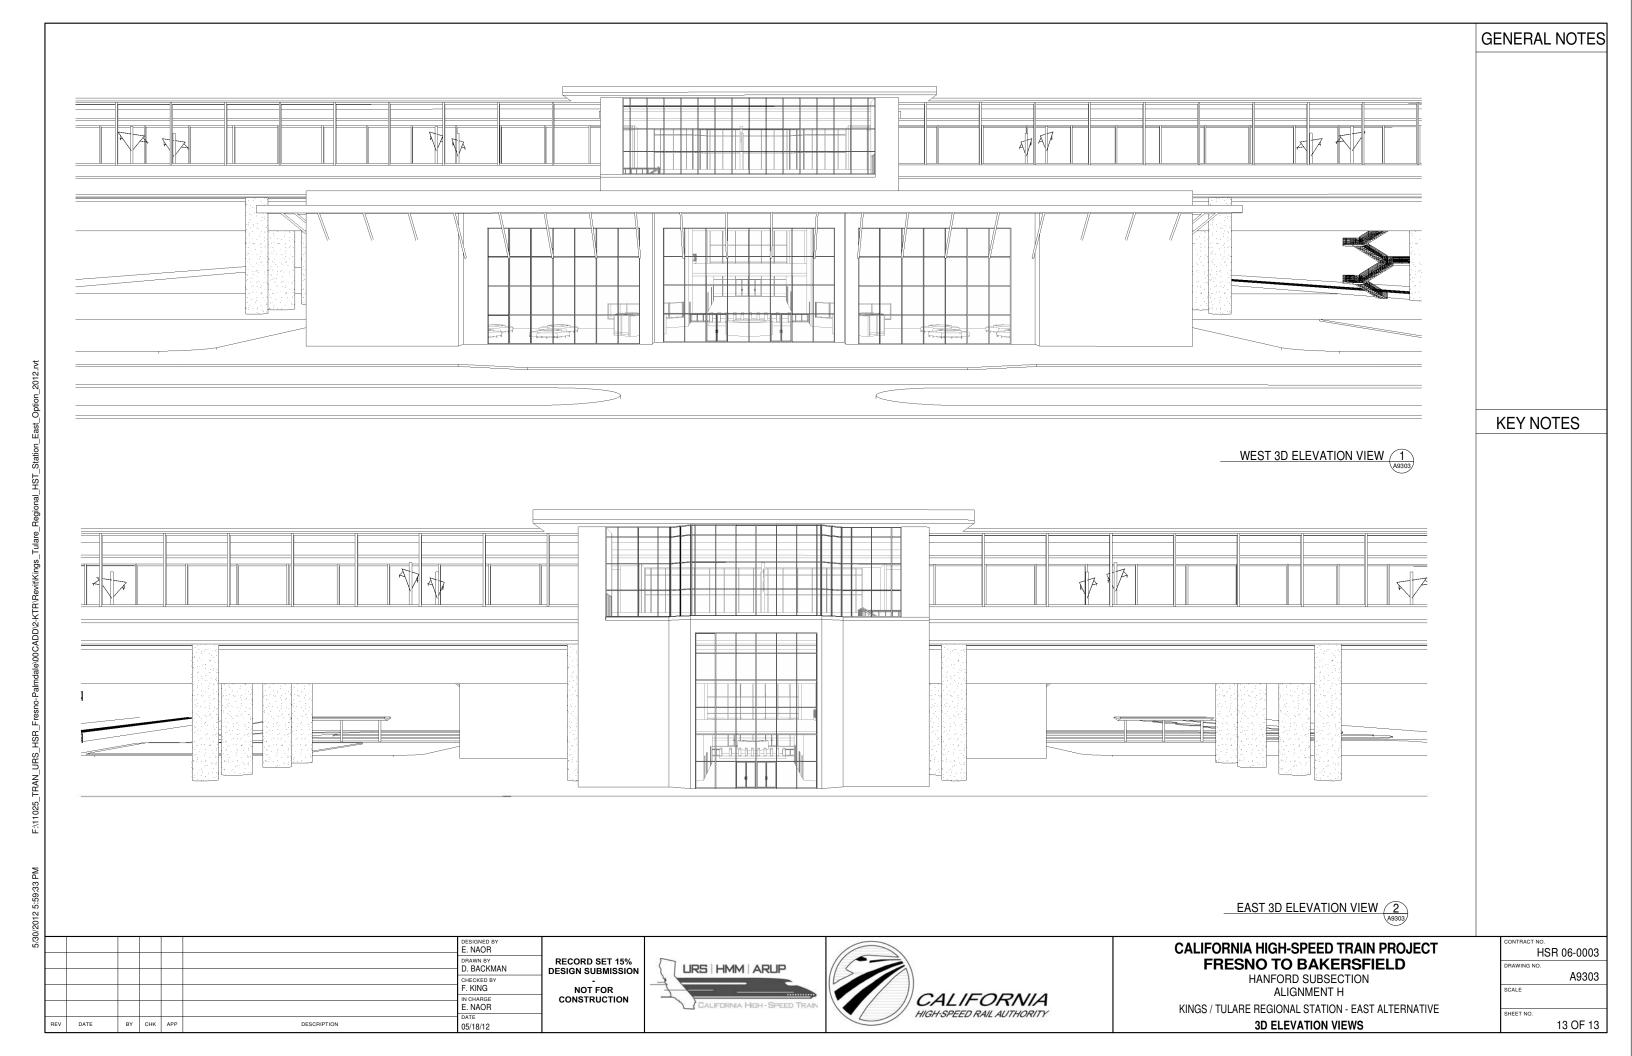


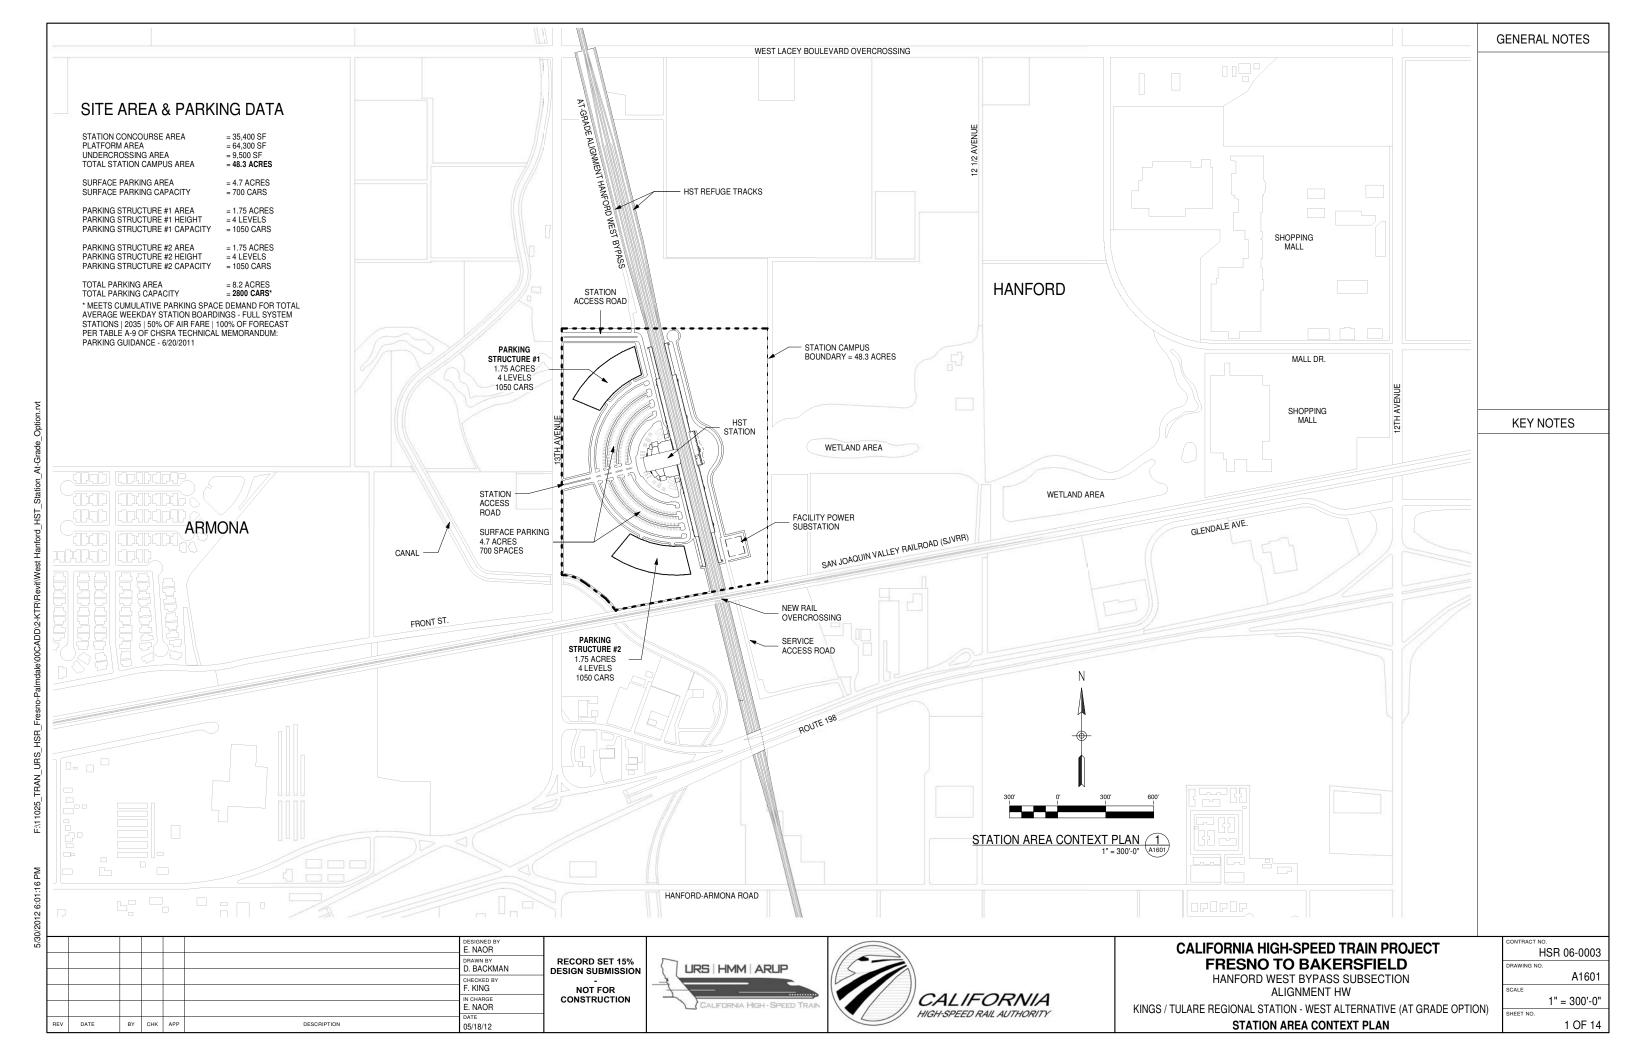


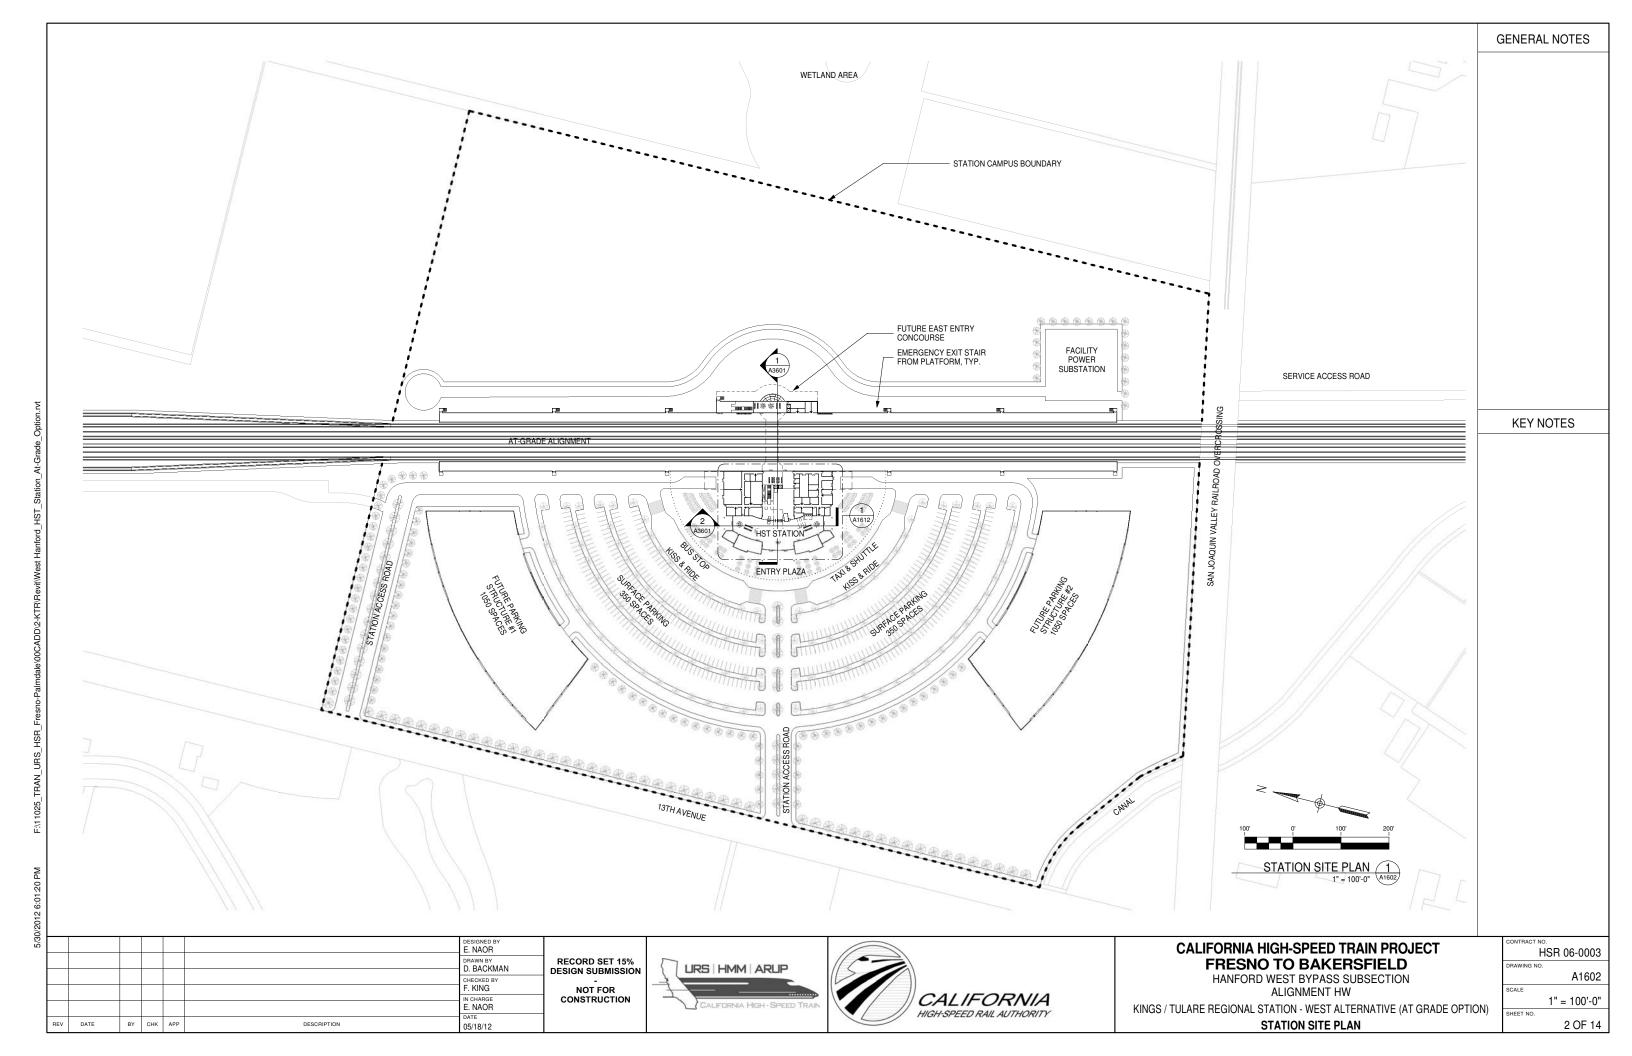


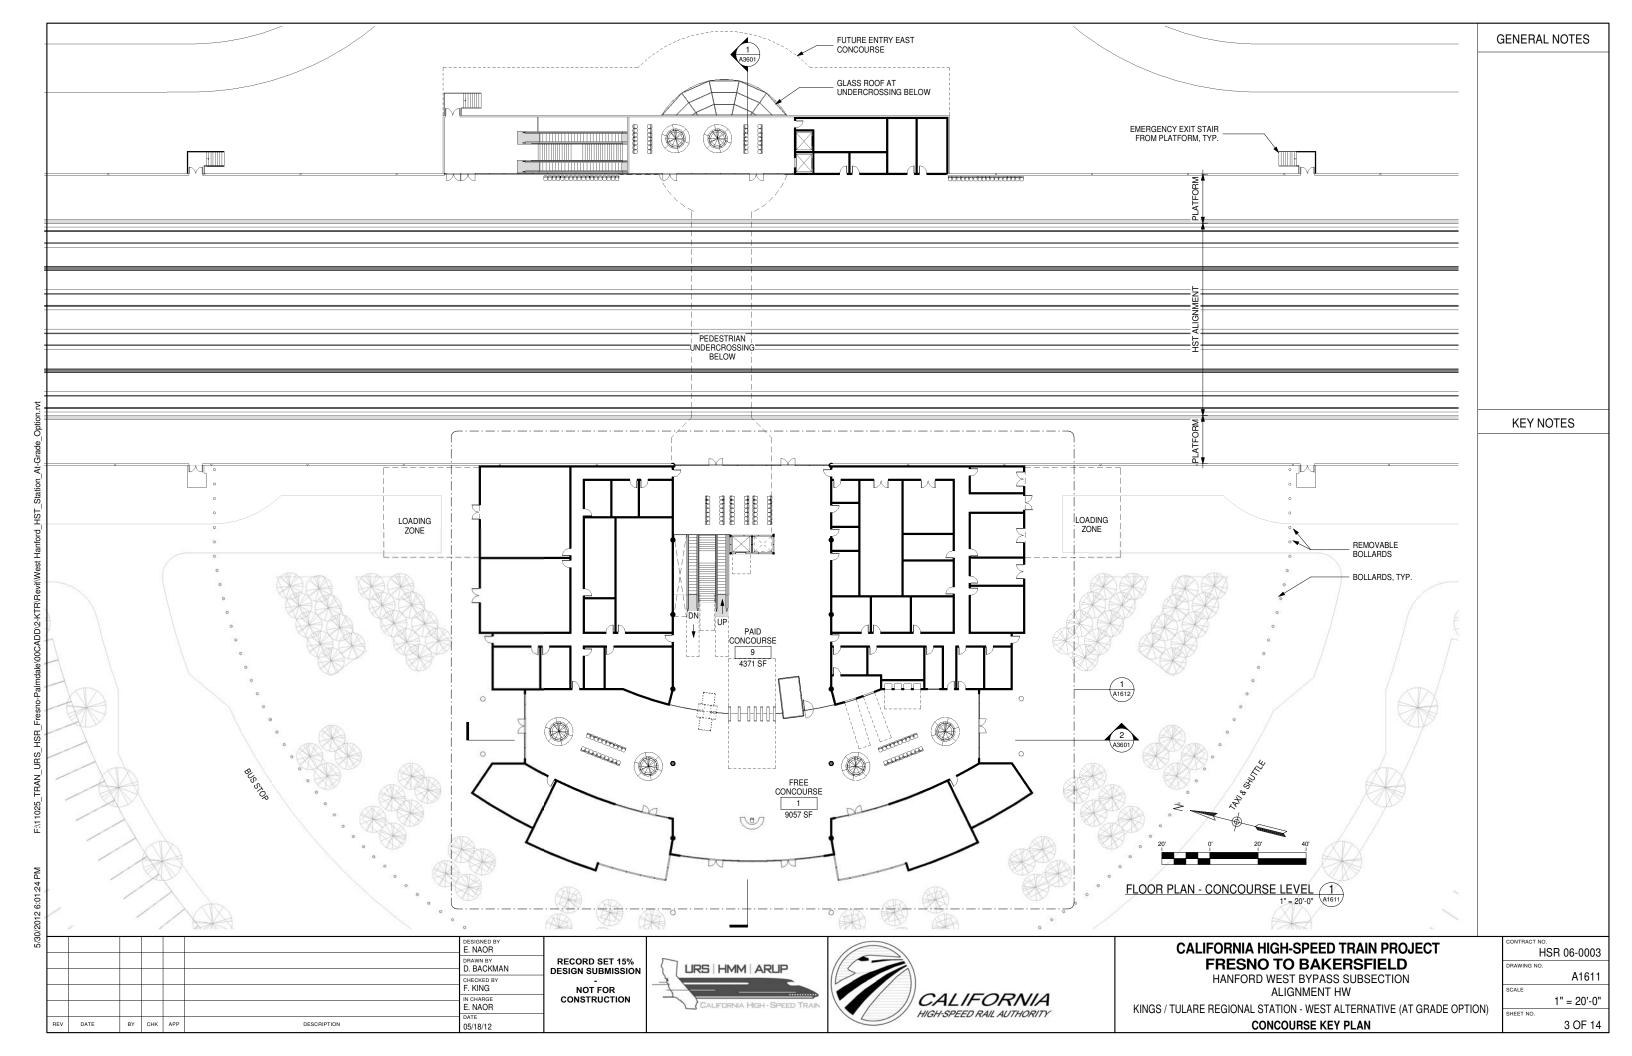


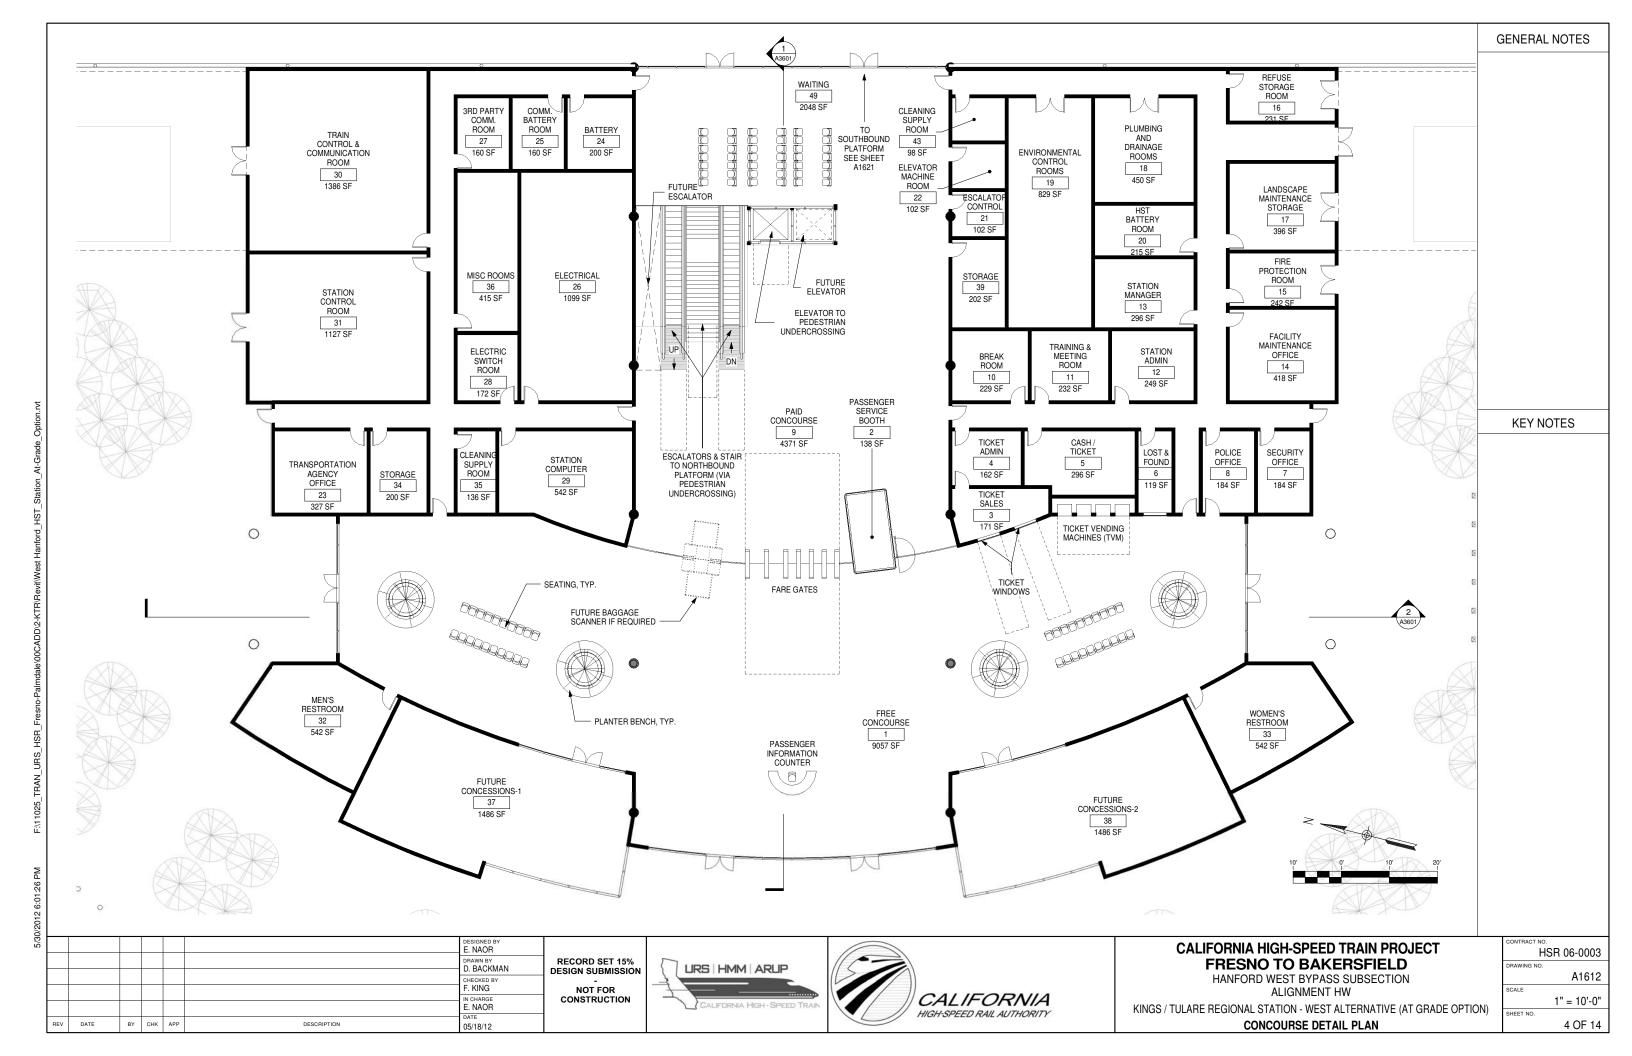


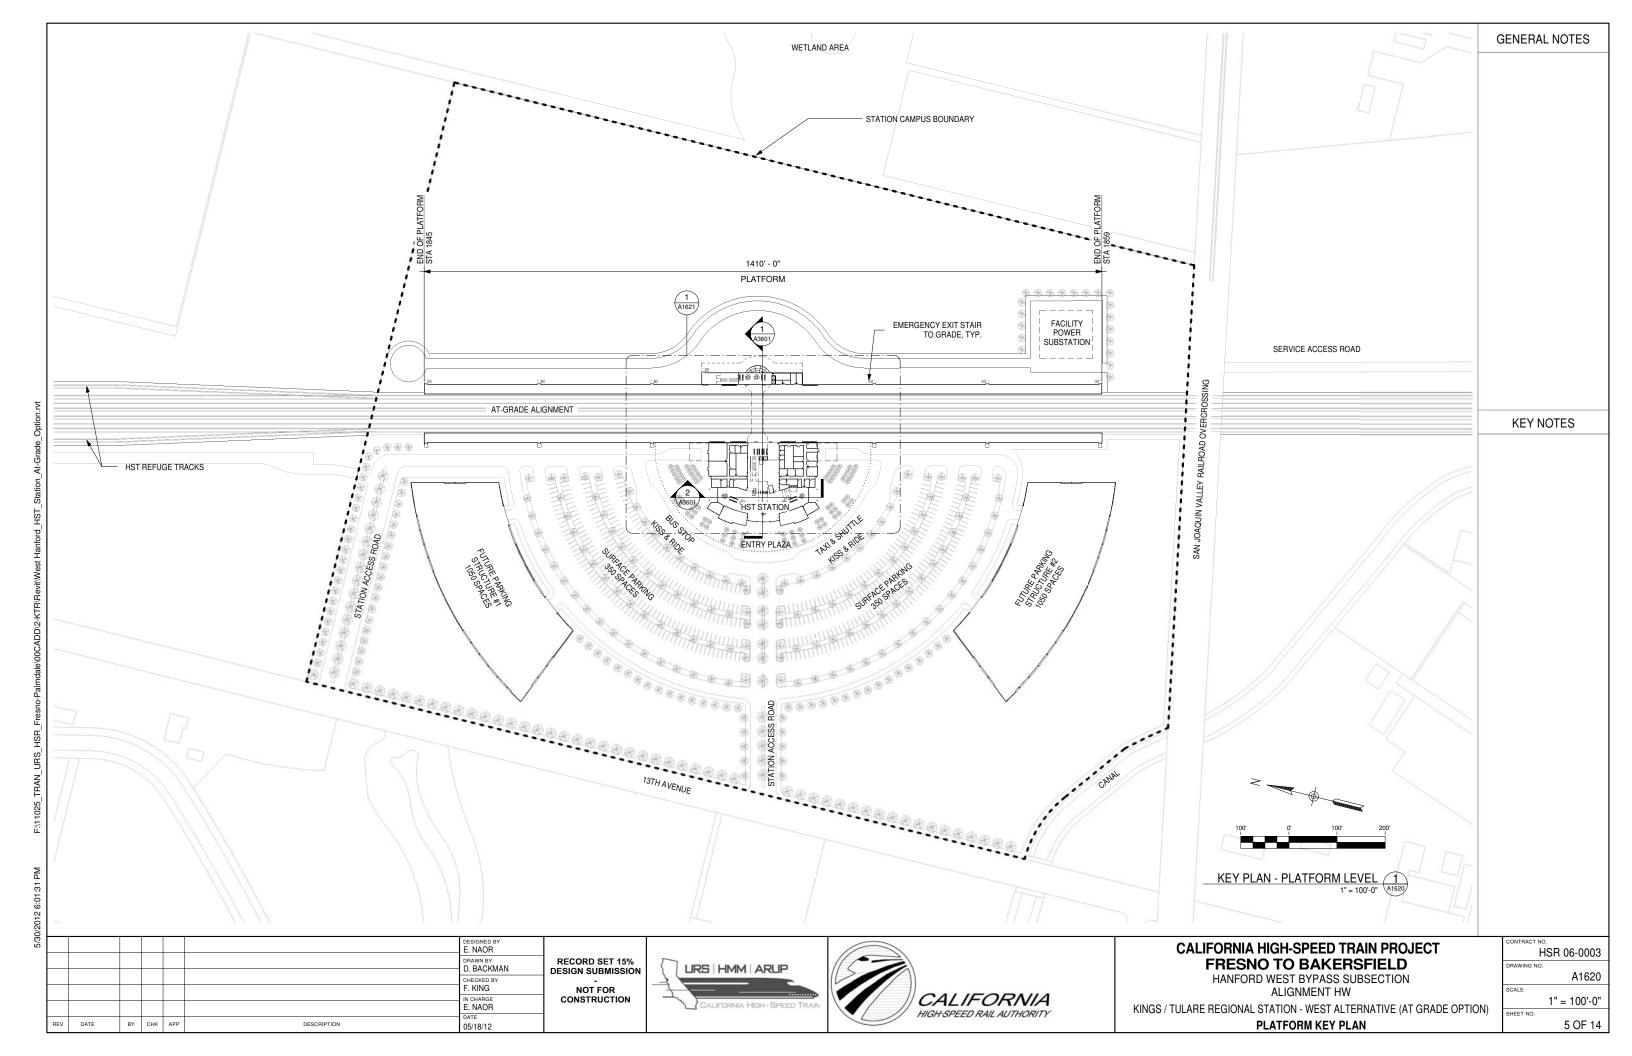

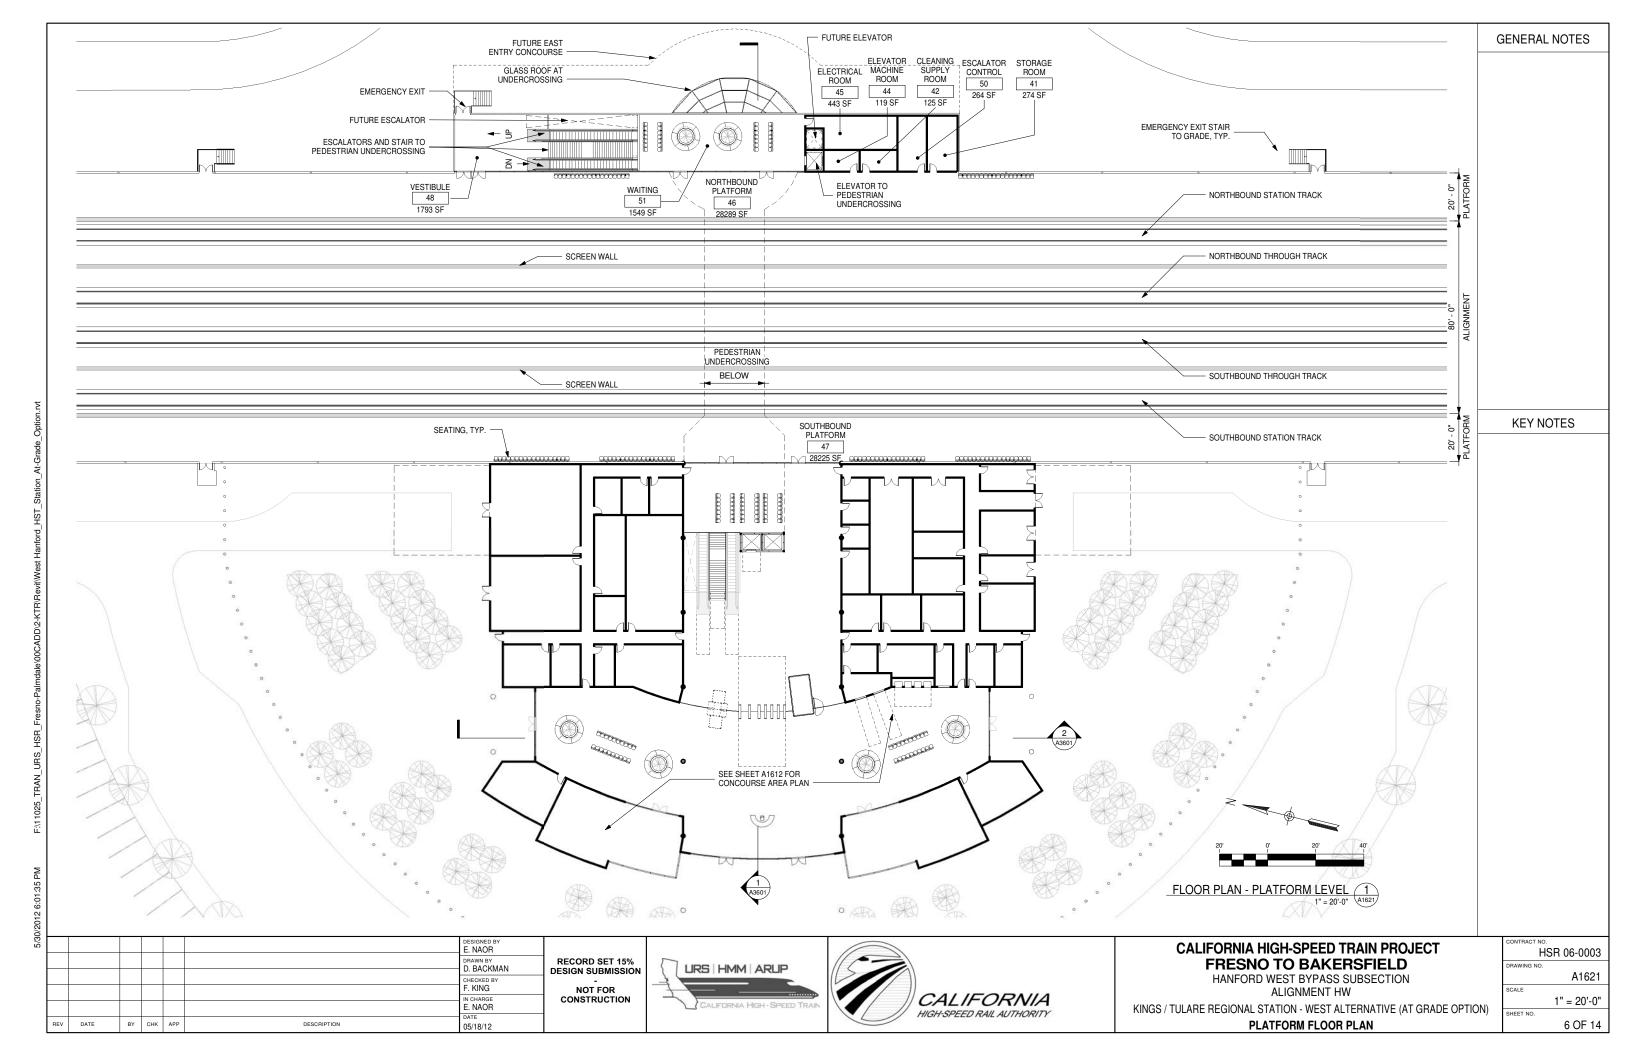

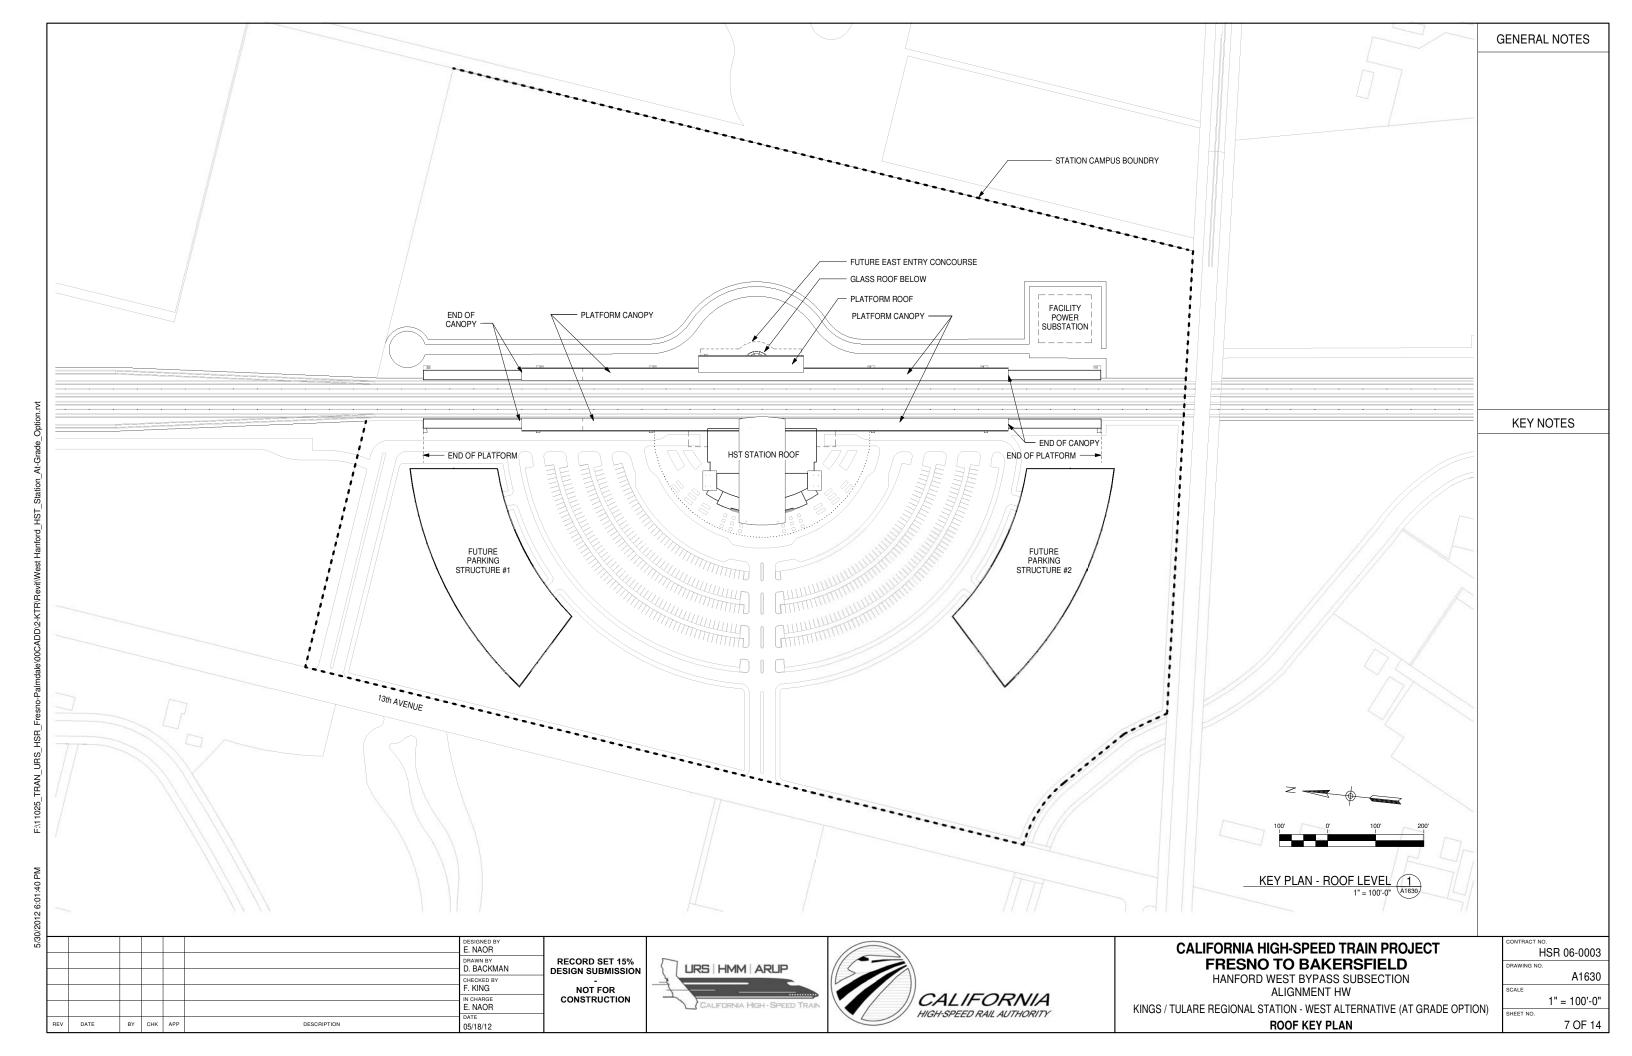

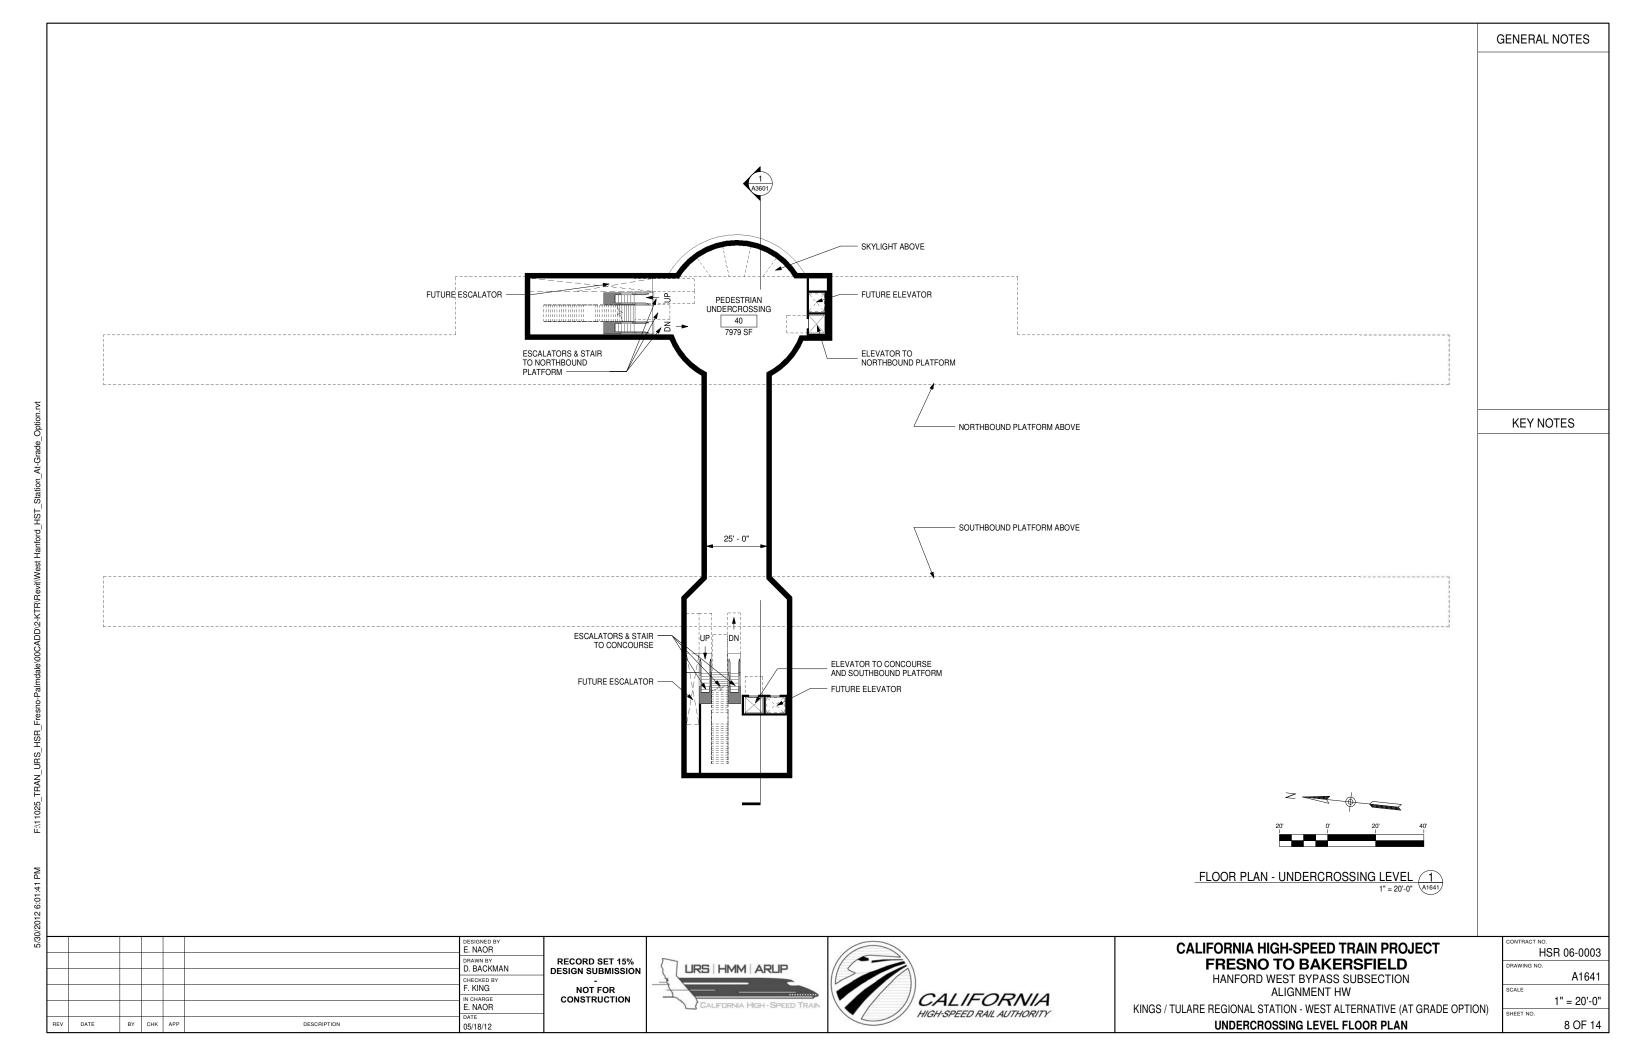

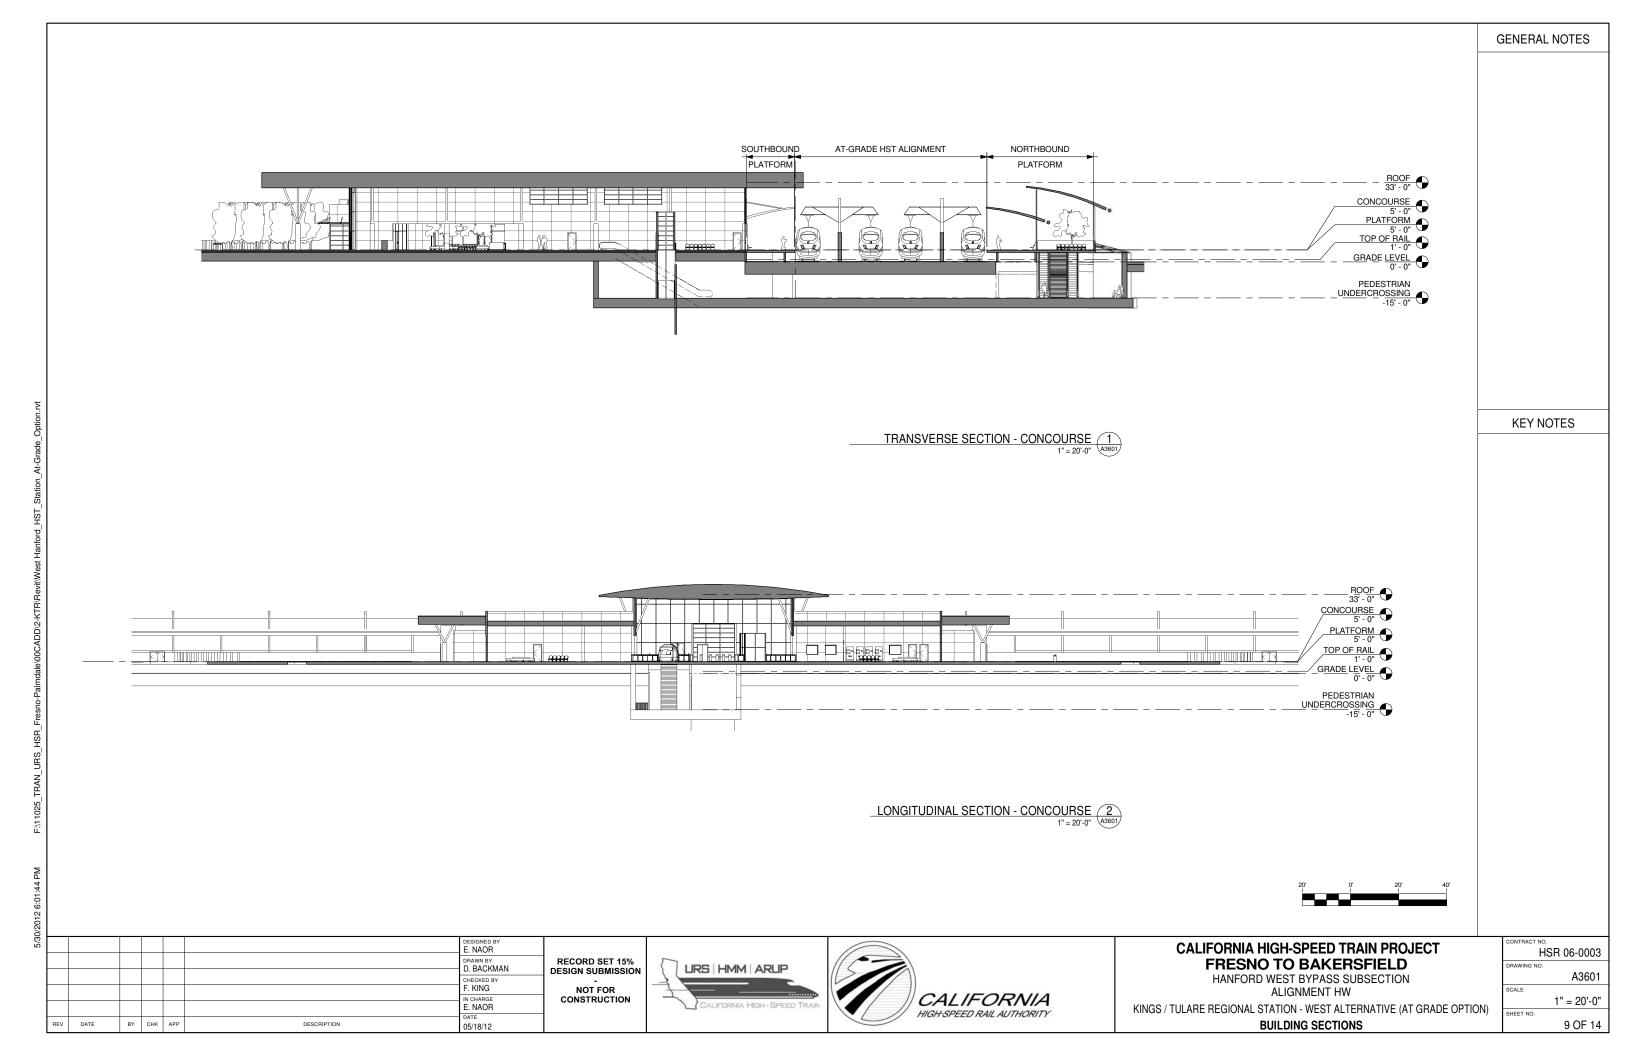

## **ROOM SCHEDULE**

			REQUIRED		TM 2.2.2.	
No.	ROOM NAME	AREA	AREA	FORMULA	REFERENCE	COMMENTS
	EDEE GONGOLIDOE	0057.05	1	T.I. 00 *	1000	
1	FREE CONCOURSE	9057 SF		Table 6-2 *	6.3.2	
2	PASSENGER SERVICE BOOTH	138 SF			6.6.2.3	
3	TICKET SALES	171 SF	150 SF	75 sf per window	6.6.2.2	Two windows
4	TICKET ADMIN	162 SF	160 SF		6.6.3.7	
5	CASH / TICKET	296 SF	260 SF		6.6.3.8	
6	LOST & FOUND	119 SF	80 SF		6.6.2.5	
7	SECURITY OFFICE	184 SF	160 SF		6.6.3.9	
8	POLICE OFFICE	184 SF	160 SF		6.6.2.6	
9	PAID CONCOURSE	4371 SF		Table 6-2 *	6.3.3	
10	BREAK ROOM	229 SF	200 SF		6.6.3.12	
11	TRAINING & MEETING ROOM	232 SF	200 SF		6.6.3.4	
	STATION ADMIN	249 SF		100 SF per assigned staff	6.6.3.2	
13	STATION MANAGER	296 SF	270 SF		6.6.3.3	
14	FACILITY MAINTENANCE OFFICE	418 SF	330 SF		6.6.3.10	
15	FIRE PROTECTION ROOM	242 SF	0 SF		6.6.6.3	
16	REFUSE STORAGE ROOM	231 SF	150 SF		6.6.4.1	
17	LANDSCAPE MAINTENANCE STORAGE	396 SF			6.6.4.4	
18	PLUMBING AND DRAINAGE ROOMS	450 SF	150 SF		6.6.6.4	
19	ENVIRONMENTAL CONTROL ROOMS	829 SF	0 SF		6.6.6.1	
20	HST BATTERY ROOM	215 SF	150 SF		6.6.7.2	
	ESCALATOR CONTROL	102 SF	0 SF			
22	ELEVATOR MACHINE ROOM	102 SF	0 SF		6.5.3.6	
23	TRANSPORTATION AGENCY OFFICE	327 SF	100		6.6.3.16	
	BATTERY	200 SF	200 SF		6.6.6.2	
25	COMM. BATTERY ROOM	160 SF	160 SF		6.6.7.1	
26	ELECTRICAL	1099 SF	450 SF		6.6.6.2	
	3RD PARTY COMM. ROOM	160 SF	160 SF		6.6.7.1	
	ELECTRIC SWITCH ROOM	172 SF	160 SF		6.6.7.2	
29	STATION COMPUTER	542 SF	500 SF		6.6.3.6	
30	TRAIN CONTROL & COMMUNICATION ROOM	1386 SF	1280 SF		6.6.7.1	
31	STATION CONTROL ROOM	1127 SF	1100 SF		6.6.3.5	
32	MEN'S RESTROOM	542 SF	1100 01	Size per code	6.3.4	
33	WOMEN'S RESTROOM	542 SF			6.3.4	
34	STORAGE	200 SF	150 SF	Size per code	6.6.4.3	
35	CLEANING SUPPLY ROOM	136 SF	80 SF			
	MISC ROOMS				6.6.4.2	
36 37	FUTURE CONCESSIONS-1	415 SF 1486 SF	300 SF 1500 SF	Table 6-3	6.6.4.5 6.3.5	
38	FUTURE CONCESSIONS-2	1486 SF	1500 SF	Table 6-3	6.3.5	
39	STORAGE	202 SF	-		0.5.0.5	40 ft min with
40	PEDESTRIAN UNDERCROSSING	7979 SF	100.05			16 ft min. width
41	STORAGE ROOM	274 SF	100 SF		6.6.4.3	
42	CLEANING SUPPLY ROOM	125 SF	80 SF		6.6.4.2	
43	CLEANING SUPPLY ROOM	98 SF	80 SF		6.6.4.2	
44	ELEVATOR MACHINE ROOM	119 SF			6.5.3.6	
45	ELECTRICAL ROOM	443 SF	450 SF		6.6.6.2	
46	NORTHBOUND PLATFORM	28289 SF		25 sf min per boarding passenger *	6.4.2	
47	SOUTHBOUND PLATFORM	28225 SF		25 sf min per boarding passenger *	6.4.2	
48	VESTIBULE	1793 SF		Table 6-2 *	6.5.1.4	
49	WAITING	2048 SF		Table 6-2 *	6.3.3.2	
50	ESCALATOR CONTROL	264 SF				
51	WAITING	1549 SF		Table 6-2 *	6.3.3.2	

\* STATION PUBLIC AREAS AND VERTICAL CIRCULATION ARE SIZED FOR PEAK PASSENGER FORCAST FOR FULL BUILD OUT (2035) AT 50% AIR FARES AS PROVIDED IN STATION AREA PARKING GUIDANCE TECHNICAL MEMORANDUM REV 4, DATED 6/20/2011

PEAK CUMULATIVE DAILY BOARDINGS OF 3,300 PASSENGERS

PEAK HOUR BOARDINGS (P60B) OF 495 PASSENGERS

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2/30/							DESIGNED BY E. NAOR	
							D. BACKMAN	RI
							CHECKED BY F. KING	
							IN CHARGE E. NAOR	] c
	REV	DATE	BY	СНК	APP	DESCRIPTION	05/18/12	


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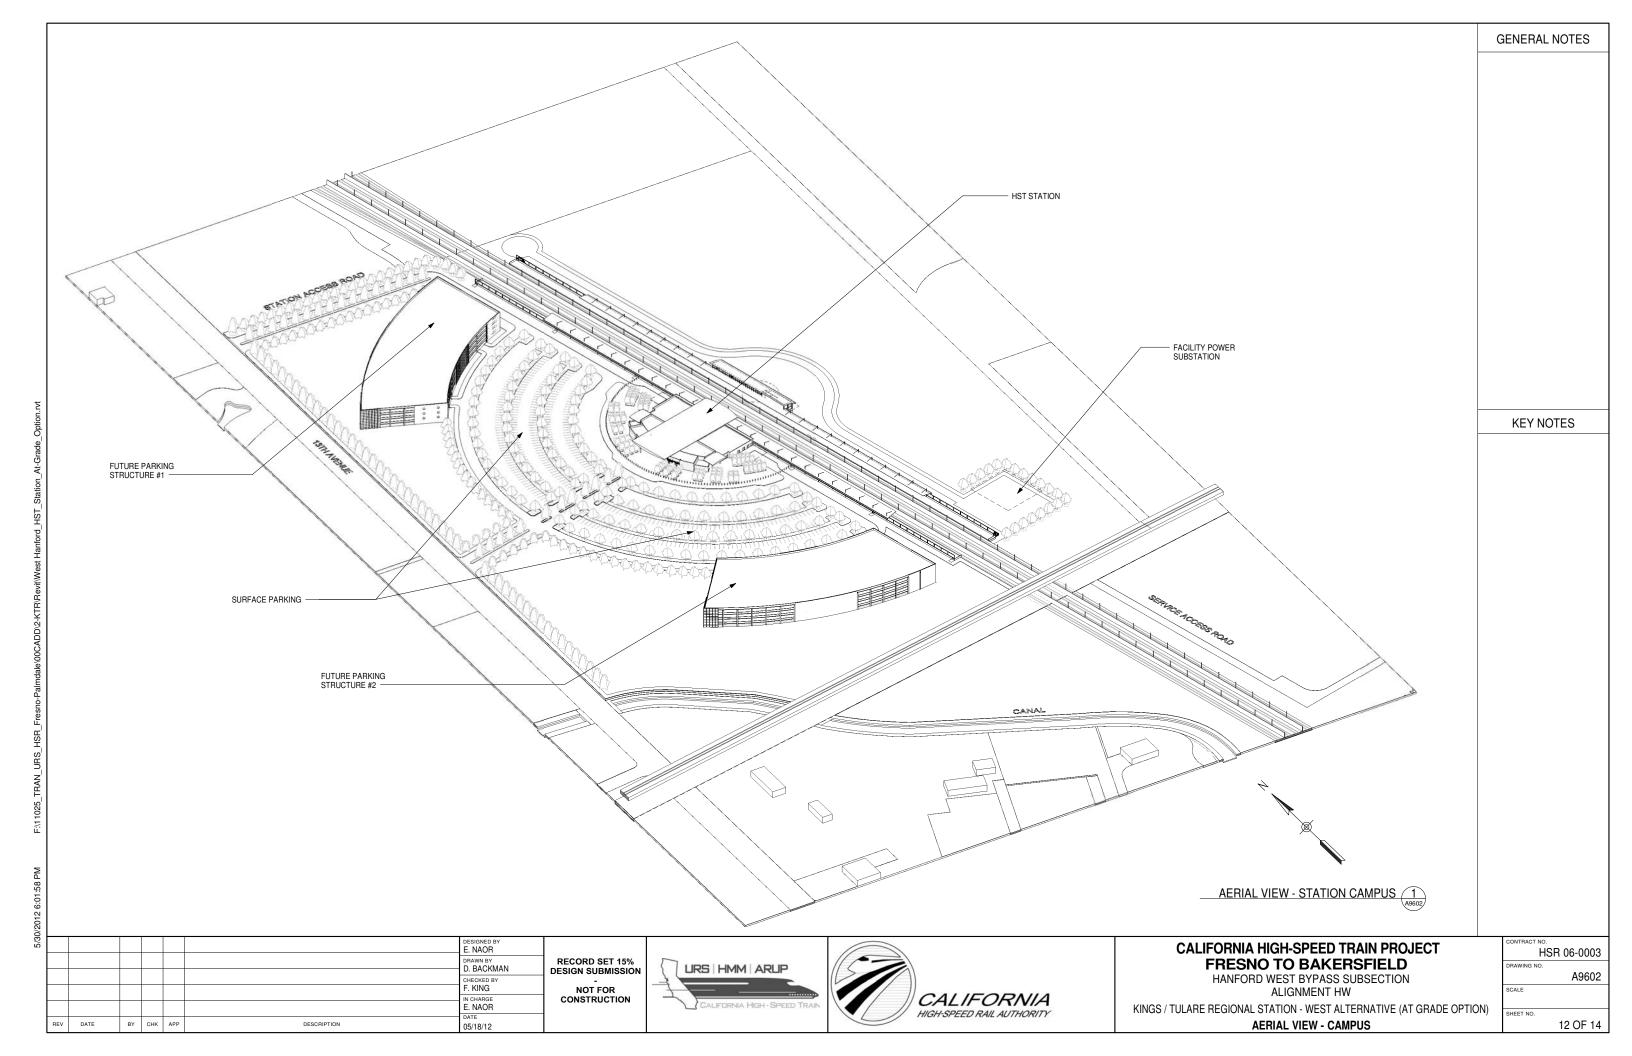






#### CALIFORNIA HIGH-SPEED TRAIN PROJECT FRESNO TO BAKERSFIELD

CALIFORNIA HIGH-SPEED TRAIN PROJECT	HSR 06-0003
FRESNO TO BAKERSFIELD	DRAWING NO.
HANFORD WEST BYPASS SUBSECTION	A6601
ALIGNMENT HW	SCALE
KINGS / TULARE REGIONAL STATION - WEST ALTERNATIVE (AT GRADE OPTION)	SHEET NO.
ROOM SCHEDULE	10 OF 14



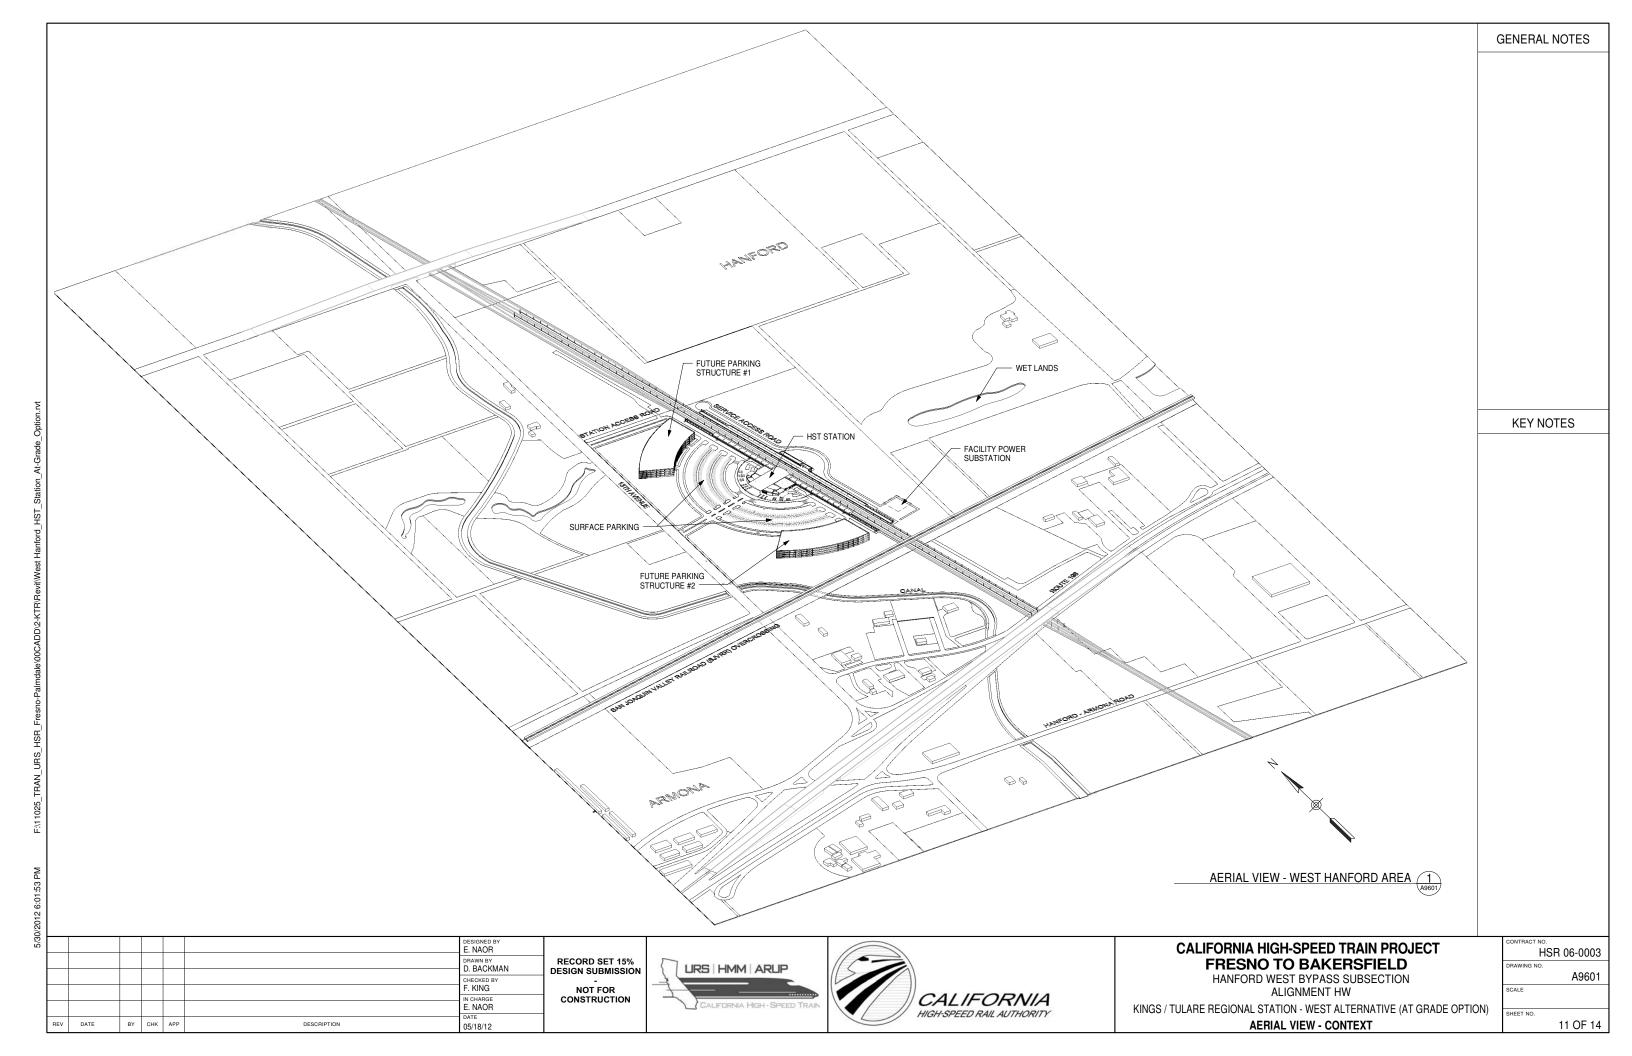

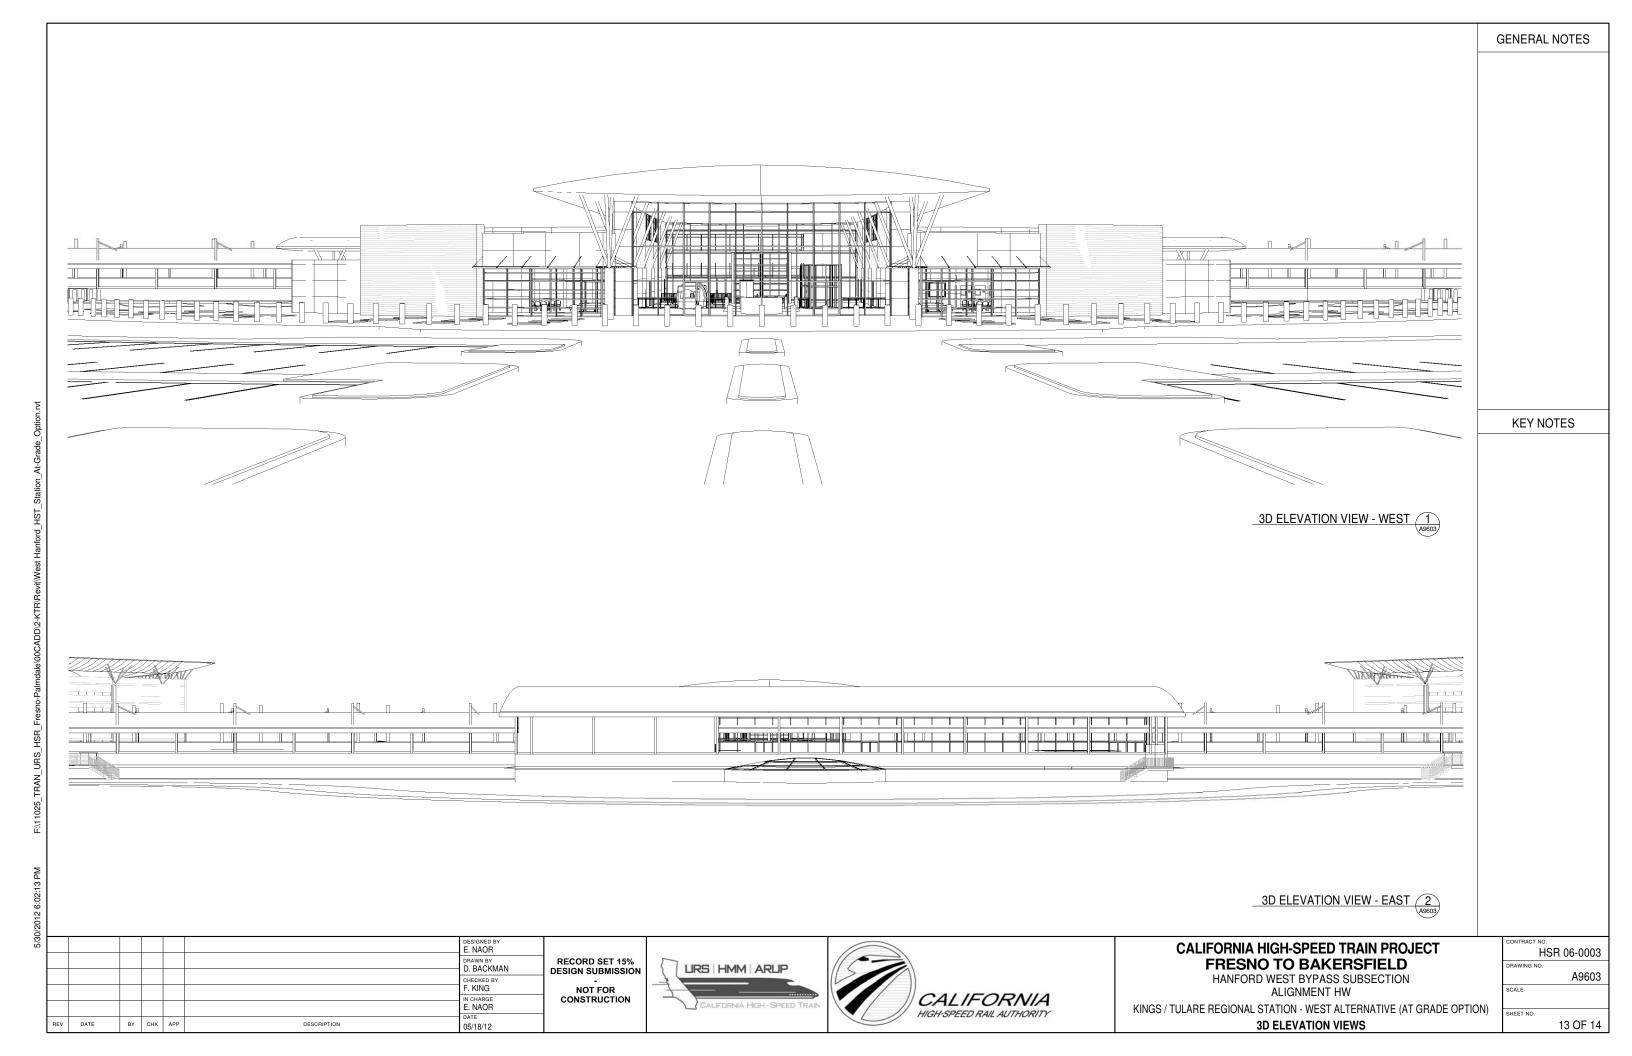

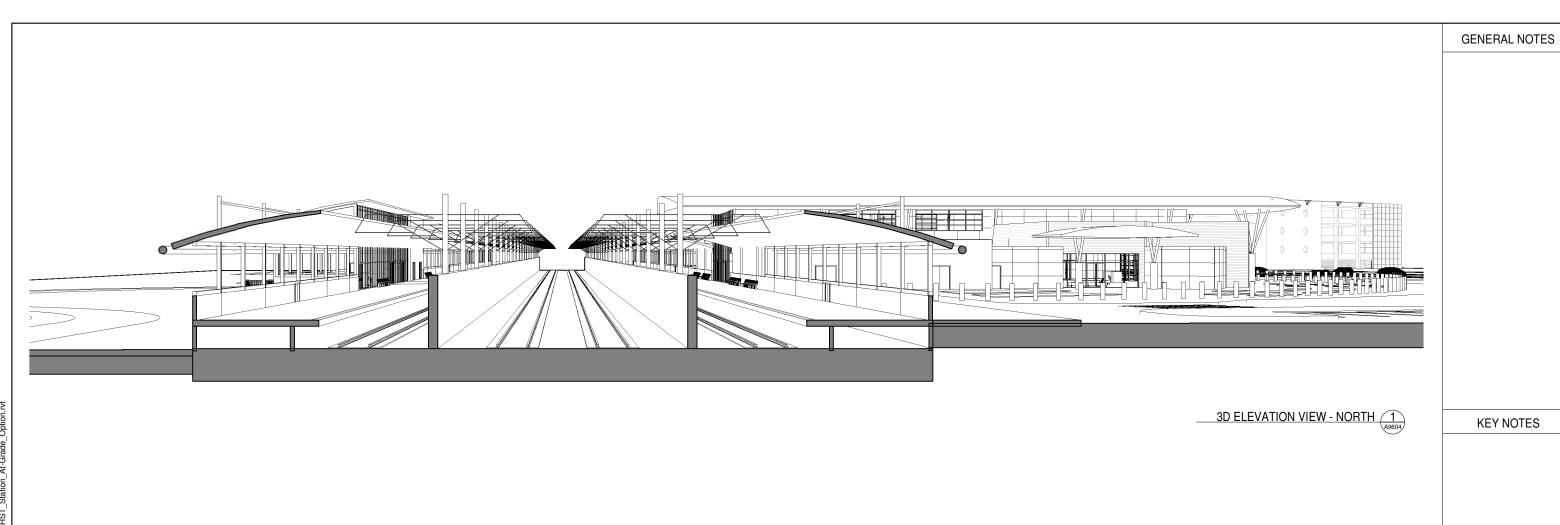

3D ELEVATION VIEW - SOUTH (2) (A9604)

Š								
5							DESIGNED BY E. NAOR	
							DRAWN BY D. BACKMAN	RECORD SET 15% DESIGN SUBMISSION
							CHECKED BY	
							F. KING	NOT FOR
							IN CHARGE E. NAOR	CONSTRUCTION
	REV	DATE	BY	СНК	APP	DESCRIPTION	DATE 05/19/12	

URS HMM ARUP



# CALIFORNIA HIGH-SPEED TRAIN PROJECT


FRESNO TO BAKERSFIELD


HANFORD WEST BYPASS SUBSECTION
ALIGNMENT HW


KINGS / TULARE REGIONAL STATION - WEST ALTERNATIVE (AT GRADE OPTION) 3D ELEVATION VIEWS


CONTRACT NO.
HSR 06-0003
DRAWING NO.
A9604
SCALE
SHEET NO.
14 OF 14


**KEY NOTES** 

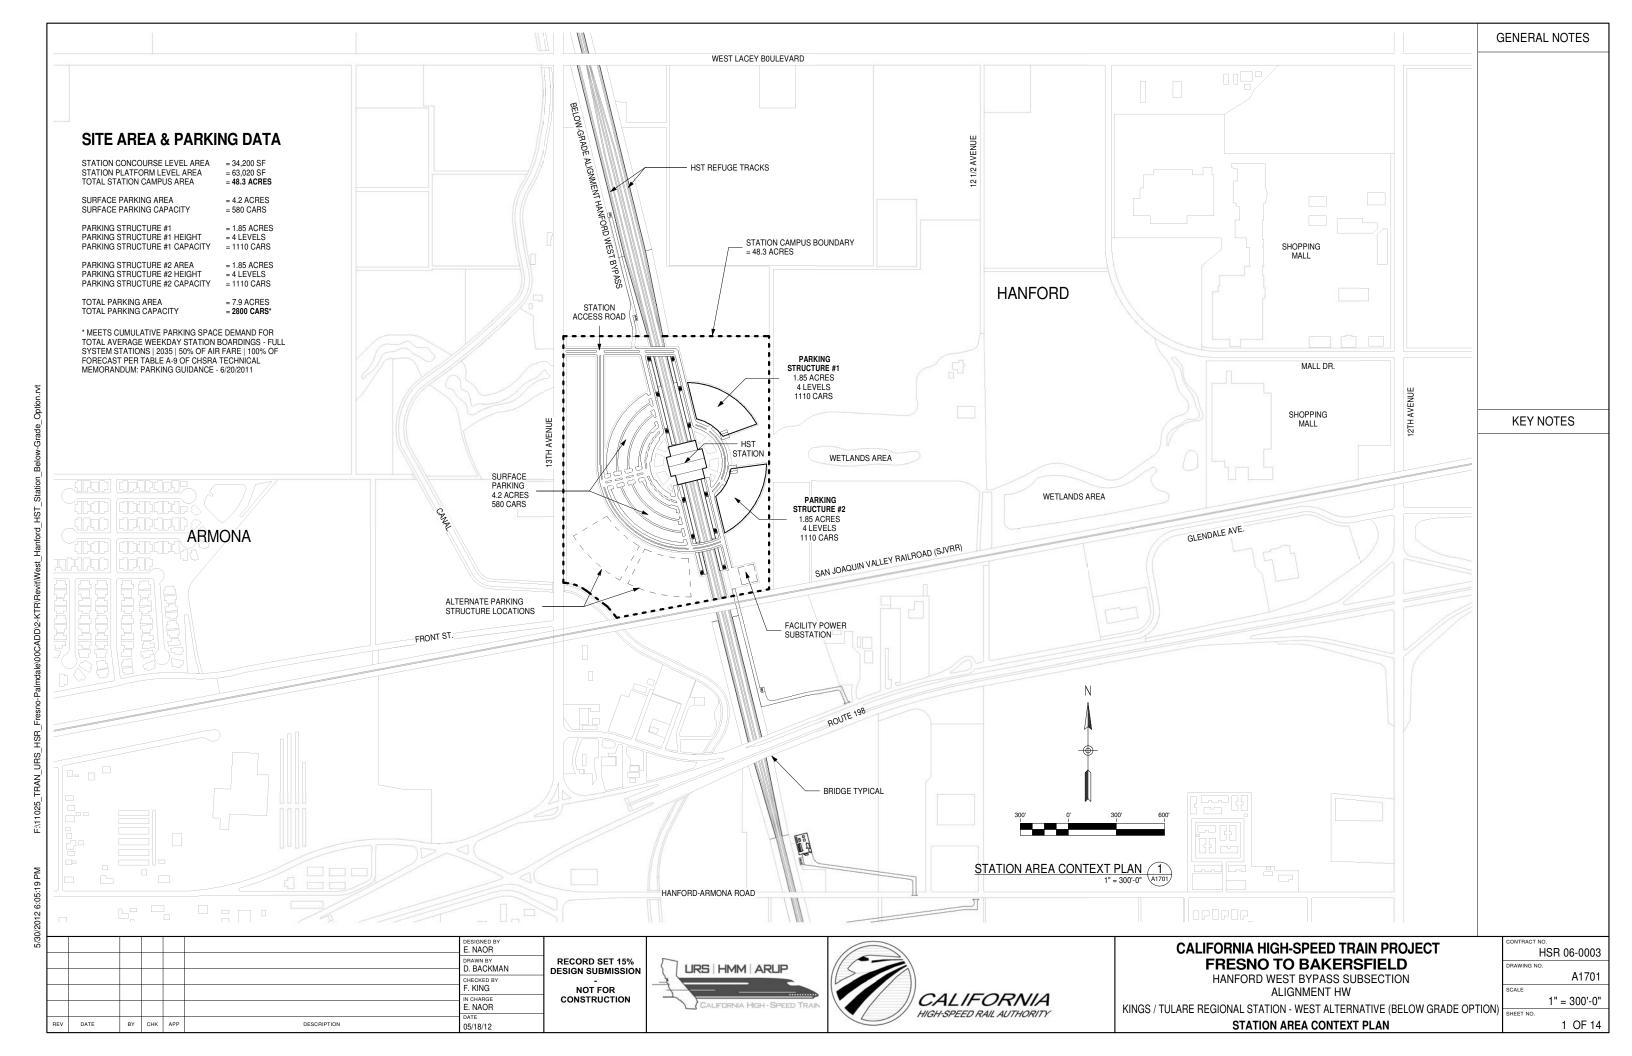


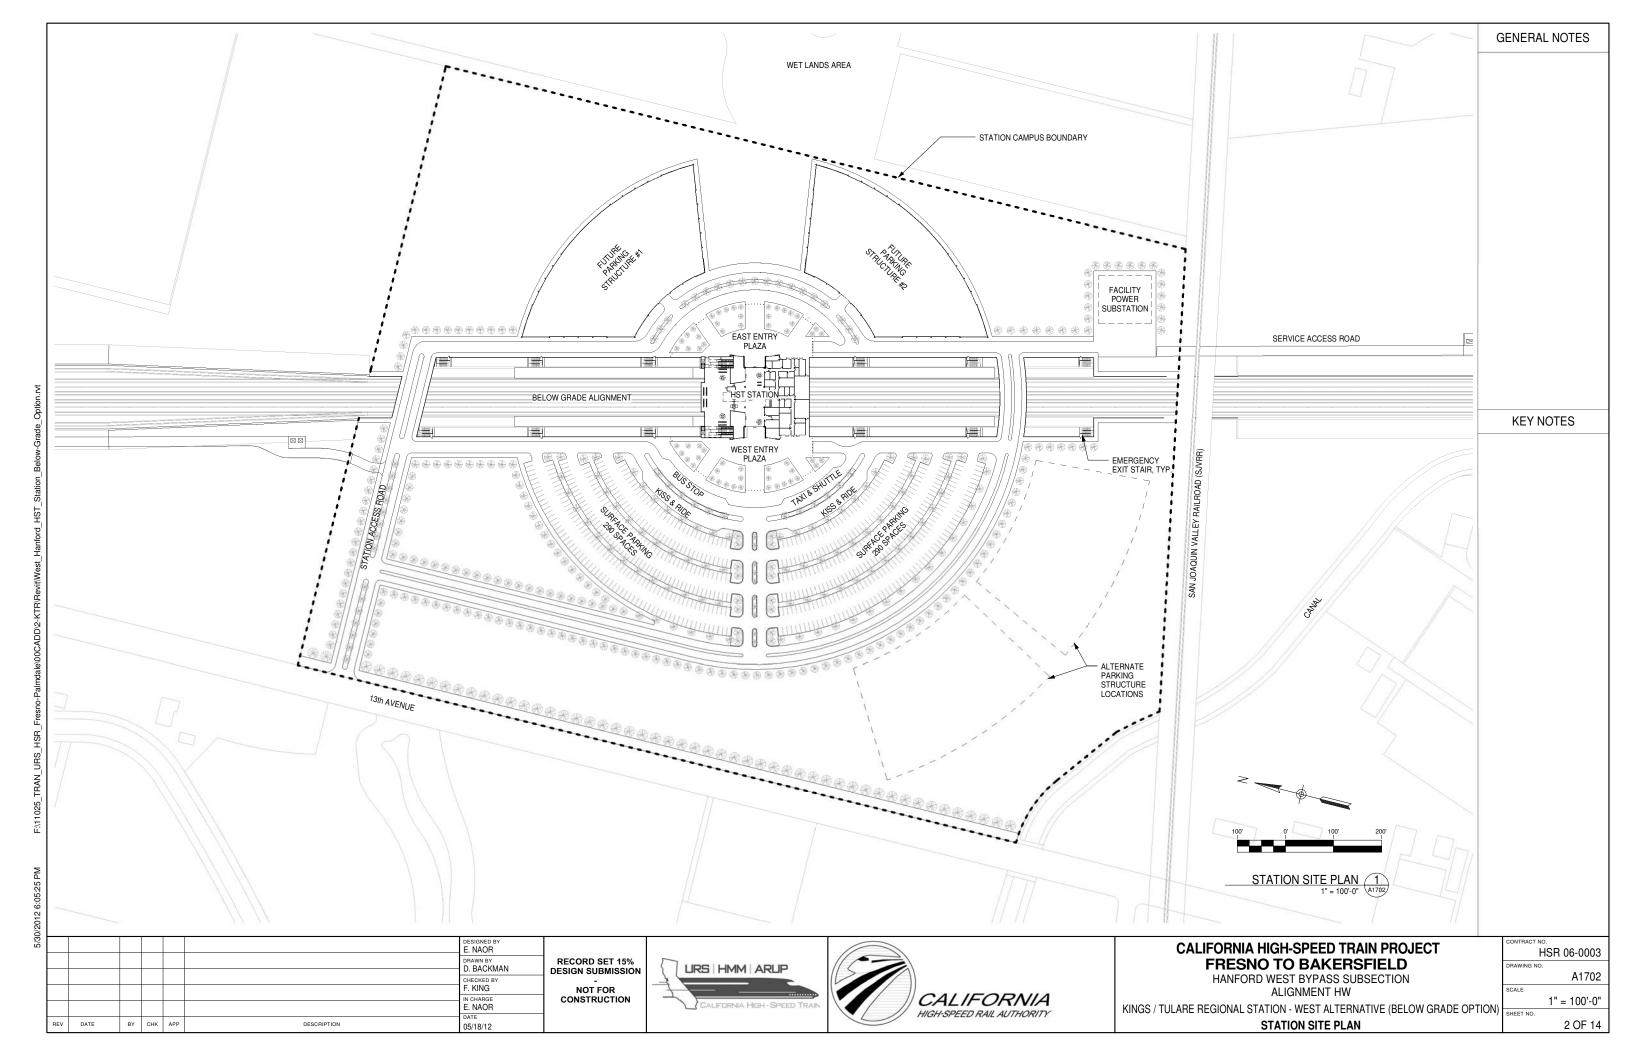


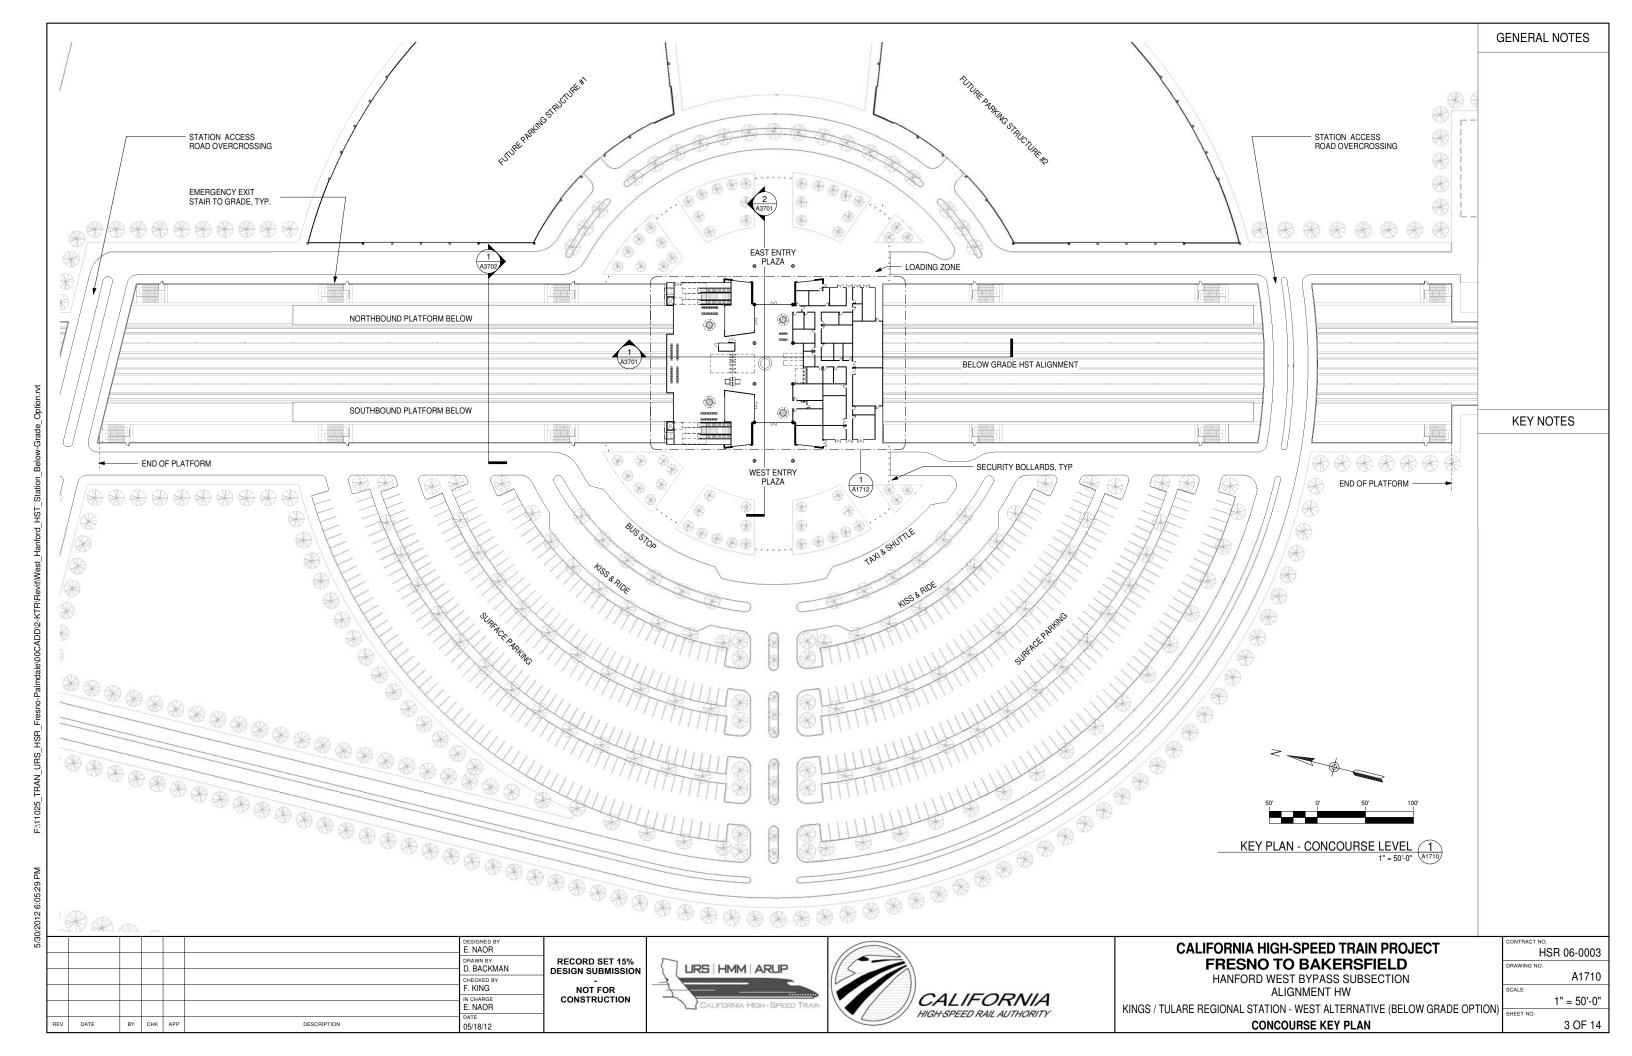


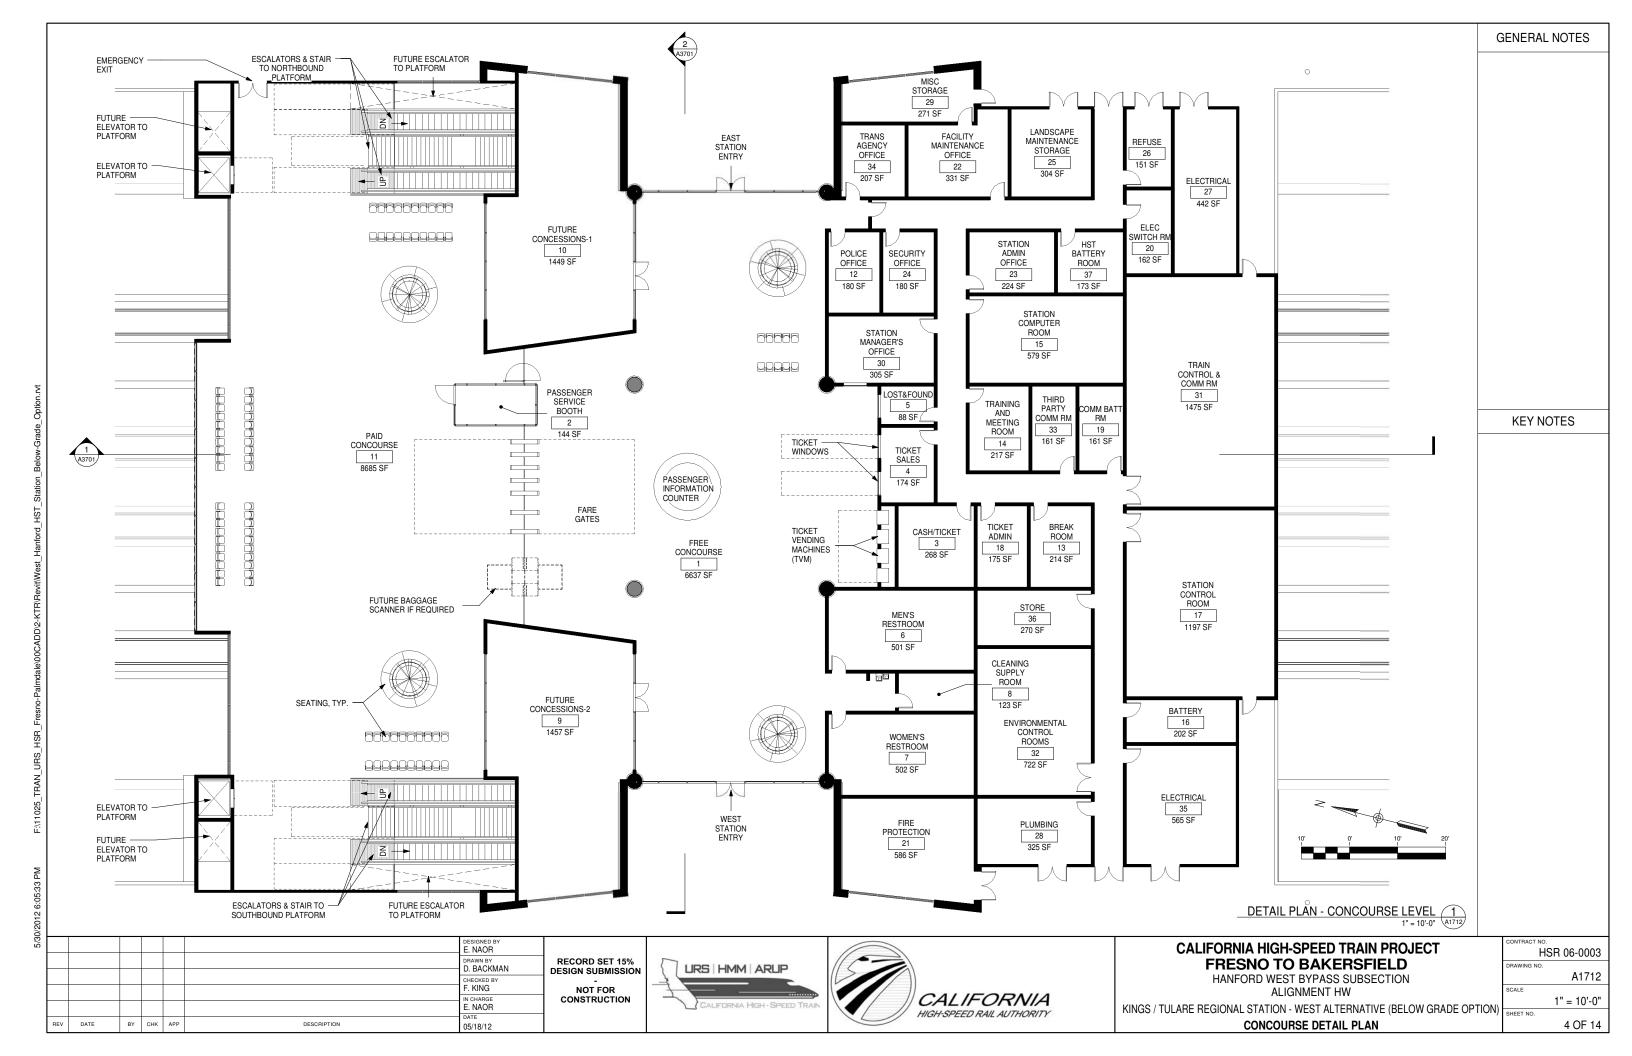


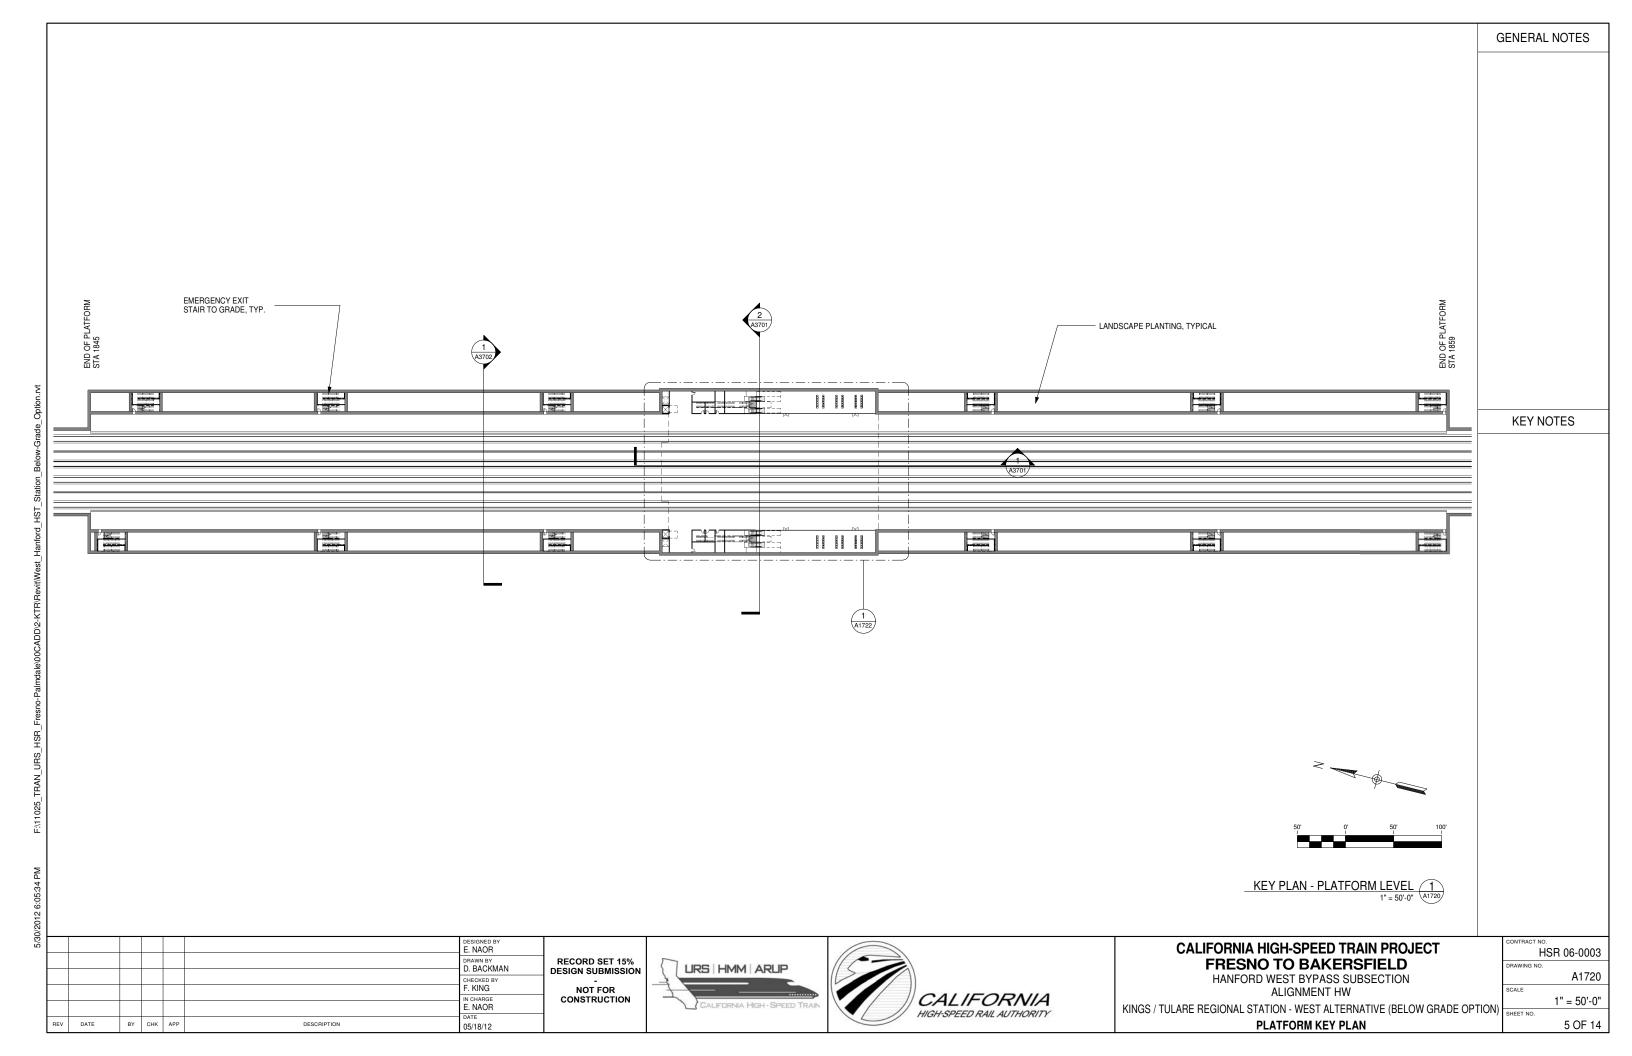

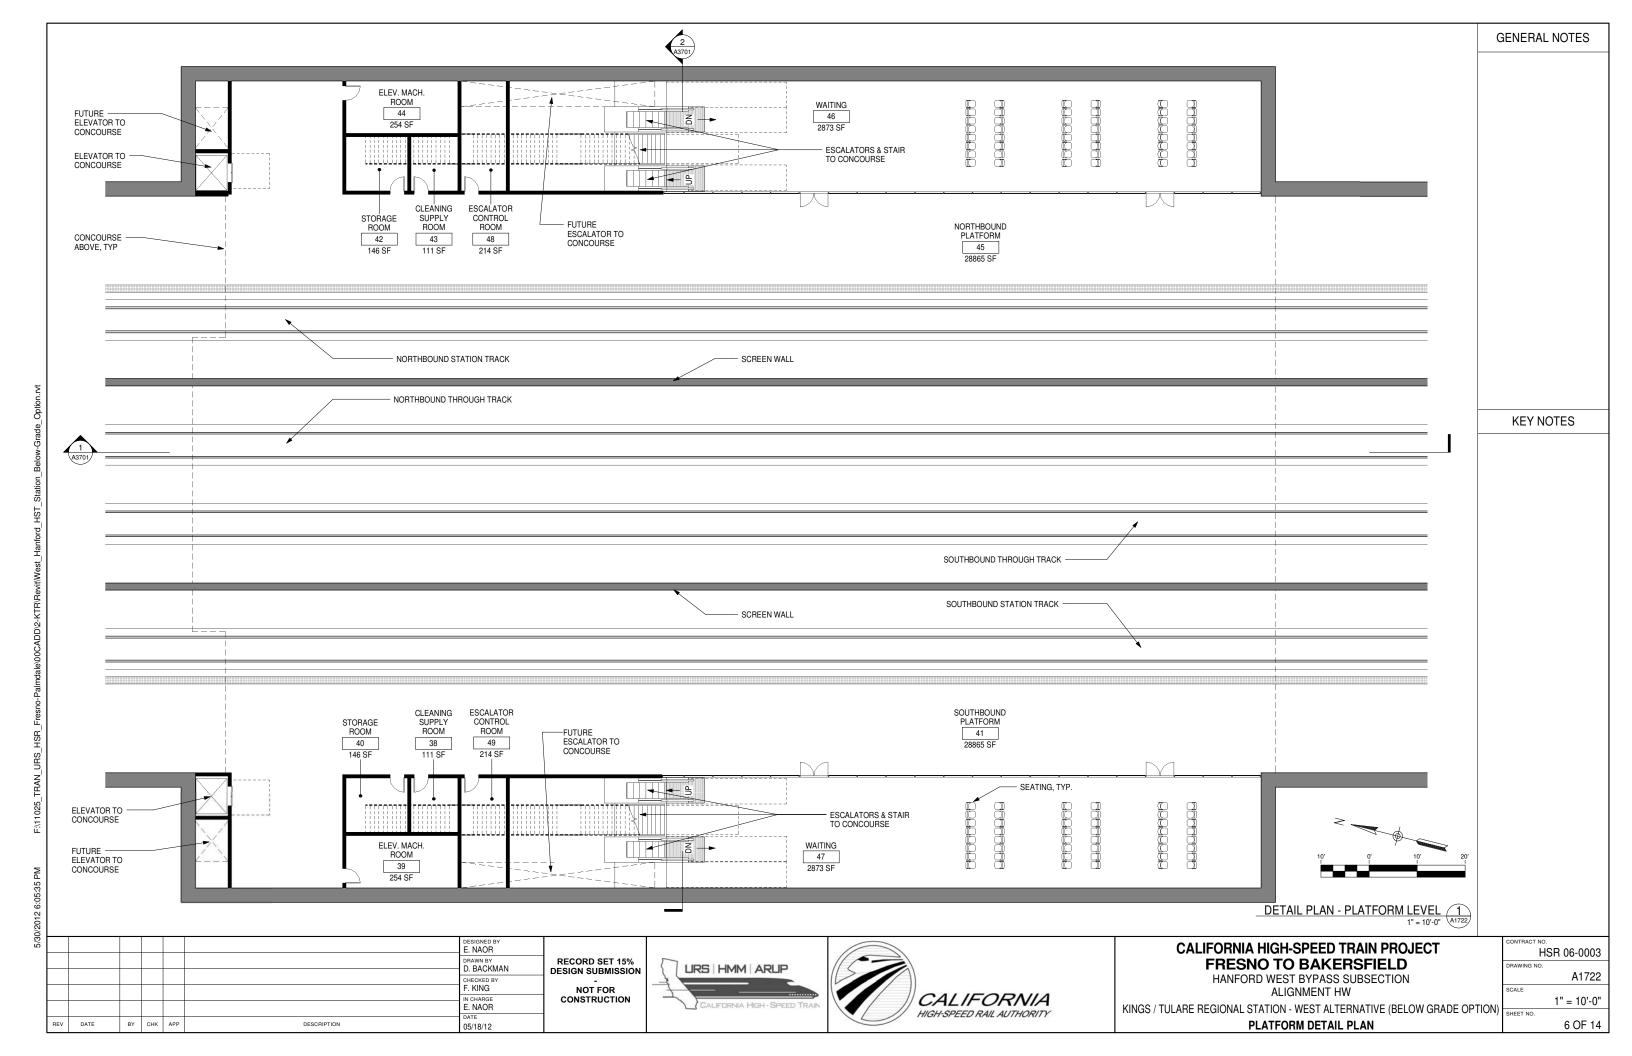

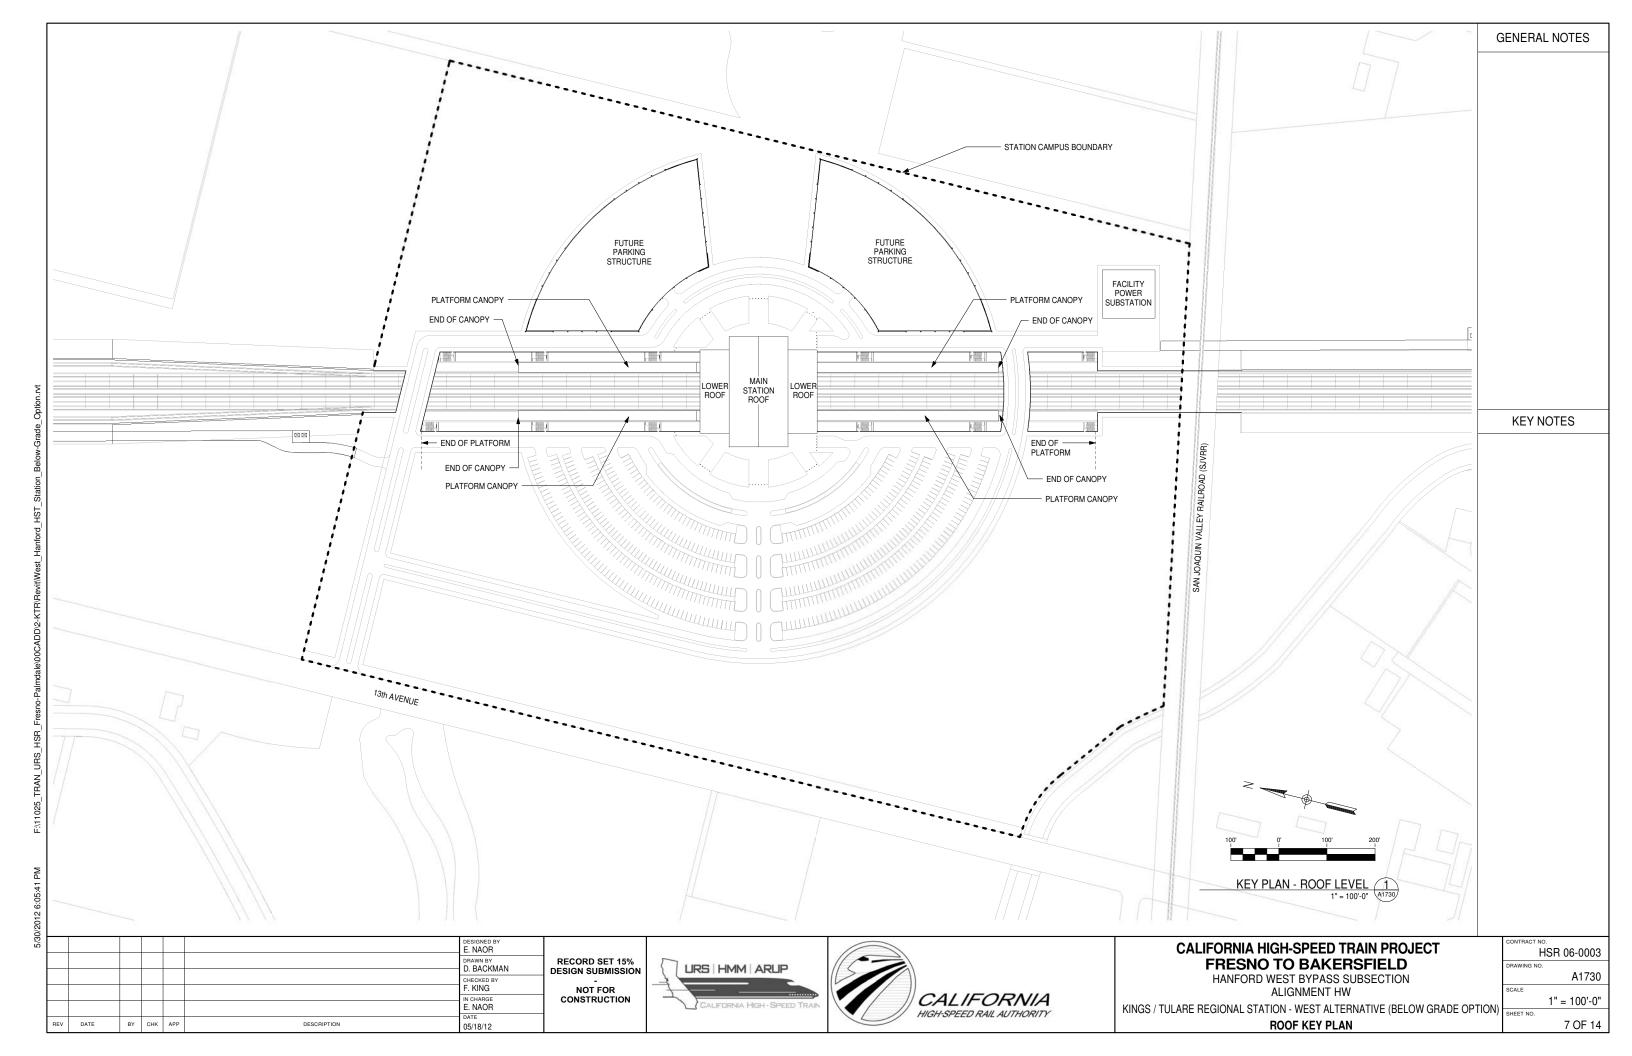

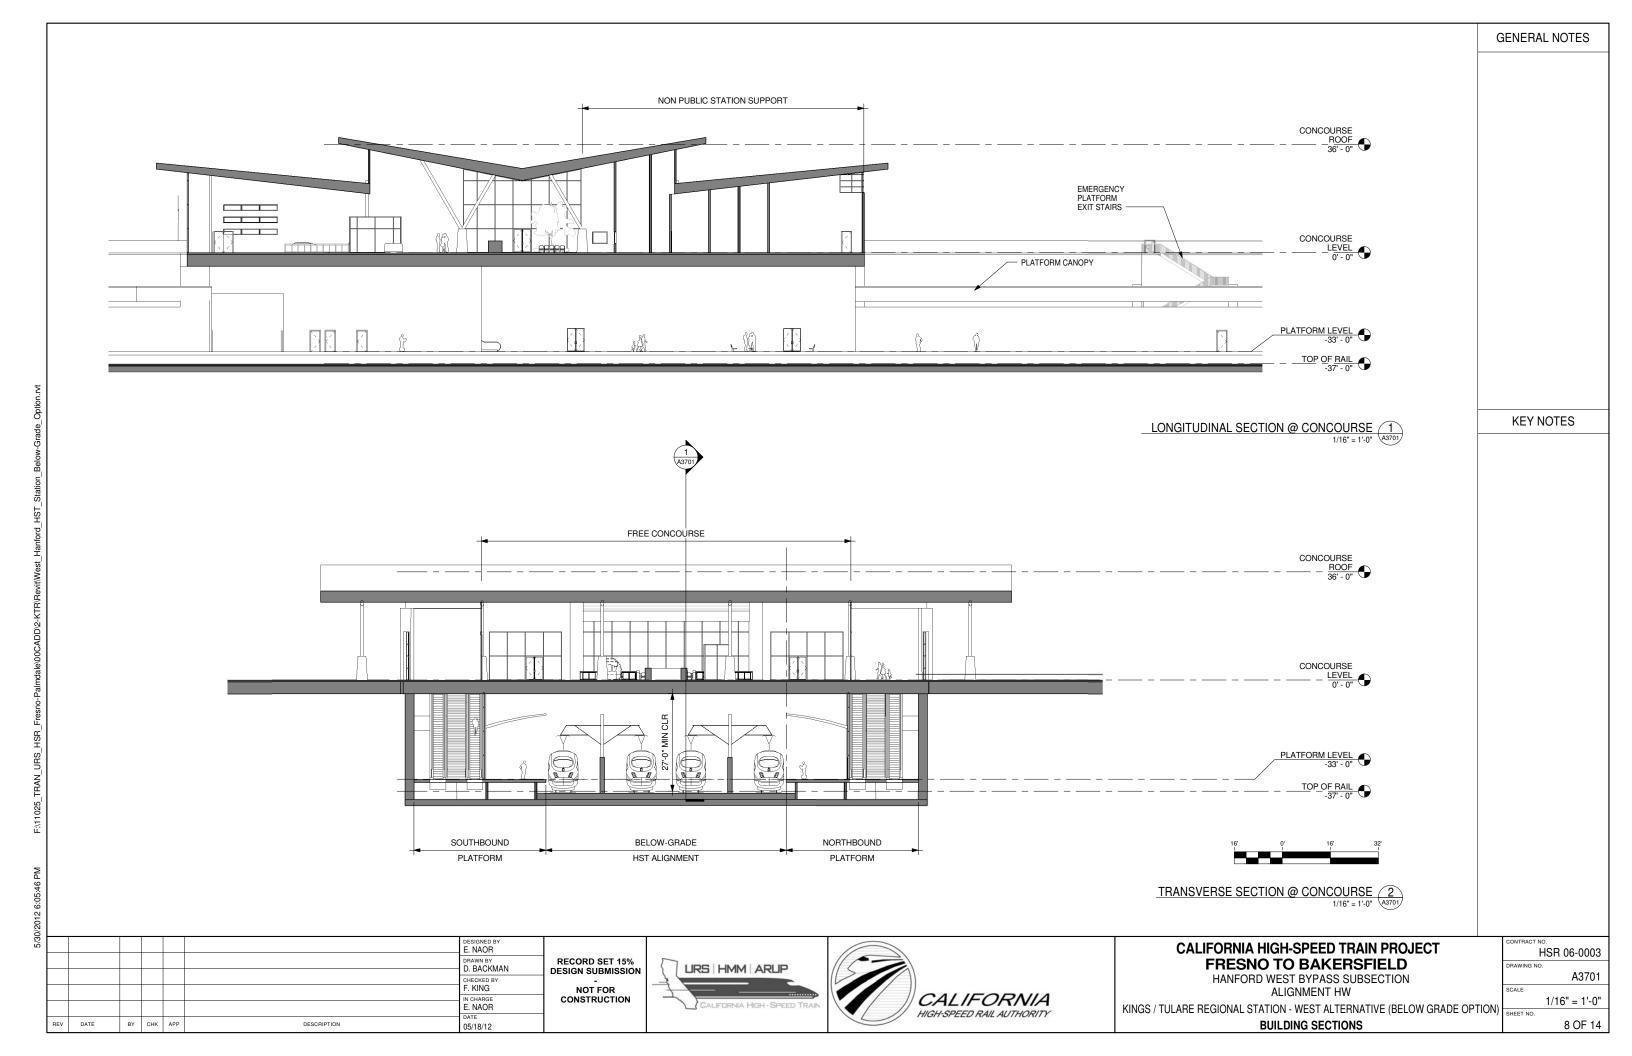

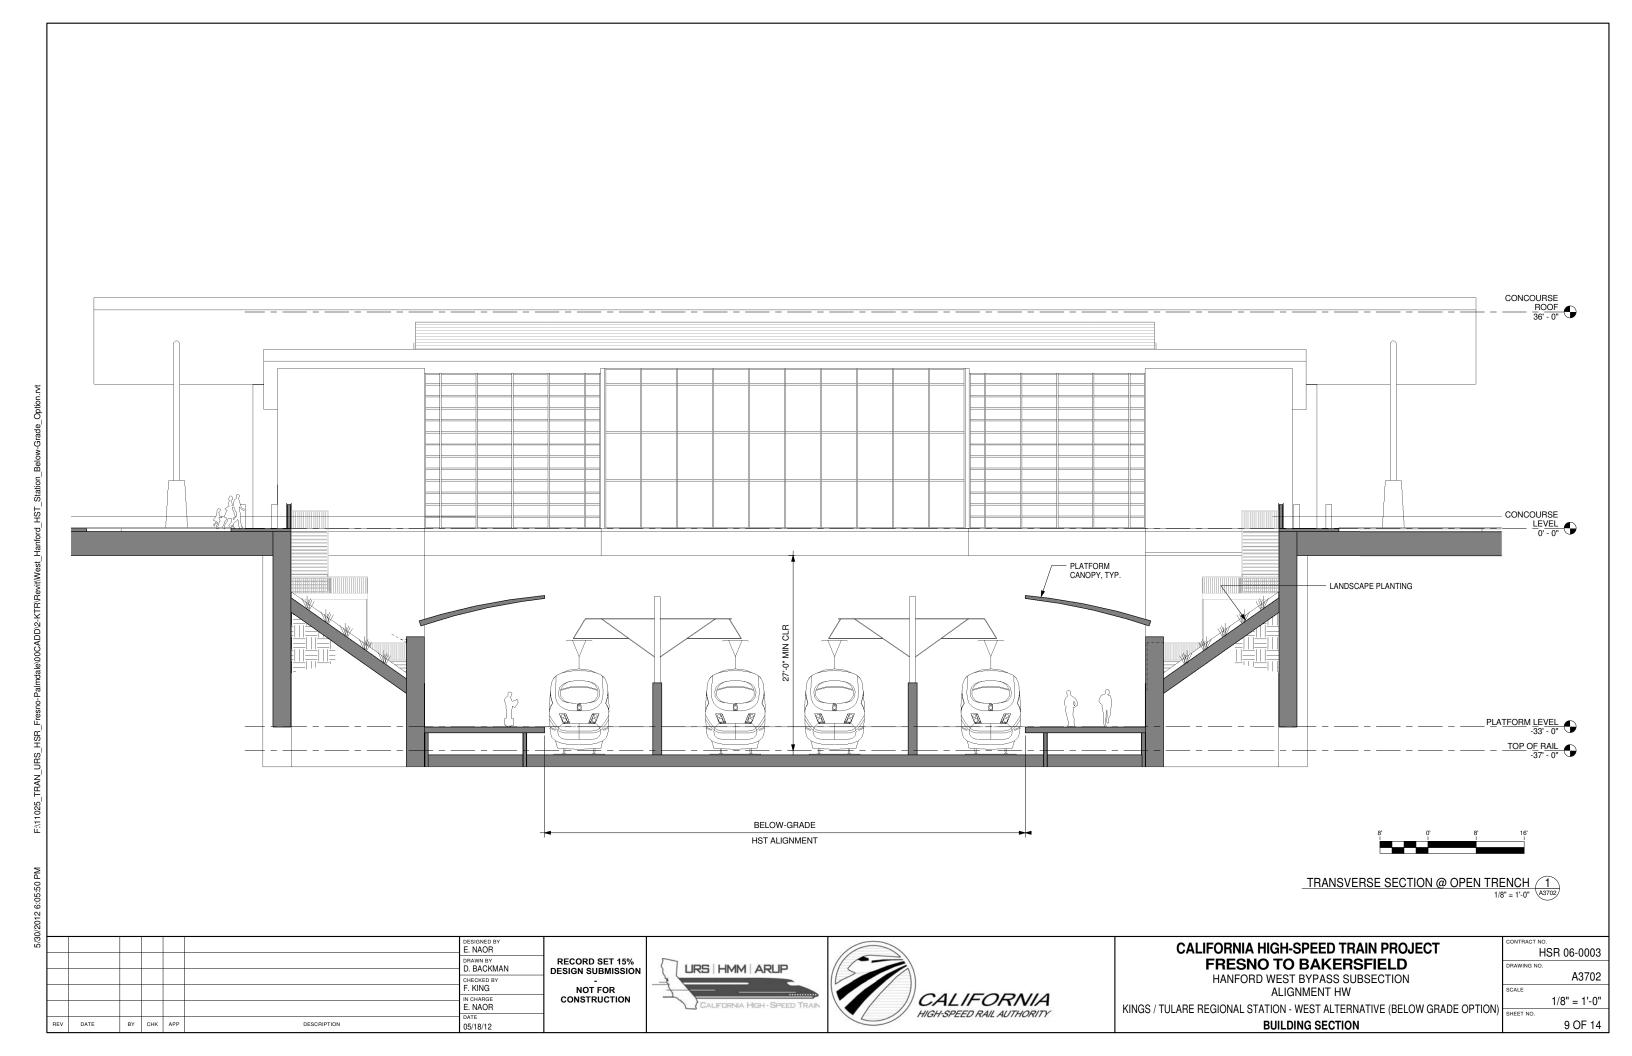

## **ROOM SCHEDULE**

			REQUIRED		TM 2.2.2.	
No.	ROOM NAME	AREA	AREA	FORMULA	REFERENCE	COMMENTS
	EDEE COMPONENT		1	T. 1. 00 *		
1	FREE CONCOURSE	6637 SF			6.3.2	
2	PASSENGER SERVICE BOOTH	144 SF	200.05		6.6.2.3	
3	CASH/TICKET	268 SF	260 SF		6.6.3.8	
4	TICKET SALES	174 SF	150 SF		6.6.2.2	Two windows
5	LOST&FOUND	88 SF	80 SF		6.6.2.5	
6	MEN'S RESTROOM	501 SF		'	6.3.4	
7	WOMEN'S RESTROOM	502 SF			6.3.4	
8	CLEANING SUPPLY ROOM	123 SF	80 SF		6.6.4.2	
	FUTURE CONCESSIONS-2	1457 SF	1500 SF		6.3.5	
10	FUTURE CONCESSIONS-1	1449 SF	1500 SF		6.3.5	
11	PAID CONCOURSE	8685 SF			6.3.3	
12	POLICE OFFICE	180 SF	160 SF		6.6.2.6	
13	BREAK ROOM	214 SF	200 SF		6.6.3.12	
14	TRAINING AND MEETING ROOM	217 SF	200 SF		6.6.3.4	
15	STATION COMPUTER ROOM	579 SF	500 SF		6.6.3.6	
16	BATTERY	202 SF	200 SF		6.6.6.2	
17	STATION CONTROL ROOM	1197 SF	1100 SF		6.6.3.5	
18	TICKET ADMIN	175 SF	160 SF		6.6.3.7	
19	COMM BATT RM	161 SF	160 SF		6.6.7.1	
20	ELEC SWITCH RM	162 SF	160 SF		6.6.7.2	
21	FIRE PROTECTION	586 SF			6.6.6.3	
22	FACILITY MAINTENANCE OFFICE	331 SF	330 SF		6.6.3.10	
	STATION ADMIN OFFICE	224 SF	200 SF		6.6.3.2	
24	SECURITY OFFICE	180 SF	160 SF		6.6.3.9	
	LANDSCAPE MAINTENANCE STORAGE	304 SF			6.6.4.4	
26	REFUSE	151 SF	150 SF		6.6.4.1	
	ELECTRICAL	442 SF	450 SF		6.6.6.2	
	PLUMBING	325 SF			6.6.6.4	
	MISC STORAGE	271 SF	300 SF		6.6.4.5	
	STATION MANAGER'S OFFICE	305 SF	270 SF		6.6.3.3	
31	TRAIN CONTROL & COMM RM	1475 SF	1280 SF		6.6.7.1	
_	ENVIRONMENTAL CONTROL ROOMS	722 SF	1200 01		6.6.6.1	
33	THIRD PARTY COMM RM	161 SF	160 SF		6.6.7.1	
	TRANS AGENCY OFFICE	207 SF	100 01		6.6.3.16	
	ELECTRICAL	565 SF	450 SF		6.6.6.2	
36	STORE	270 SF	150 SF		6.6.4.3	
37	HST BATTERY ROOM	173 SF	160 SF		6.6.7.2	
38	CLEANING SUPPLY ROOM	111 SF	80 SF		6.6.4.2	
	ELEV. MACH. ROOM	254 SF	00 SF		6.5.3.6	
40	STORAGE ROOM	146 SF	100 SF		6.6.4.3	
_	SOUTHBOUND PLATFORM	28865 SF	100 31		0.0.4.3	
	STORAGE ROOM	146 SF	100 SF	25 min sf per boarding passenger *	6642	
43		146 SF			6.6.4.3 6.6.4.2	
43	CLEANING SUPPLY ROOM		80 SF			
	ELEV. MACH. ROOM	254 SF	-		6.5.3.6	
45	NORTHBOUND PLATFORM	28865 SF	1	25 min sf per boarding passenger *	0000	
46	WAITING	2873 SF	-		6.3.3.2	
47	WAITING	2873 SF		Table 6-2 *	6.3.3.2	
48	ESCALATOR CONTROL ROOM	214 SF				
49	ESCALATOR CONTROL ROOM	214 SF				

\* STATION PUBLIC AREAS AND VERTICAL CIRCULATION ARE SIZED FOR PEAK PASSENGER FORCAST FOR FULL BUILD OUT (2035) AT 50% AIR FARES AS PROVIDED IN STATION AREA PARKING GUIDANCE TECHNICAL MEMORANDUM REV 4, DATED 6/20/2011

PEAK CUMULATIVE DAILY BOARDINGS OF 3,300 PASSENGERS

PEAK HOUR BOARDINGS (P60B) OF 495 PASSENGERS

						DESIGNED BY E. NAOR	
						D. BACKMAN	R
						CHECKED BY F. KING	]
						IN CHARGE E. NAOR	] '
REV	DATE	BY	СНК	APP	DESCRIPTION	05/18/12	
REV	DATE	ВУ	СНК	APP	DESCRIPTION	DATE	

RECORD SET 15%
DESIGN SUBMISSION
NOT FOR
CONSTRUCTION





## CALIFORNIA HIGH-SPEED TRAIN PROJECT FRESNO TO BAKERSFIELD


HANFORD WEST BYPASS SUBSECTION ALIGNMENT HW


KINGS / TULARE REGIONAL STATION - WEST ALTERNATIVE (BELOW GRADE OPTION)


ROOM SCHEDULE


CONTRACT NO.
HSR 06-0003
DRAWING NO.
A6701
SCALE


10 OF 14

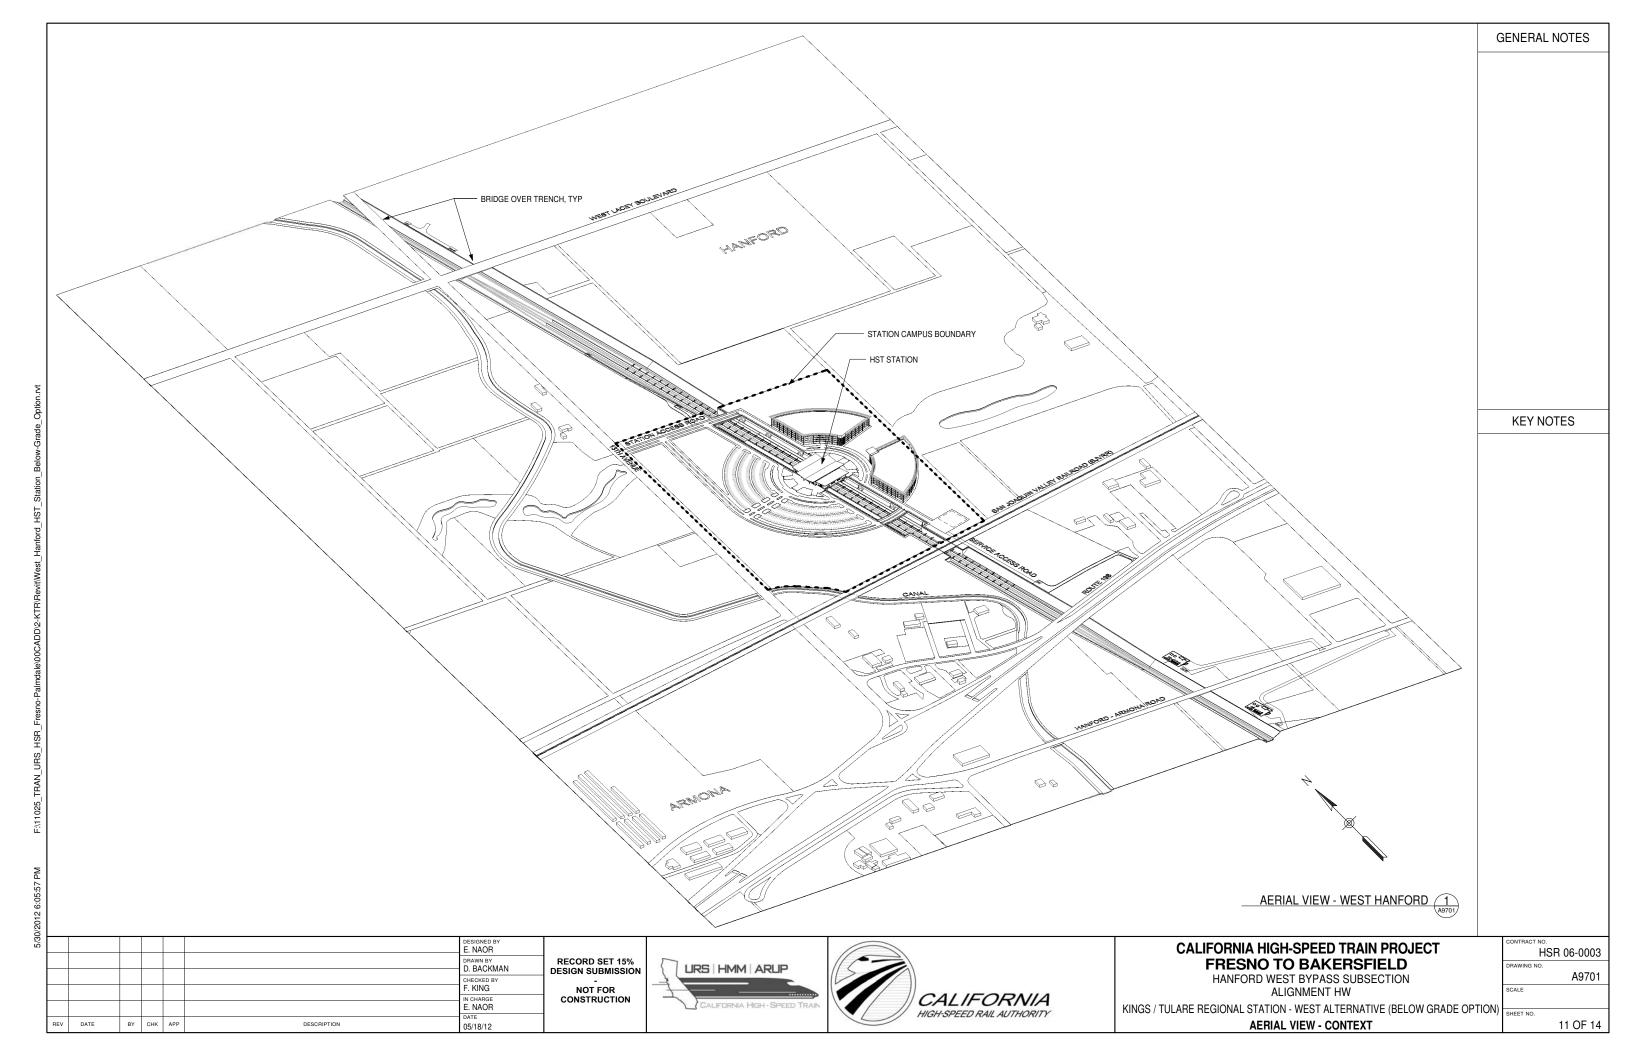


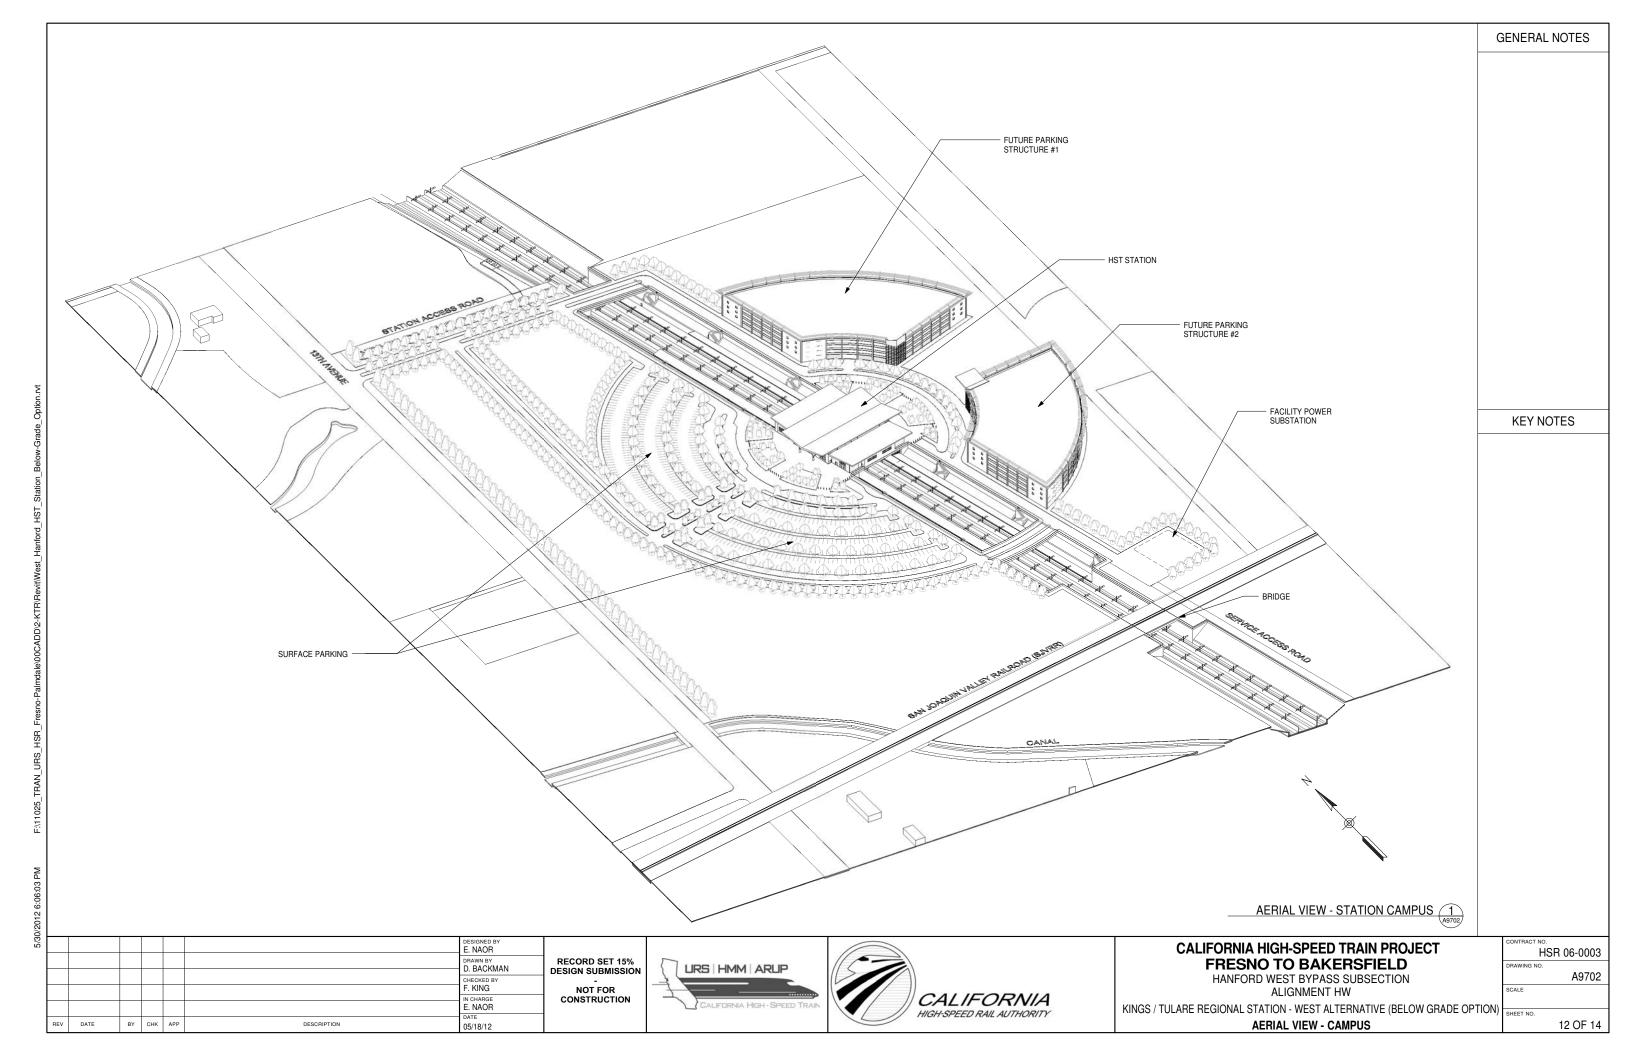


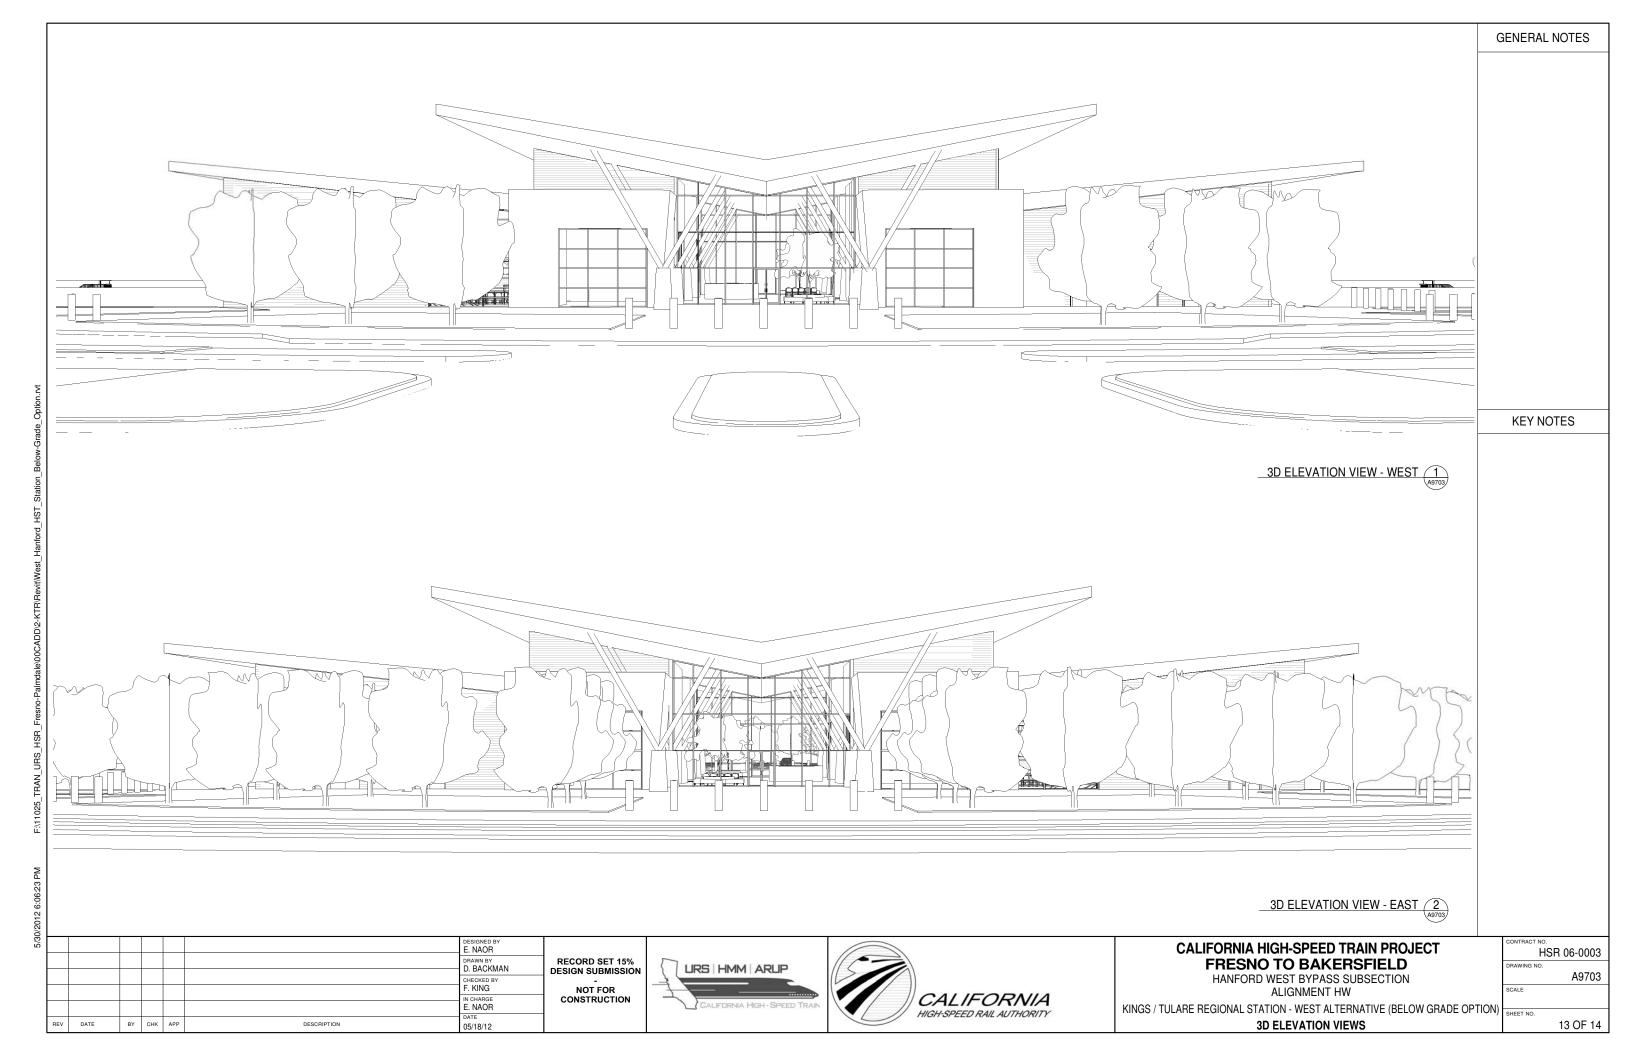


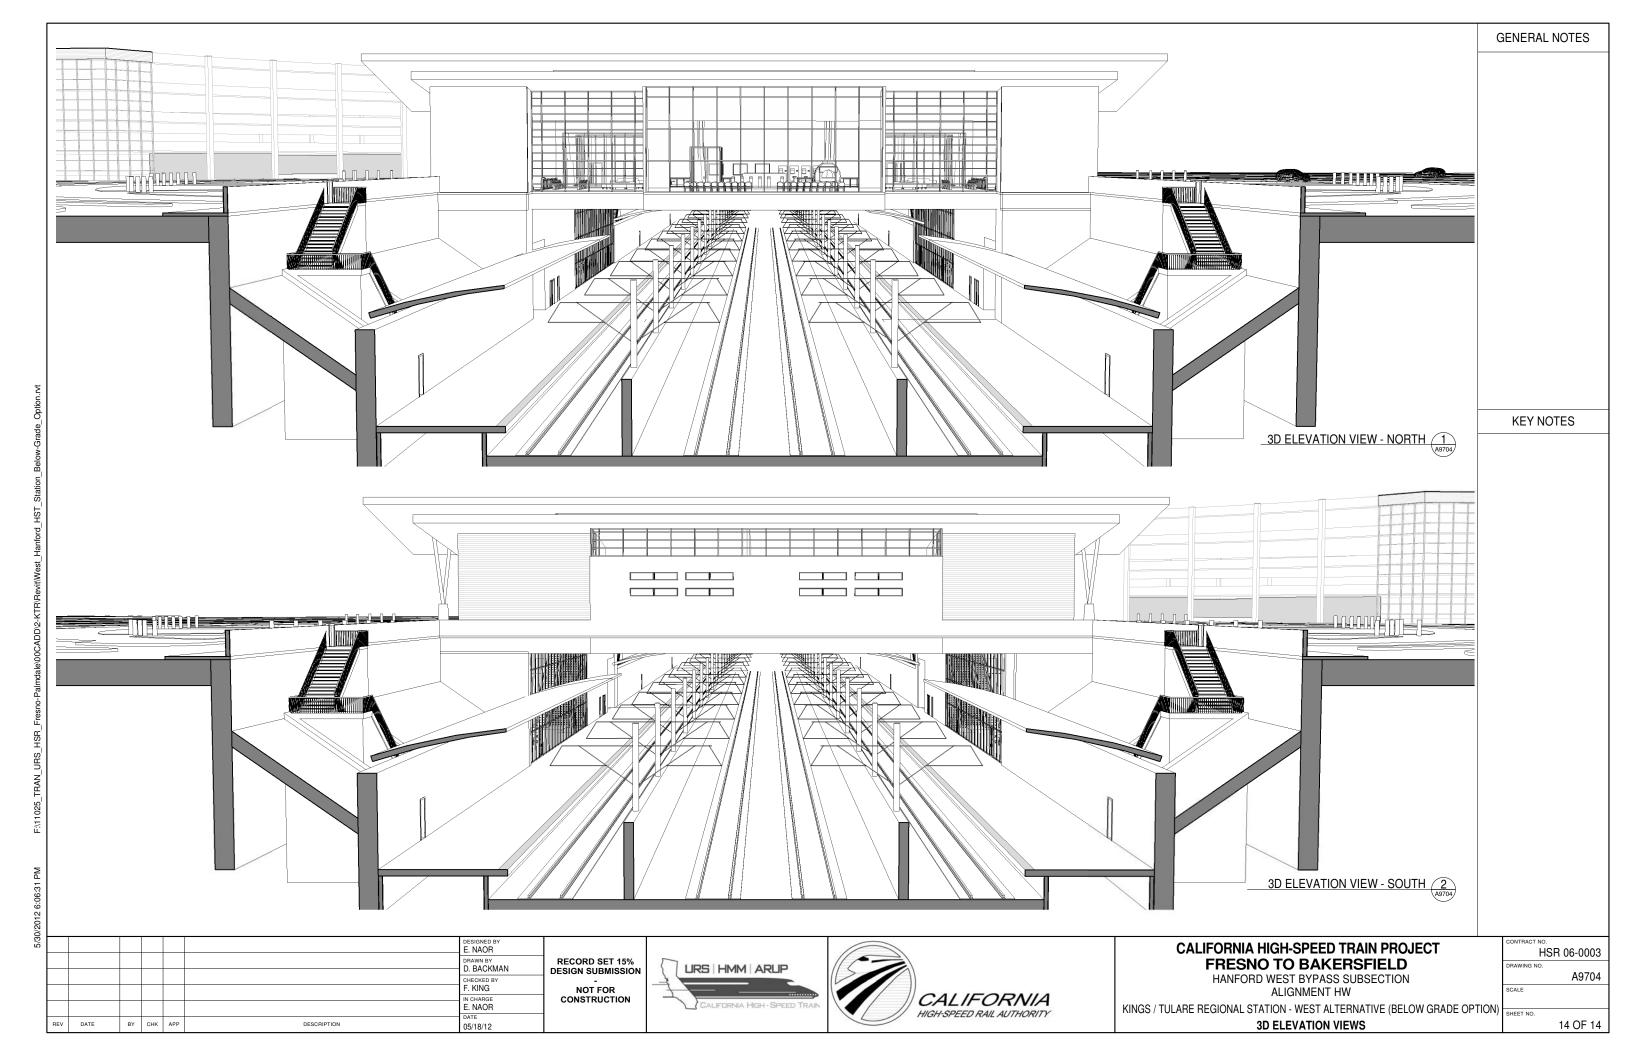


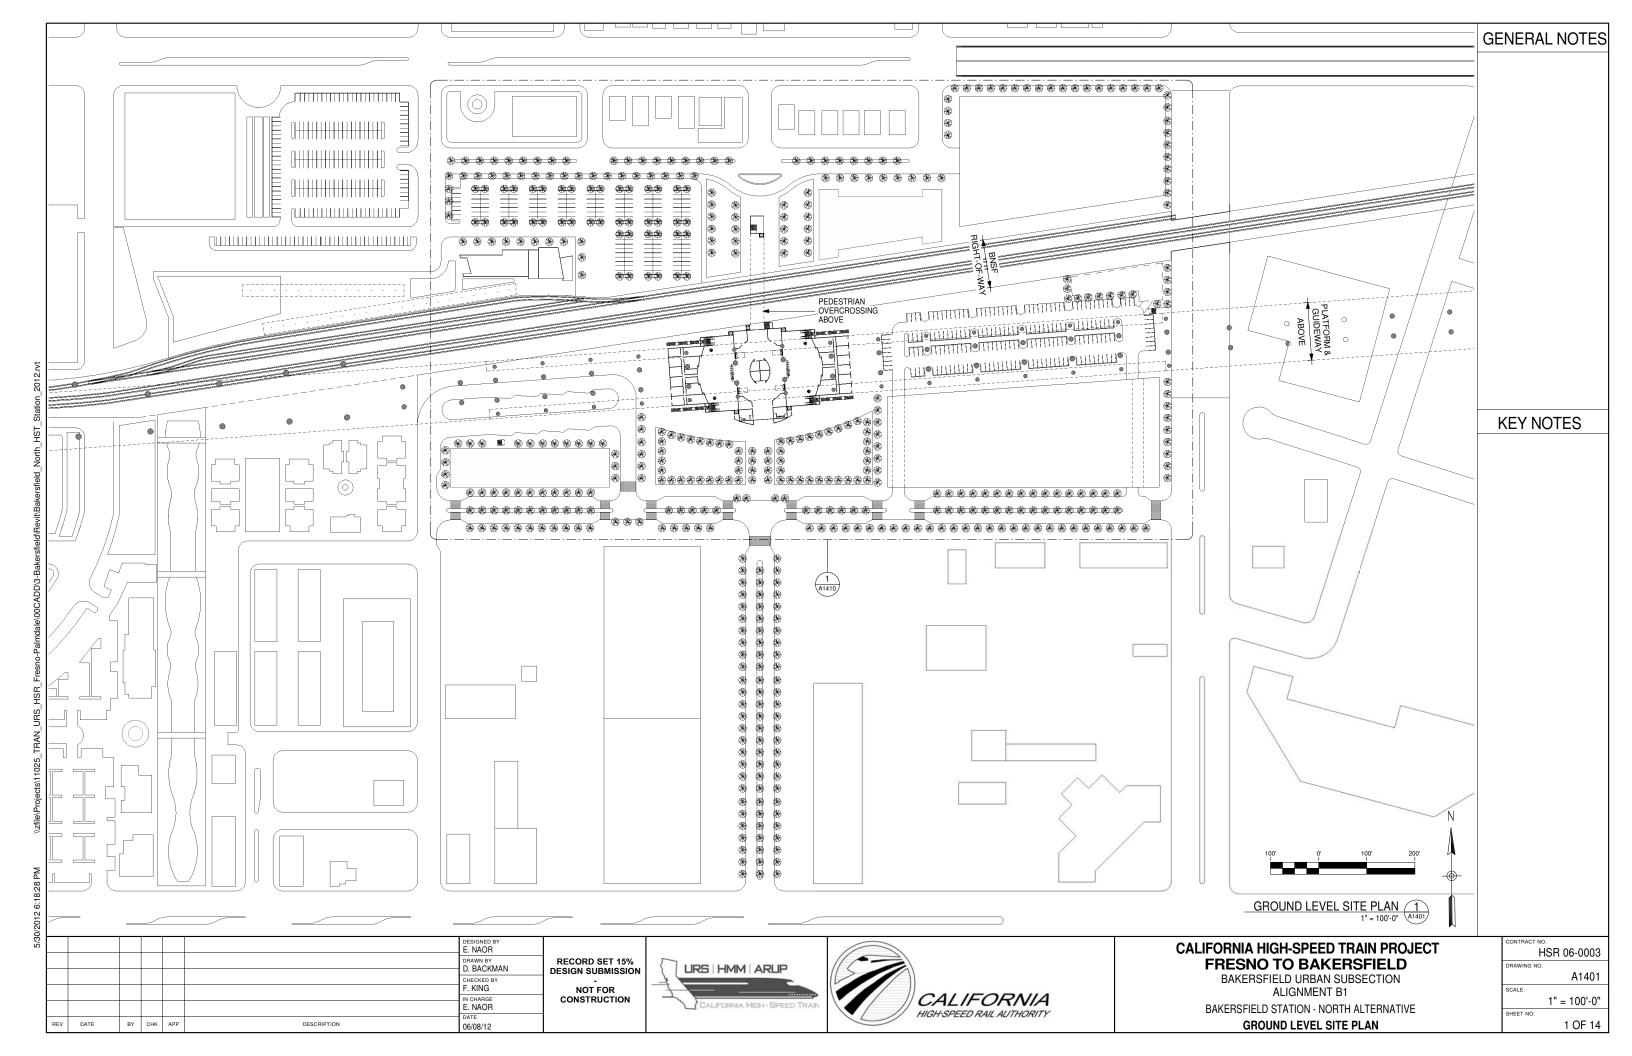


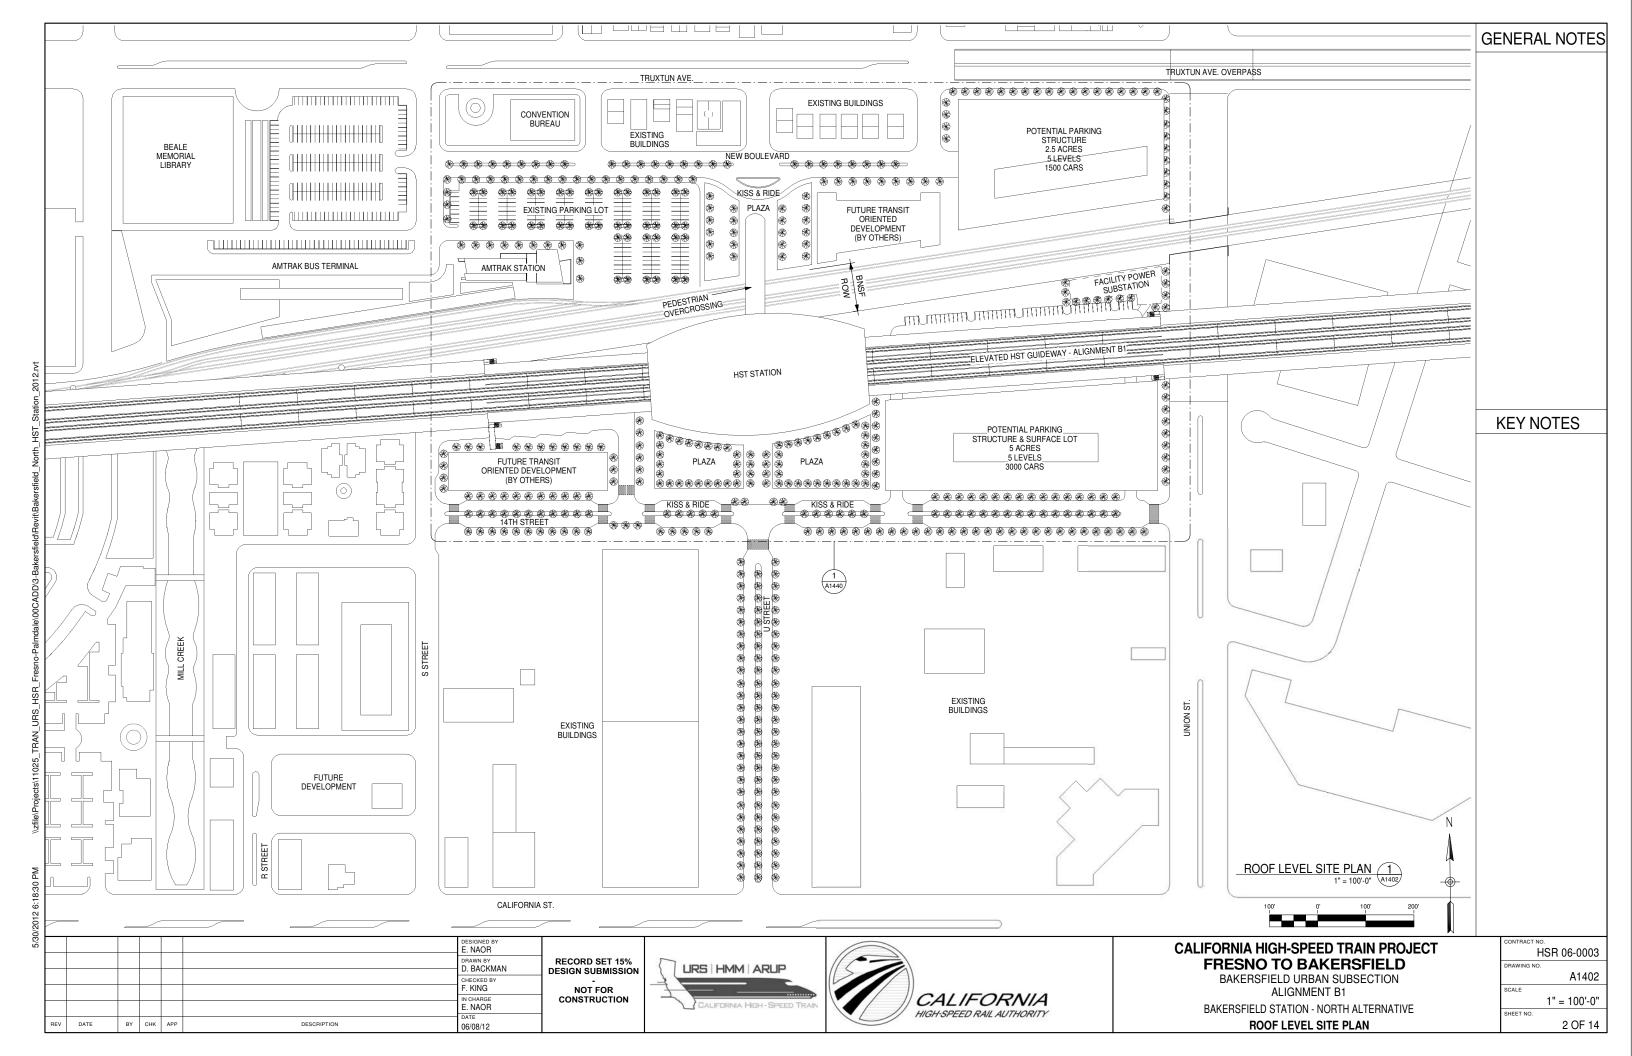


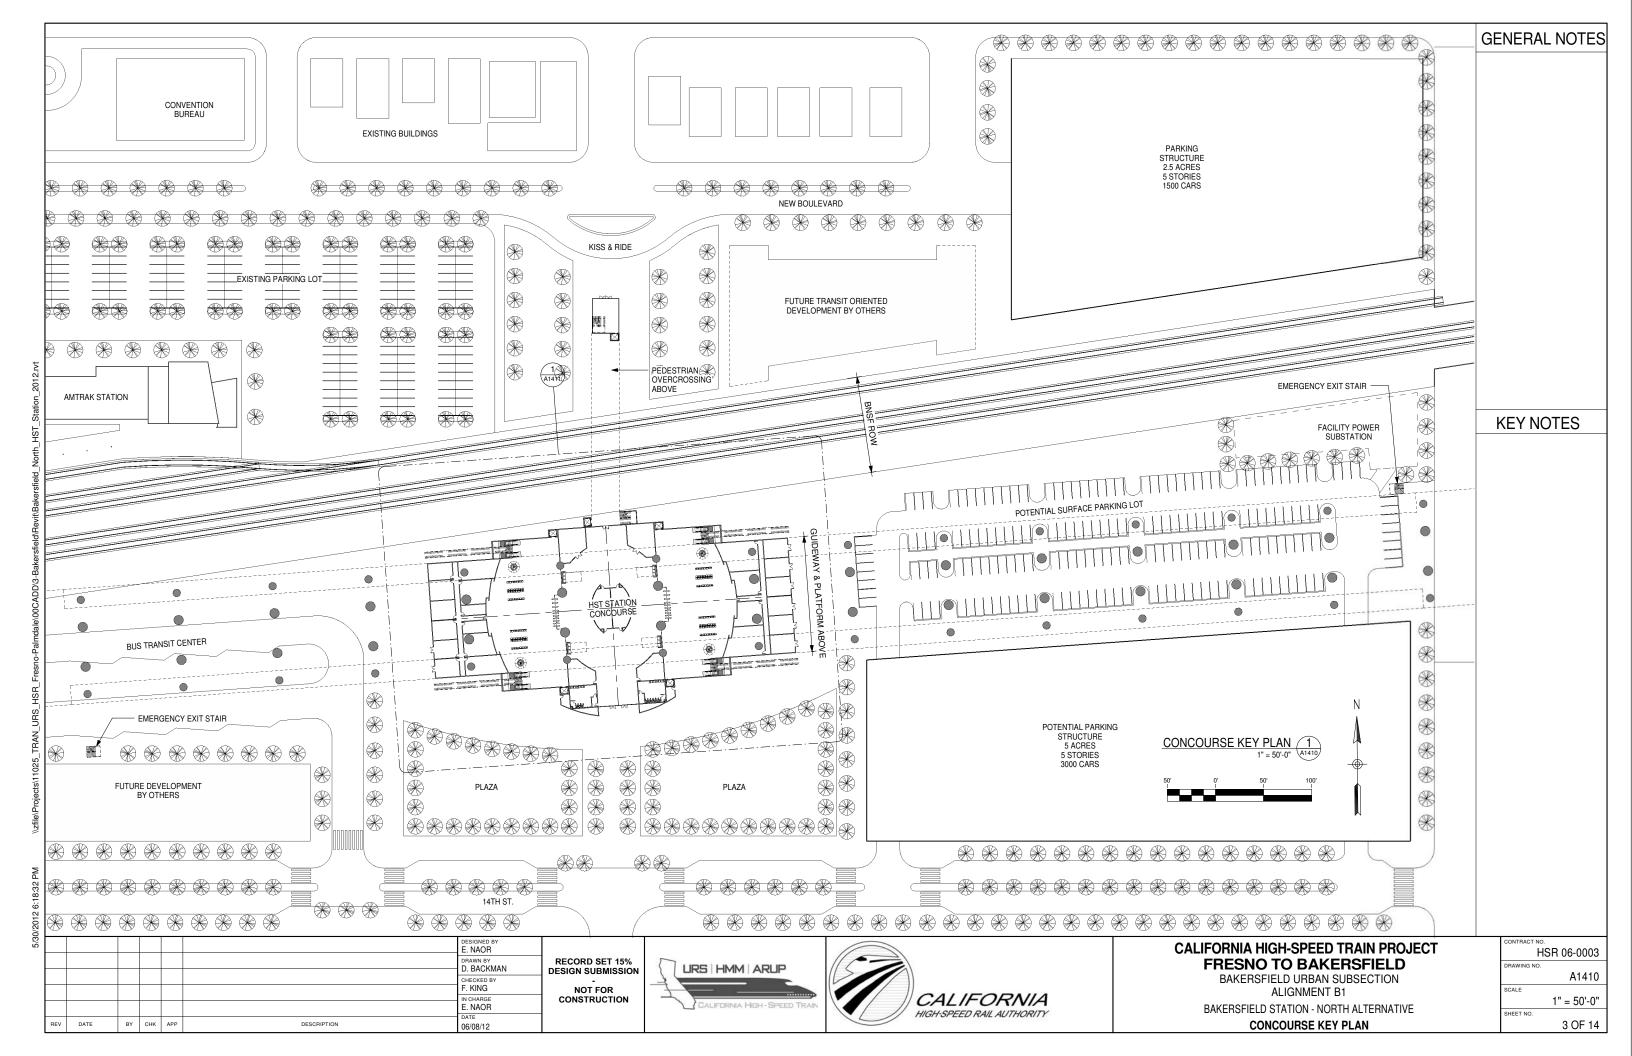


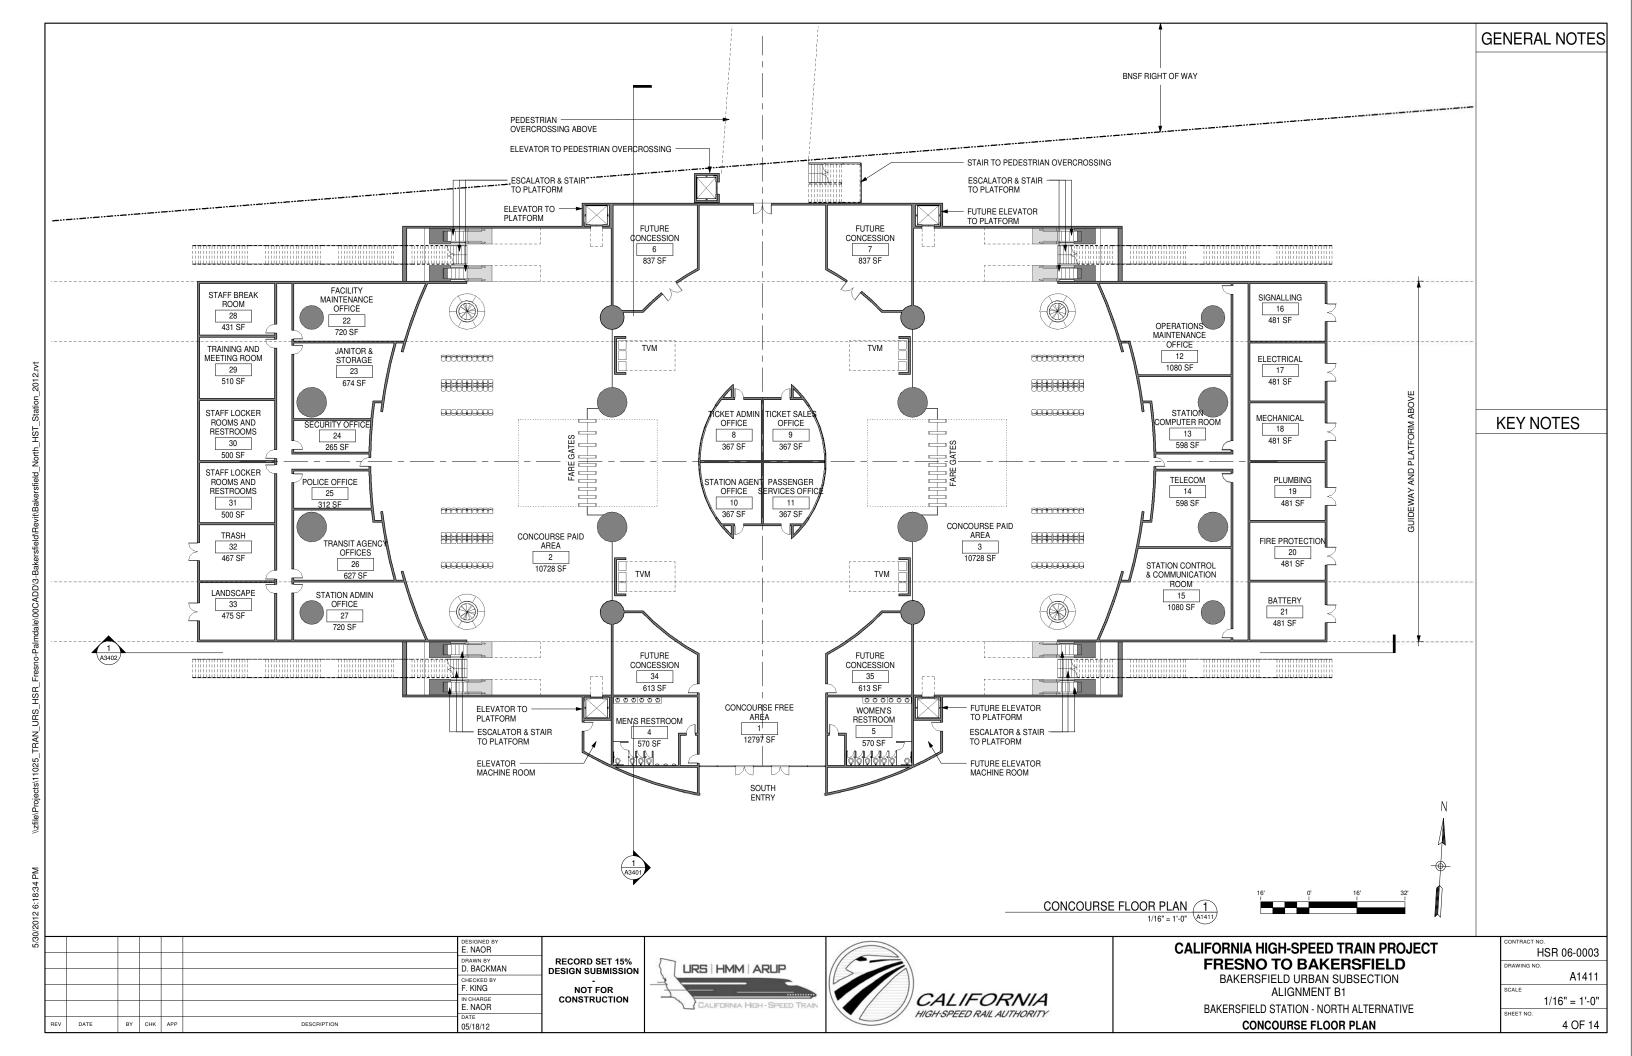


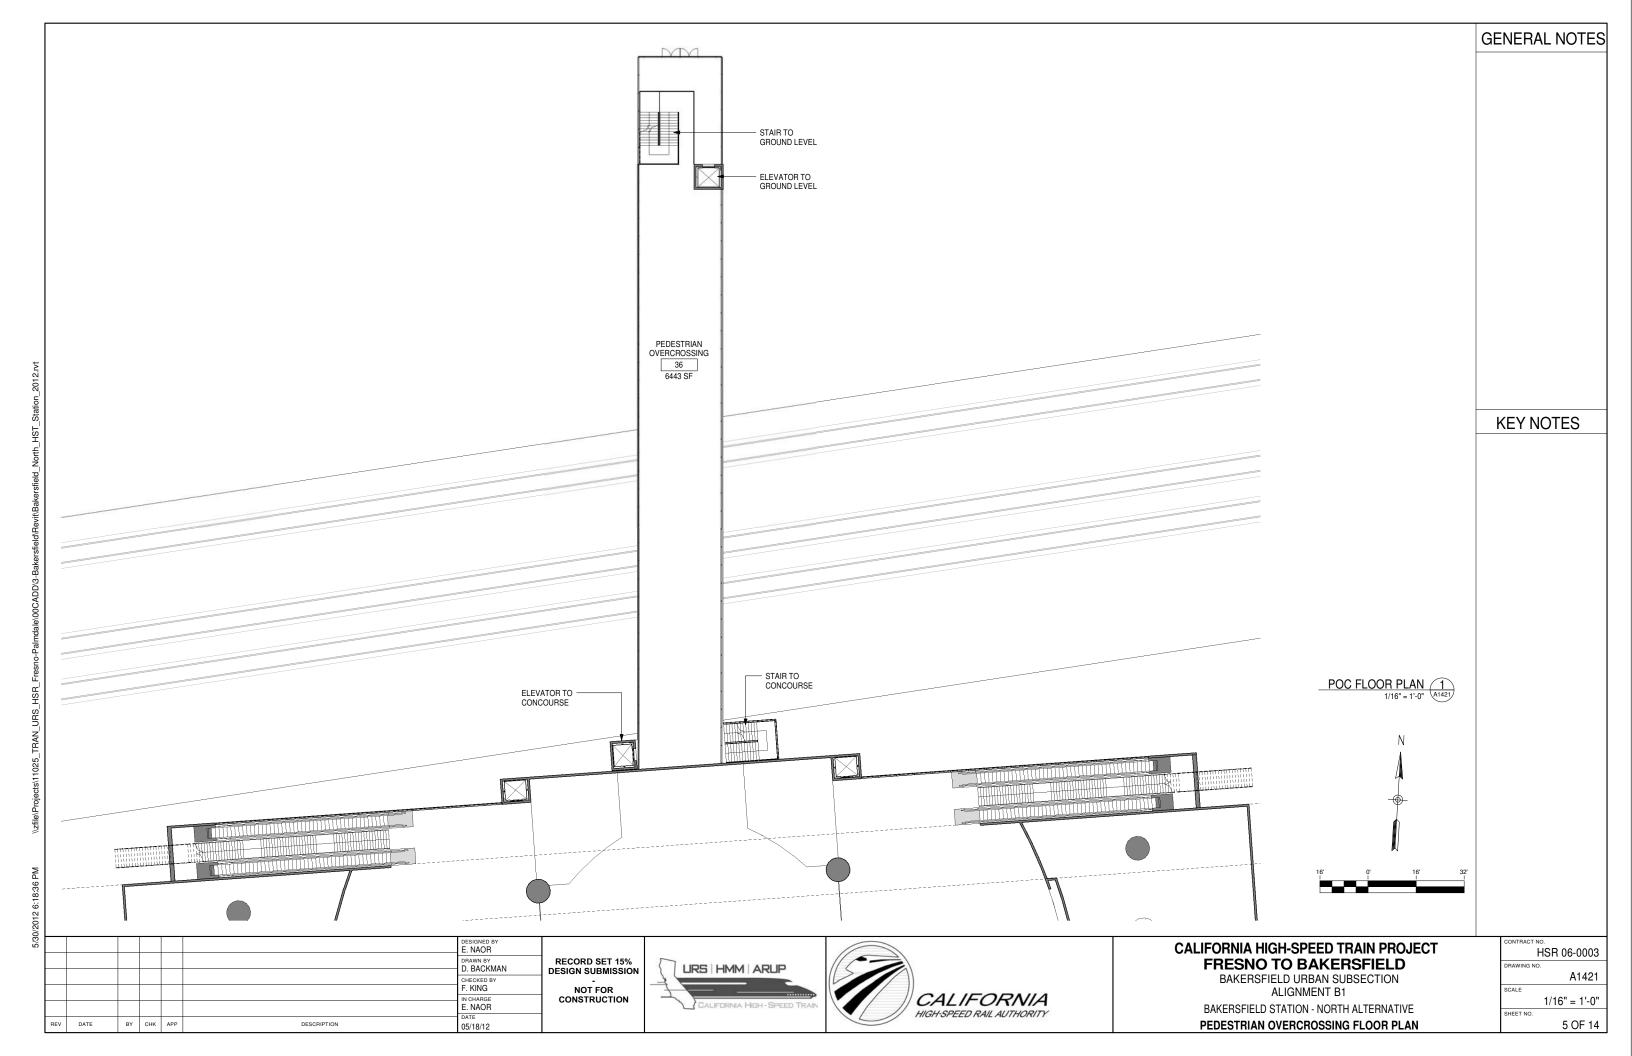


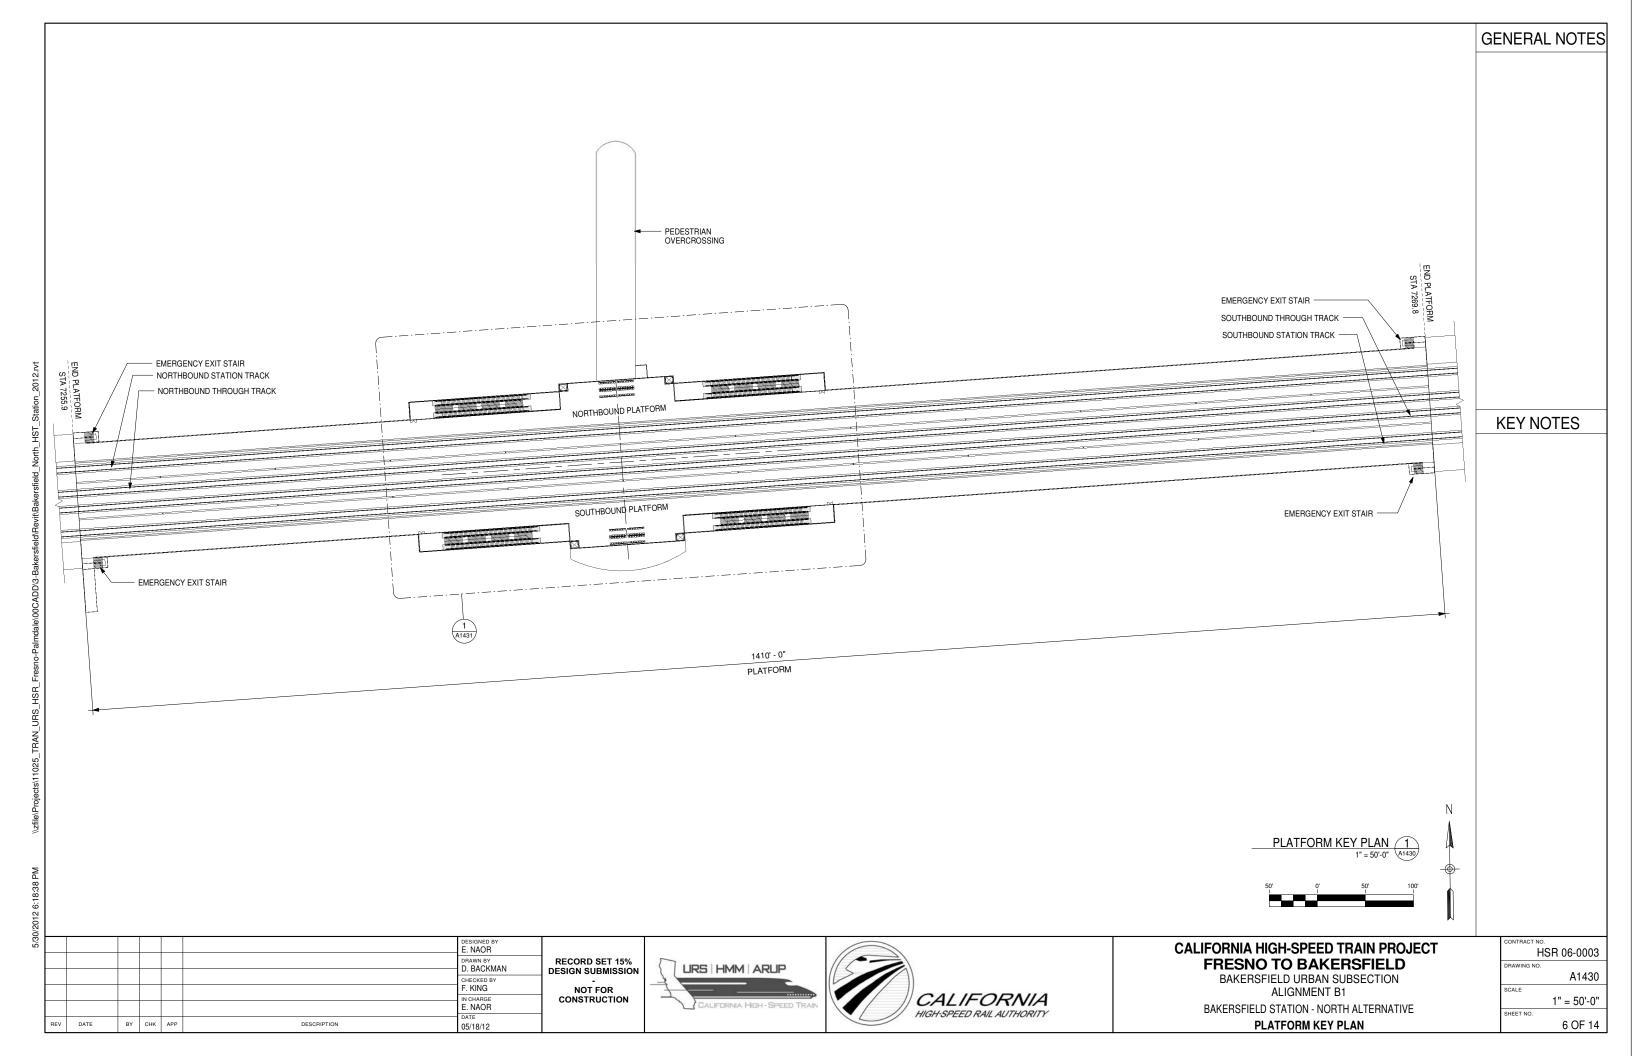

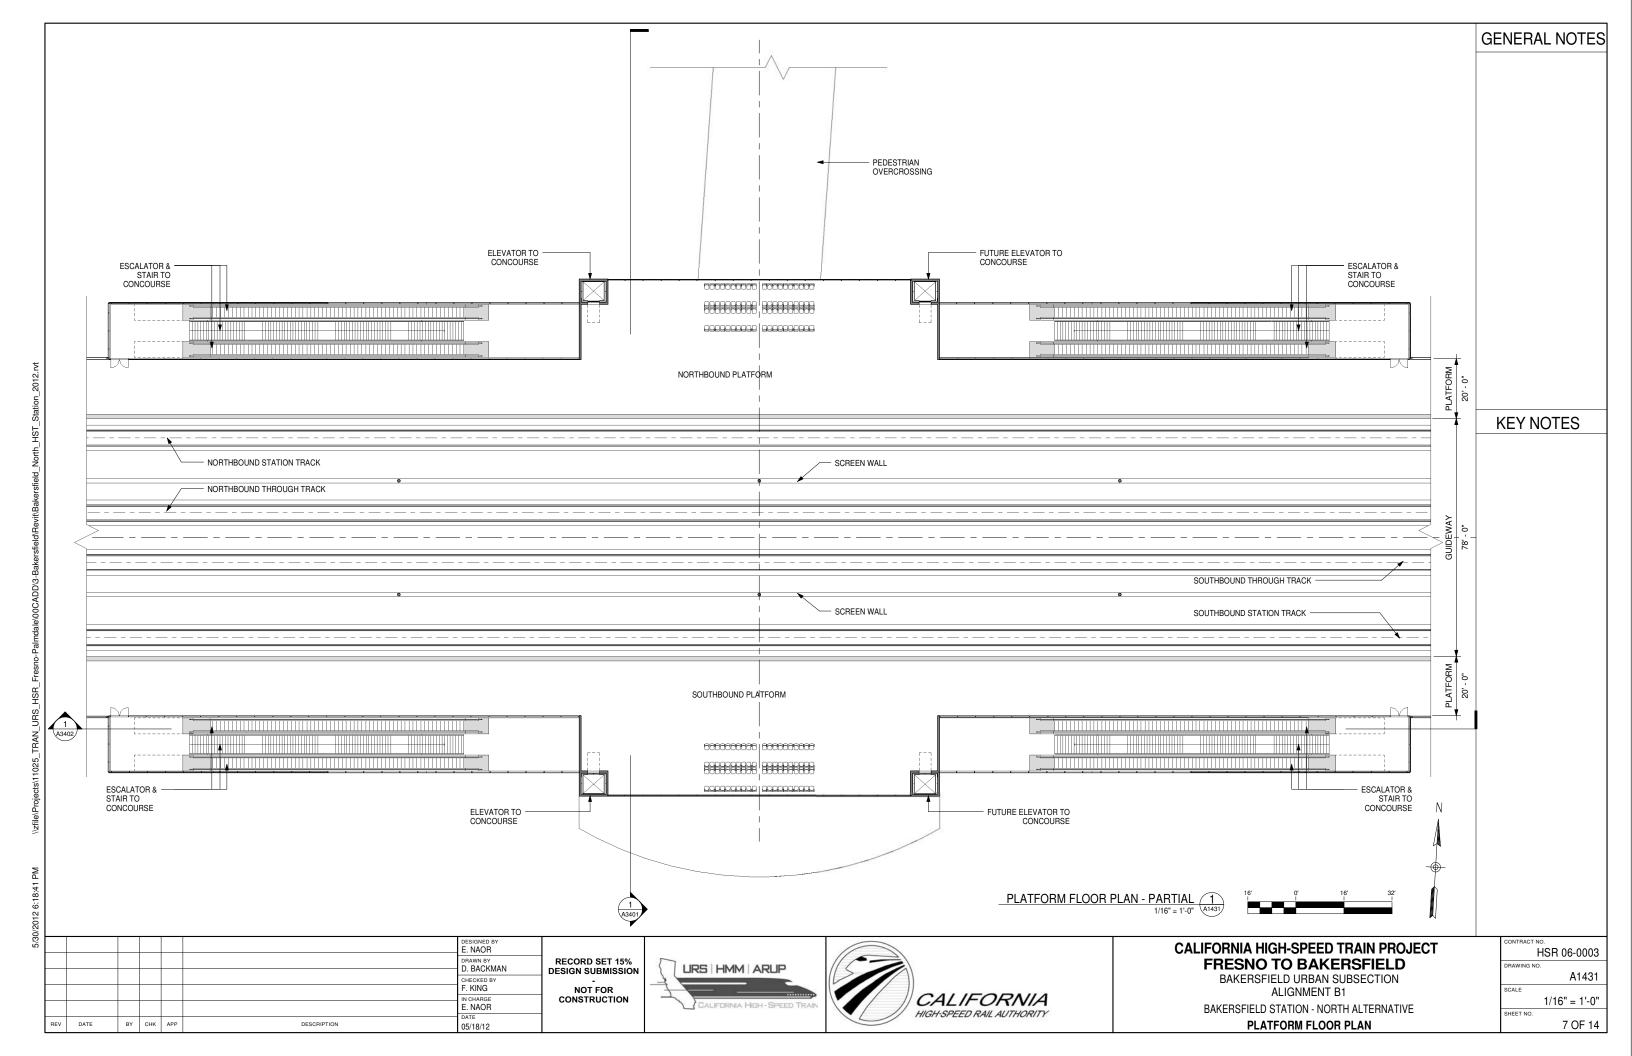

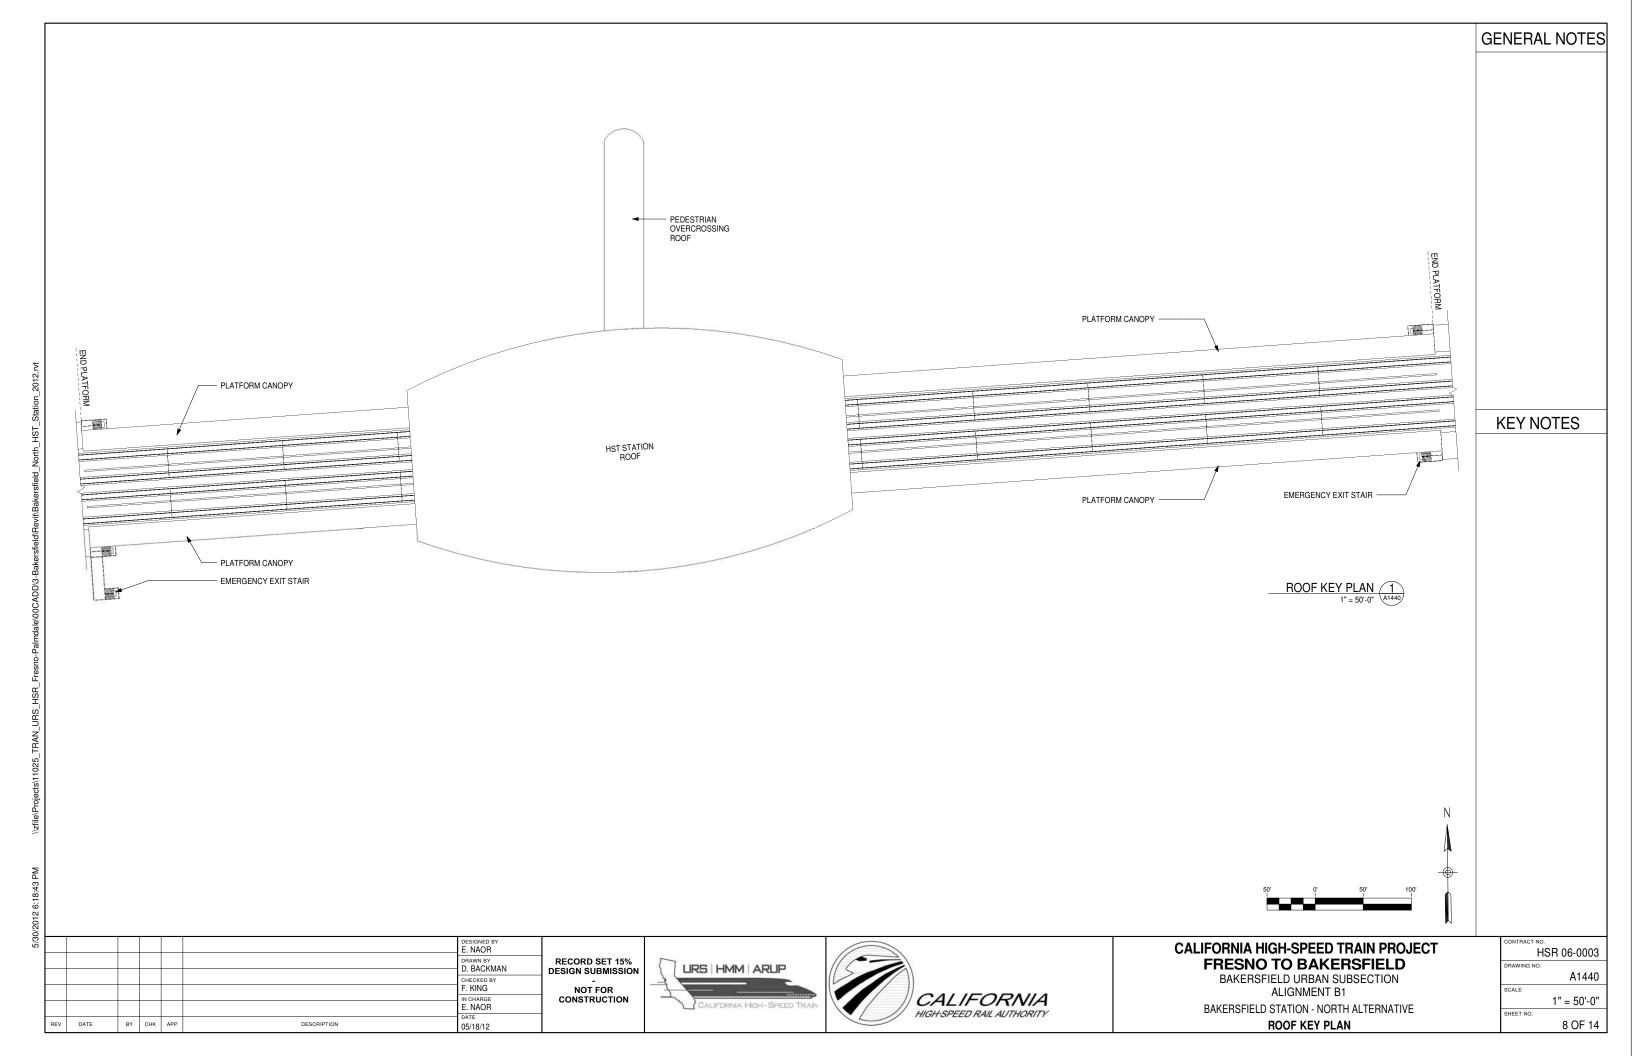

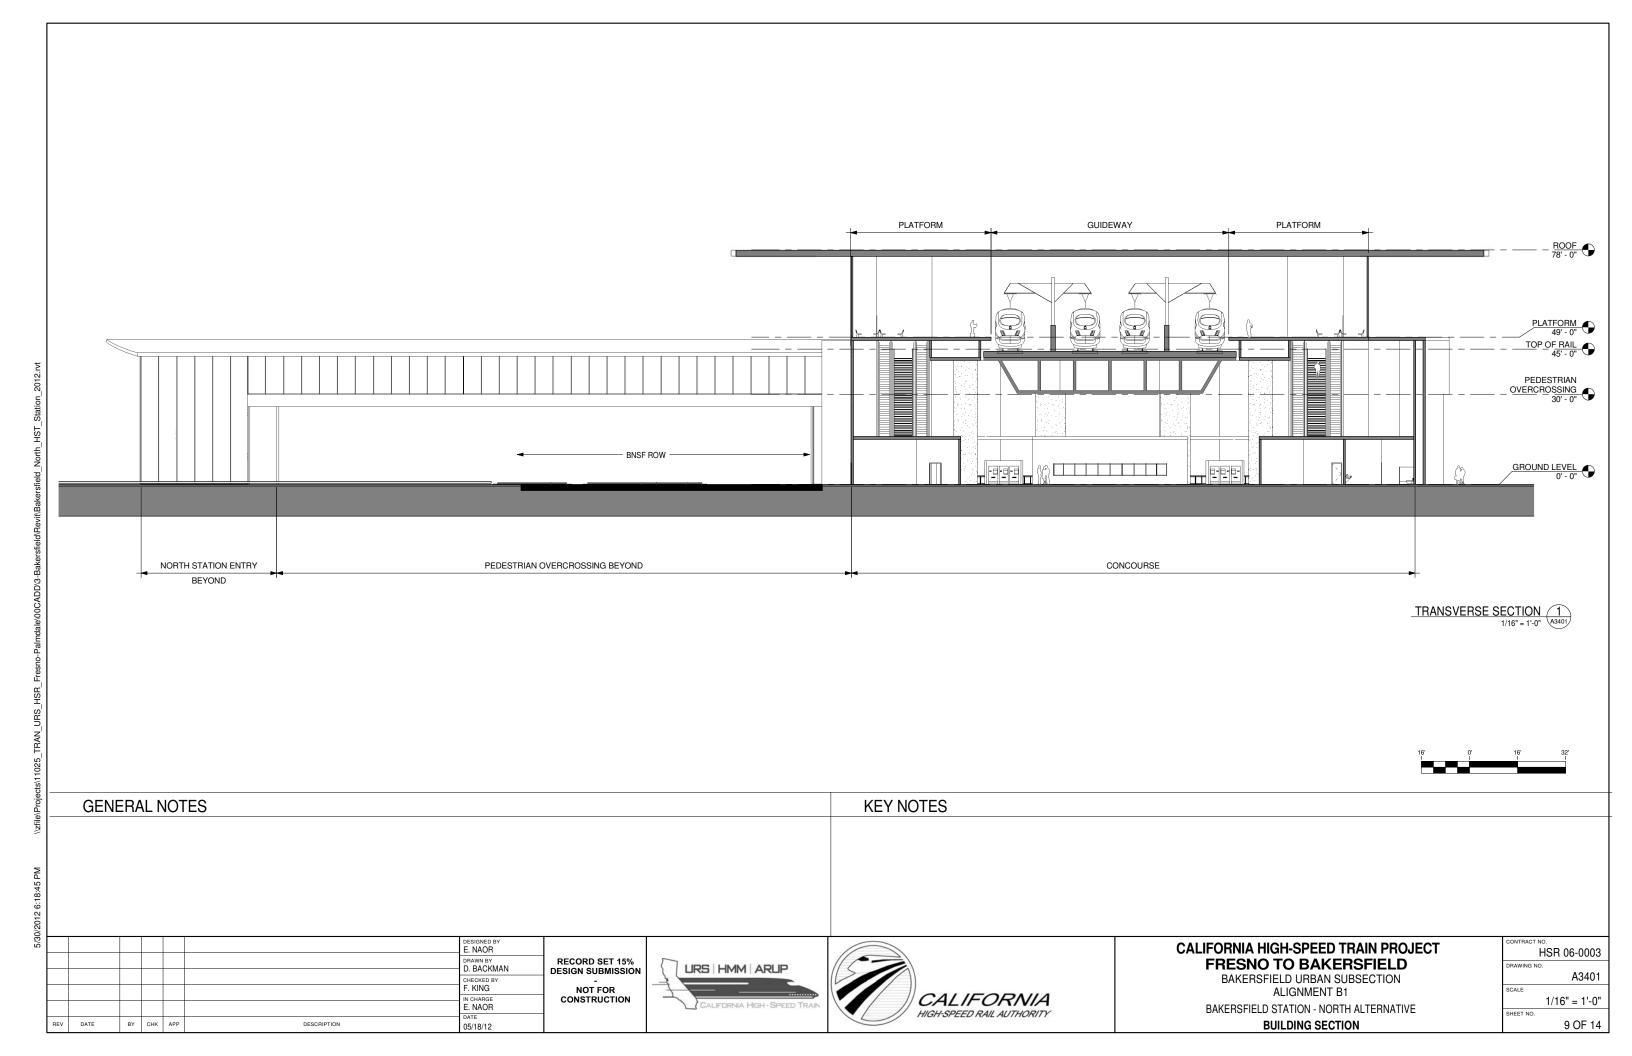

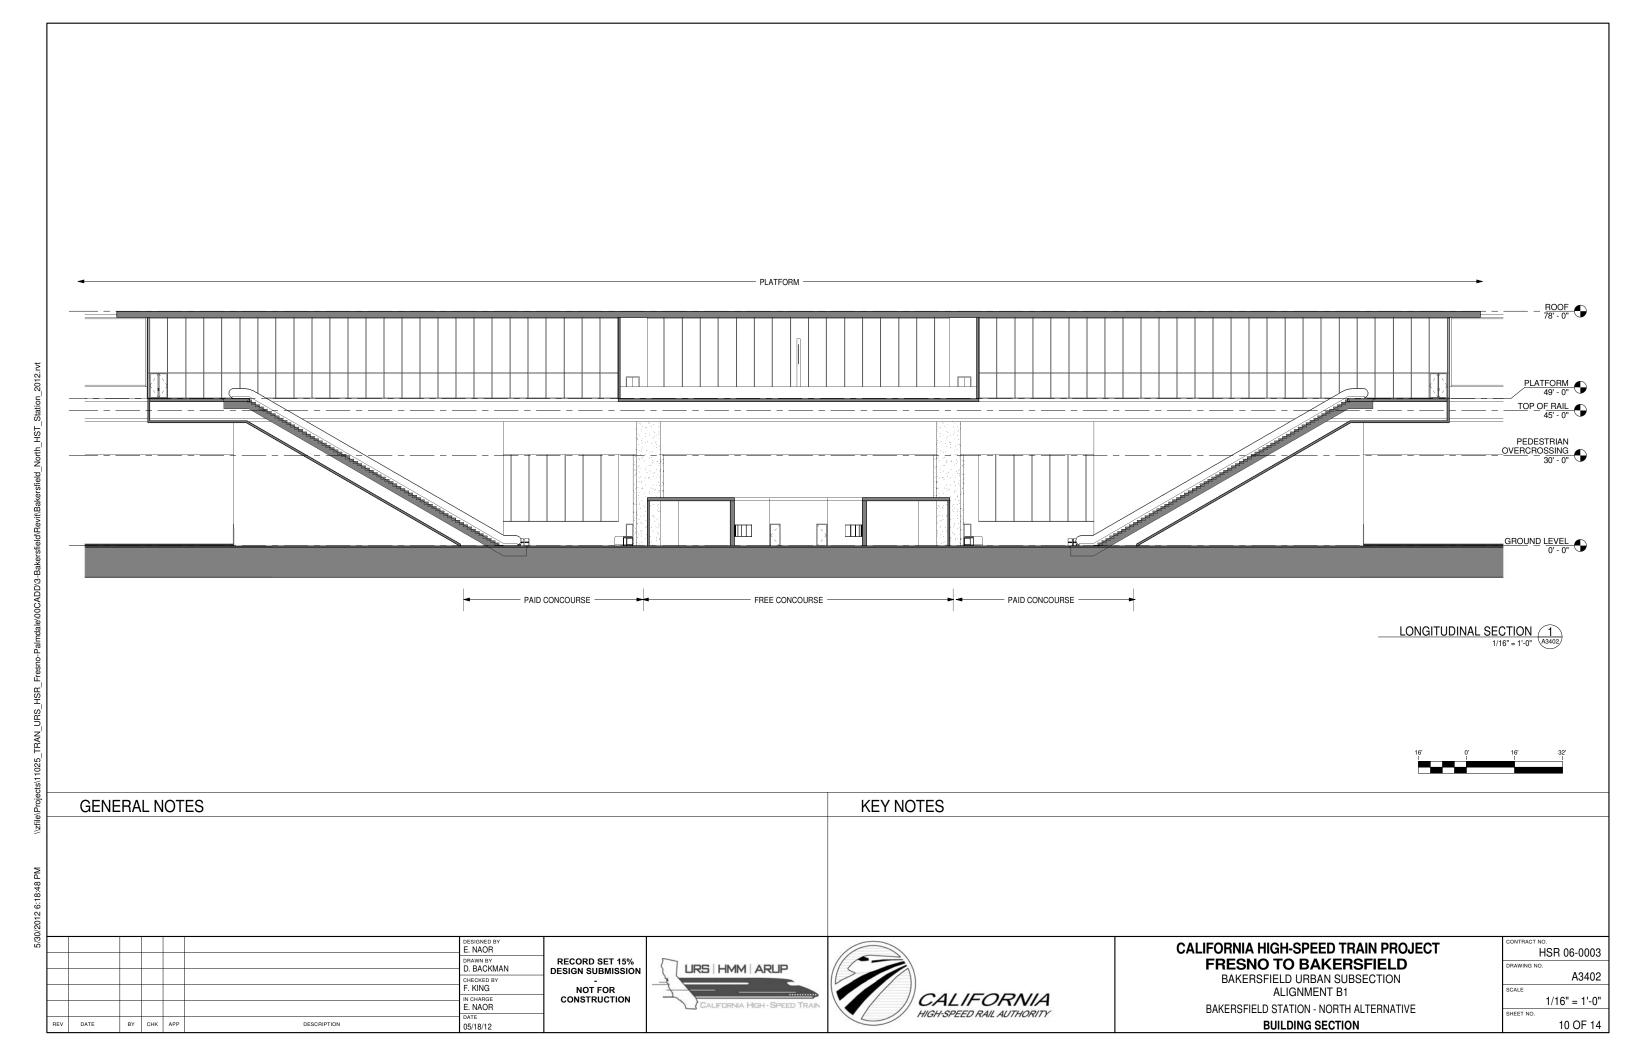

					DESIGNED BY E. NAOR	
					DRAWN BY D. BACKMAN	
						D
					CHECKED BY F. KING	
					IN CHARGE	
					E. NAOR	
					DATE	
REV	DATE	BY	CHK	APP	DESCRIPTION 05/18/12	

RECORD SET 15% DESIGN SUBMISSION NOT FOR CONSTRUCTION





### CALIFORNIA HIGH-SPEED TRAIN PROJECT FRESNO TO BAKERSFIELD BAKERSFIELD URBAN SUBSECTION


ALIGNMENT B1


BAKERSFIELD STATION - NORTH ALTERNATIVE ROOM SCHEDULE


CONTRACT NO.	
HSI	₹ 06-0003
DRAWING NO.	
	A6401
SCALE	
SHEET NO.	


11 OF 14


	AREA	AREA	FORMULA	Comments
CONCOURSE FREE AREA	12797 SF	10969 SF	P15x30sf/person	
CONCOURSE PAID AREA	10728 SF	10969 SF	P15x30sqft	
CONCOURSE PAID AREA	10728 SF		P15x30sqft	
MEN'S RESTROOM	570 SF	366 SF	P15	
WOMEN'S RESTROOM	570 SF		P15	
FUTURE CONCESSION	837 SF	300 31	Not specified in Technical Memorandum 2.2.2	
FUTURE CONCESSION	837 SF	_	Not specified in Technical Memorandum 2.2.2	
TICKET ADMIN OFFICE	367 SF	160 SF	160 SF	
TICKET ADMIN OFFICE	367 SF	141 SF	(((P60bx.15)/(1.5 x 60)) x 75) sqft	
	367 SF			
STATION AGENT OFFICE			270 SF 160 SF	
PASSENGER SERVICES OFFICE	367 SF	160 SF		
OPERATIONS MAINTENANCE OFFICE	1080 SF	1080 SF	1080 SF	
STATION COMPUTER ROOM	598 SF	520 SF	520 SF	
TELECOM	598 SF			
STATION CONTROL & COMMUNICATION ROOM	1080 SF	1080 SF	1080 SF	
SIGNALLING	481 SF			
ELECTRICAL	481 SF			
MECHANICAL	481 SF			
PLUMBING	481 SF			
FIRE PROTECTION	481 SF			
BATTERY	481 SF			
FACILITY MAINTENANCE OFFICE	720 SF	325 SF	325 SF	
JANITOR & STORAGE	674 SF	240 SF	240 SF x 3	
SECURITY OFFICE	265 SF	160 SF	160 SF	
POLICE OFFICE	312 SF	160 SF	160 SF	
TRANSIT AGENCY OFFICES	627 SF		based on demand	
STATION ADMIN OFFICE	720 SF		((65sqft x staff with own workspace) + (43sqft x staff with shared workspace))x1.25	
STAFF BREAK ROOM	431 SF	125 SF	(20sqft x .25 x max staff per shift x 1.25)	
TRAINING AND MEETING ROOM	510 SF	500 SF	(20sqft x max staff per shift x 1.25)	
STAFF LOCKER ROOMS AND RESTROOMS	500 SF		local codes	
STAFF LOCKER ROOMS AND RESTROOMS	500 SF		local codes	
TRASH	467 SF			
LANDSCAPE	475 SF			
FUTURE CONCESSION	613 SF		Not specified in Technical Memorandum 2.2.2	
FUTURE CONCESSION	613 SF		Not specified in Technical Memorandum 2.2.2	
PEDESTRIAN OVERCROSSING	6443 SF		Tot opening in Touring in Indiana.	
 Room	987 SF			

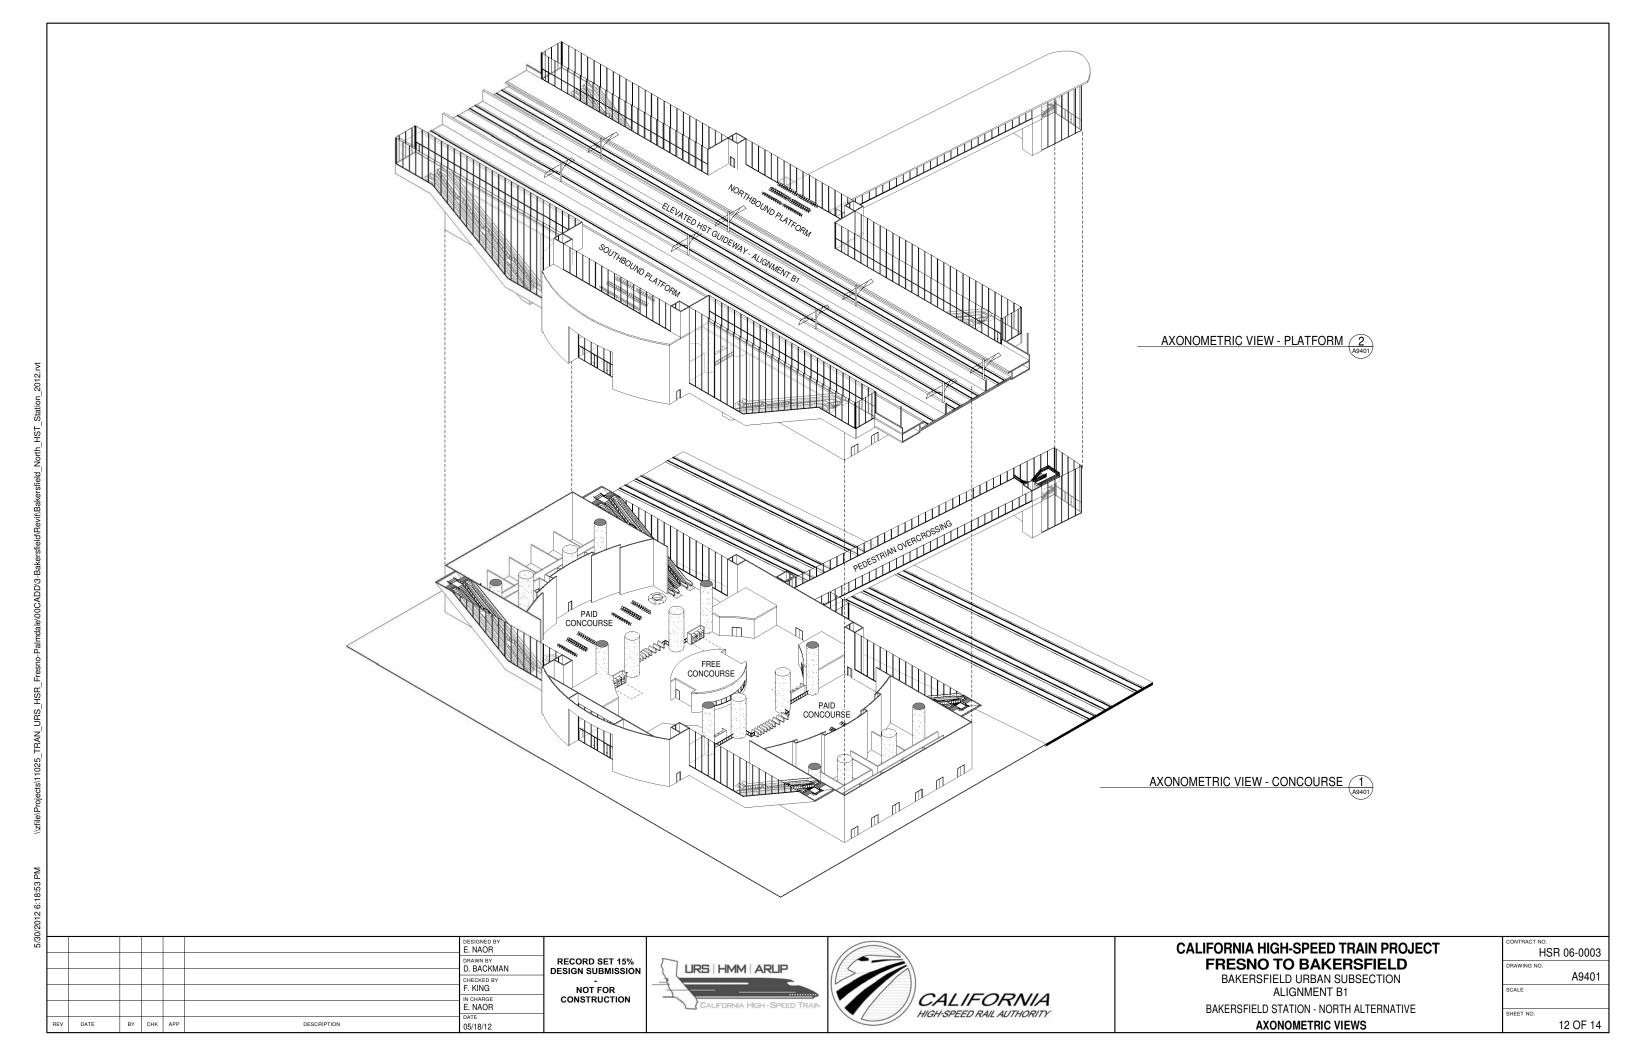


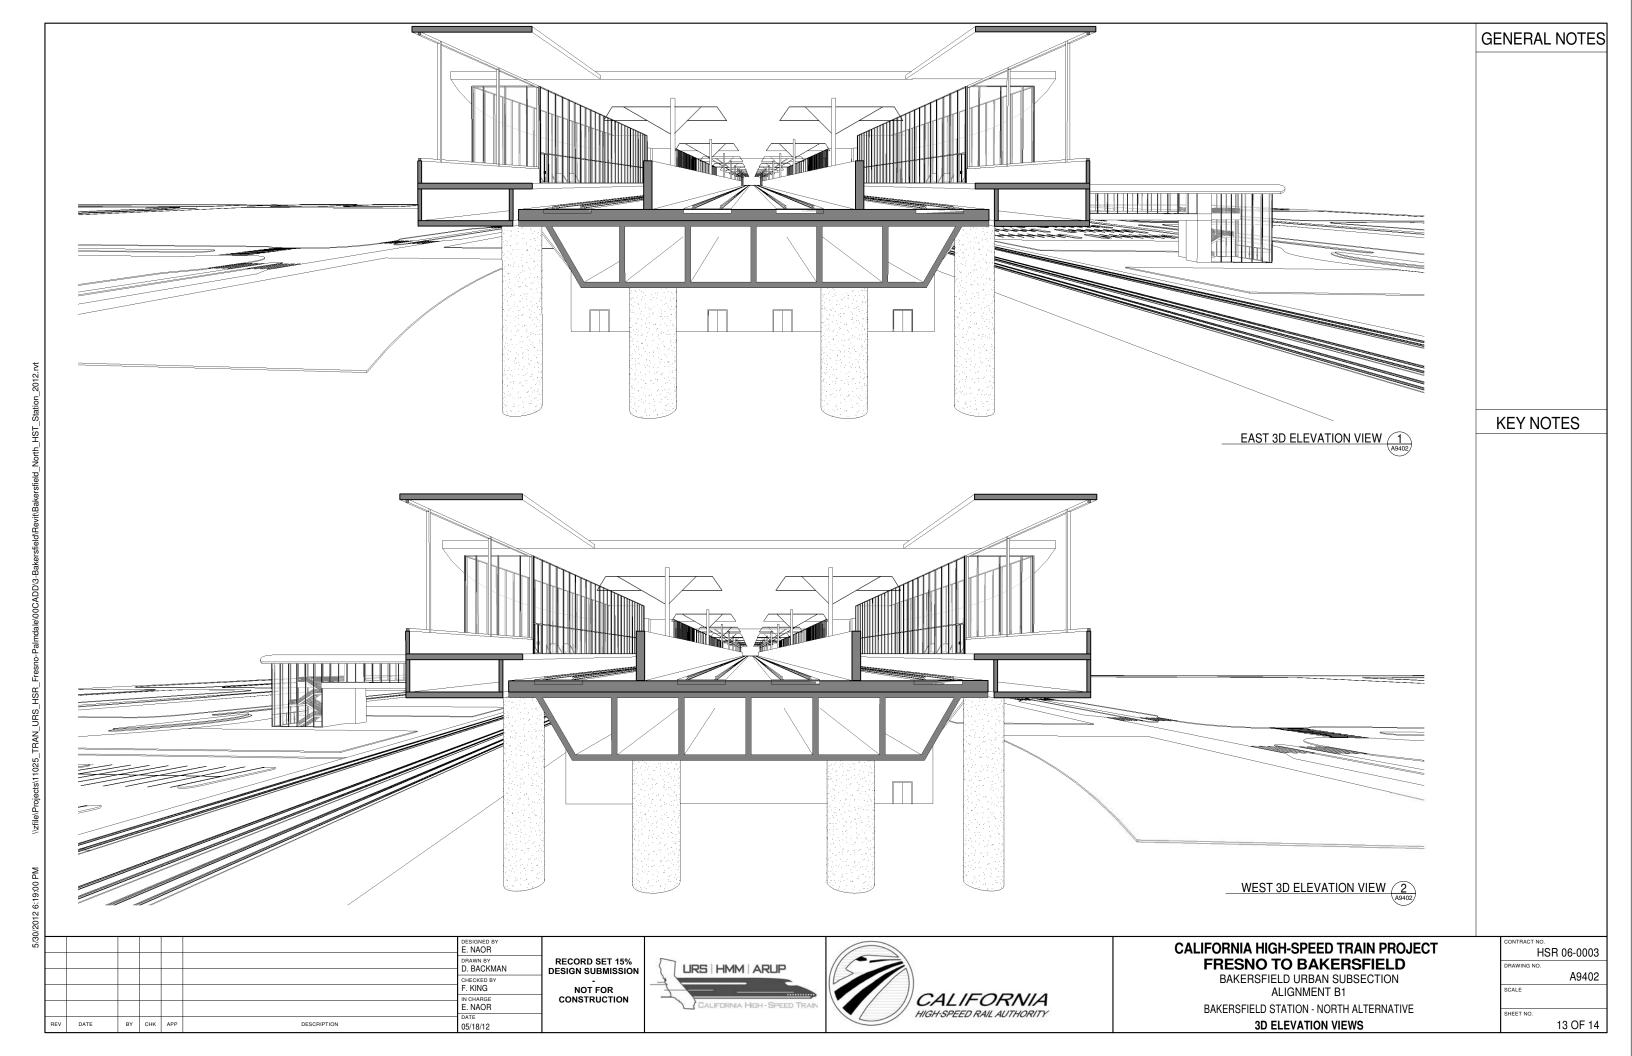


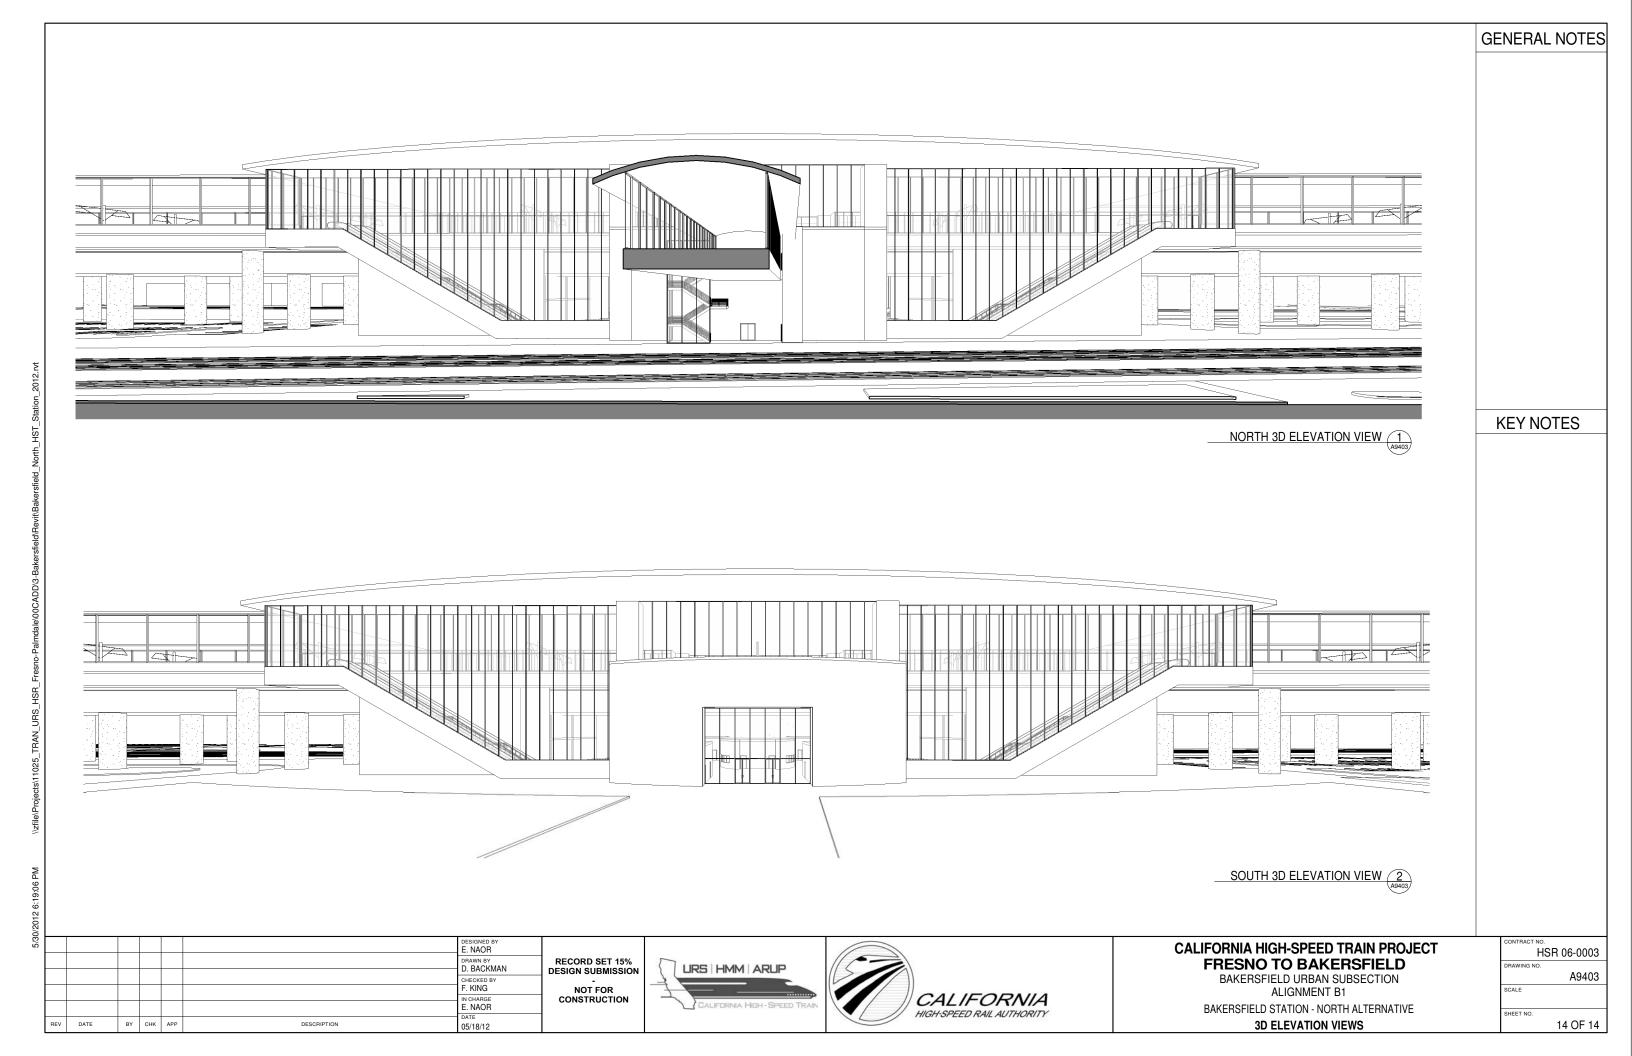


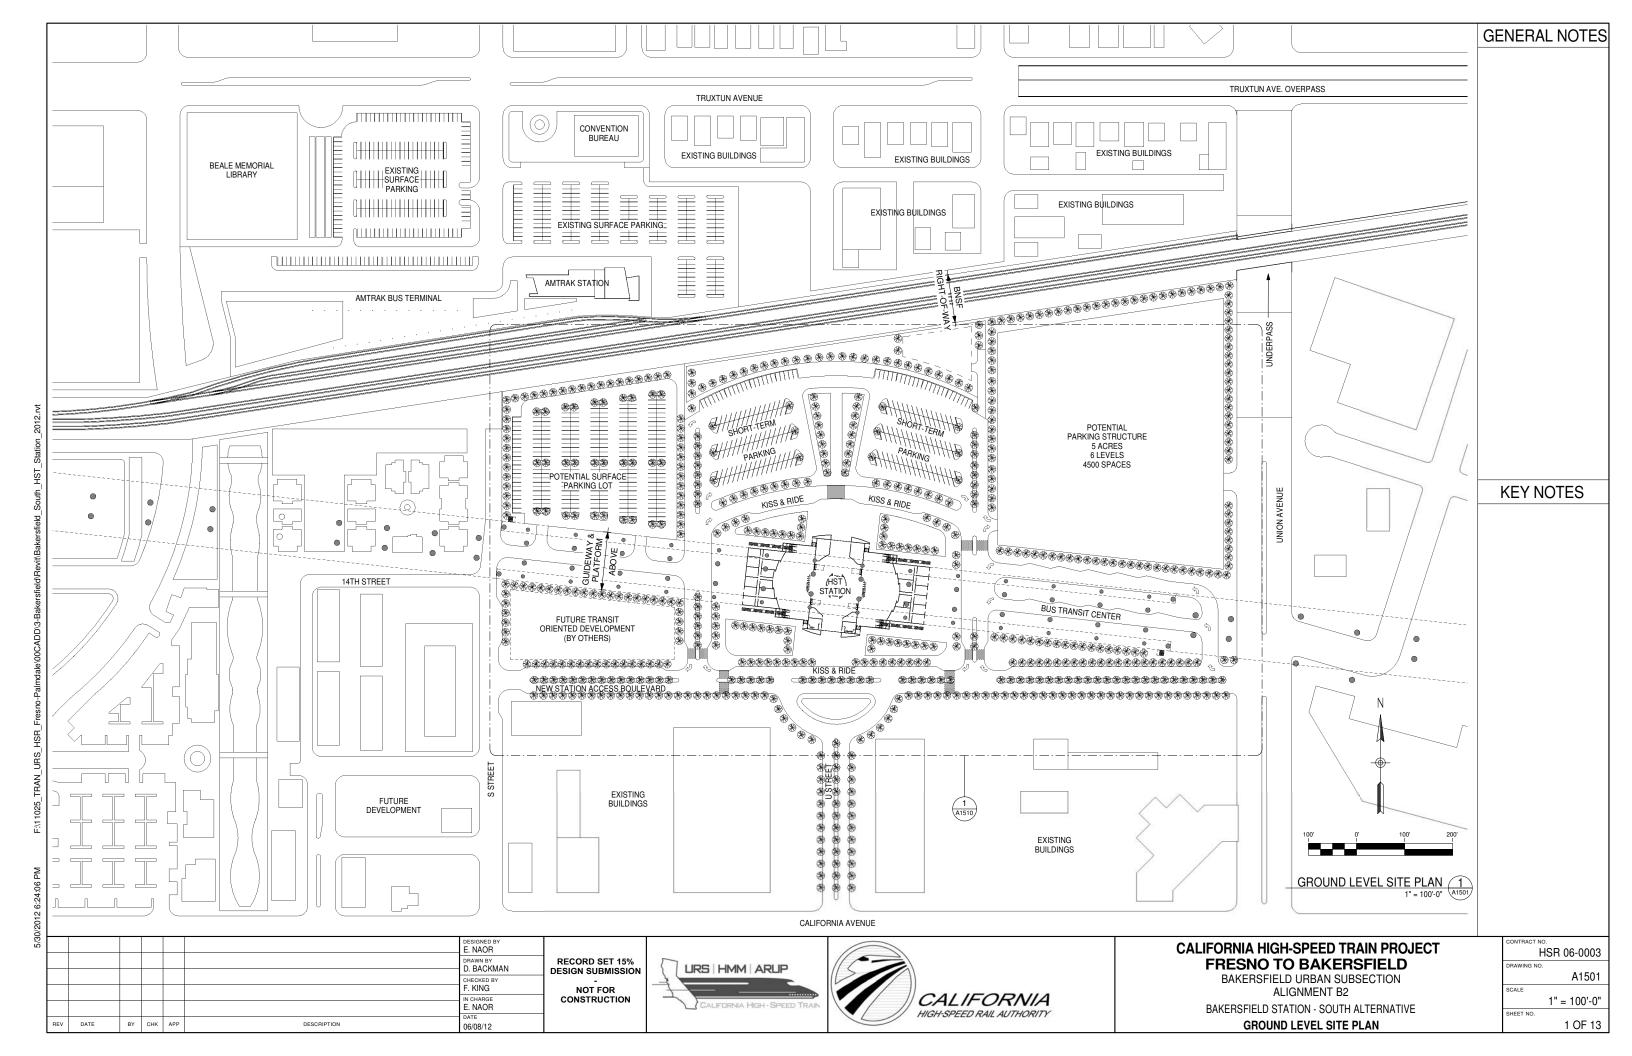


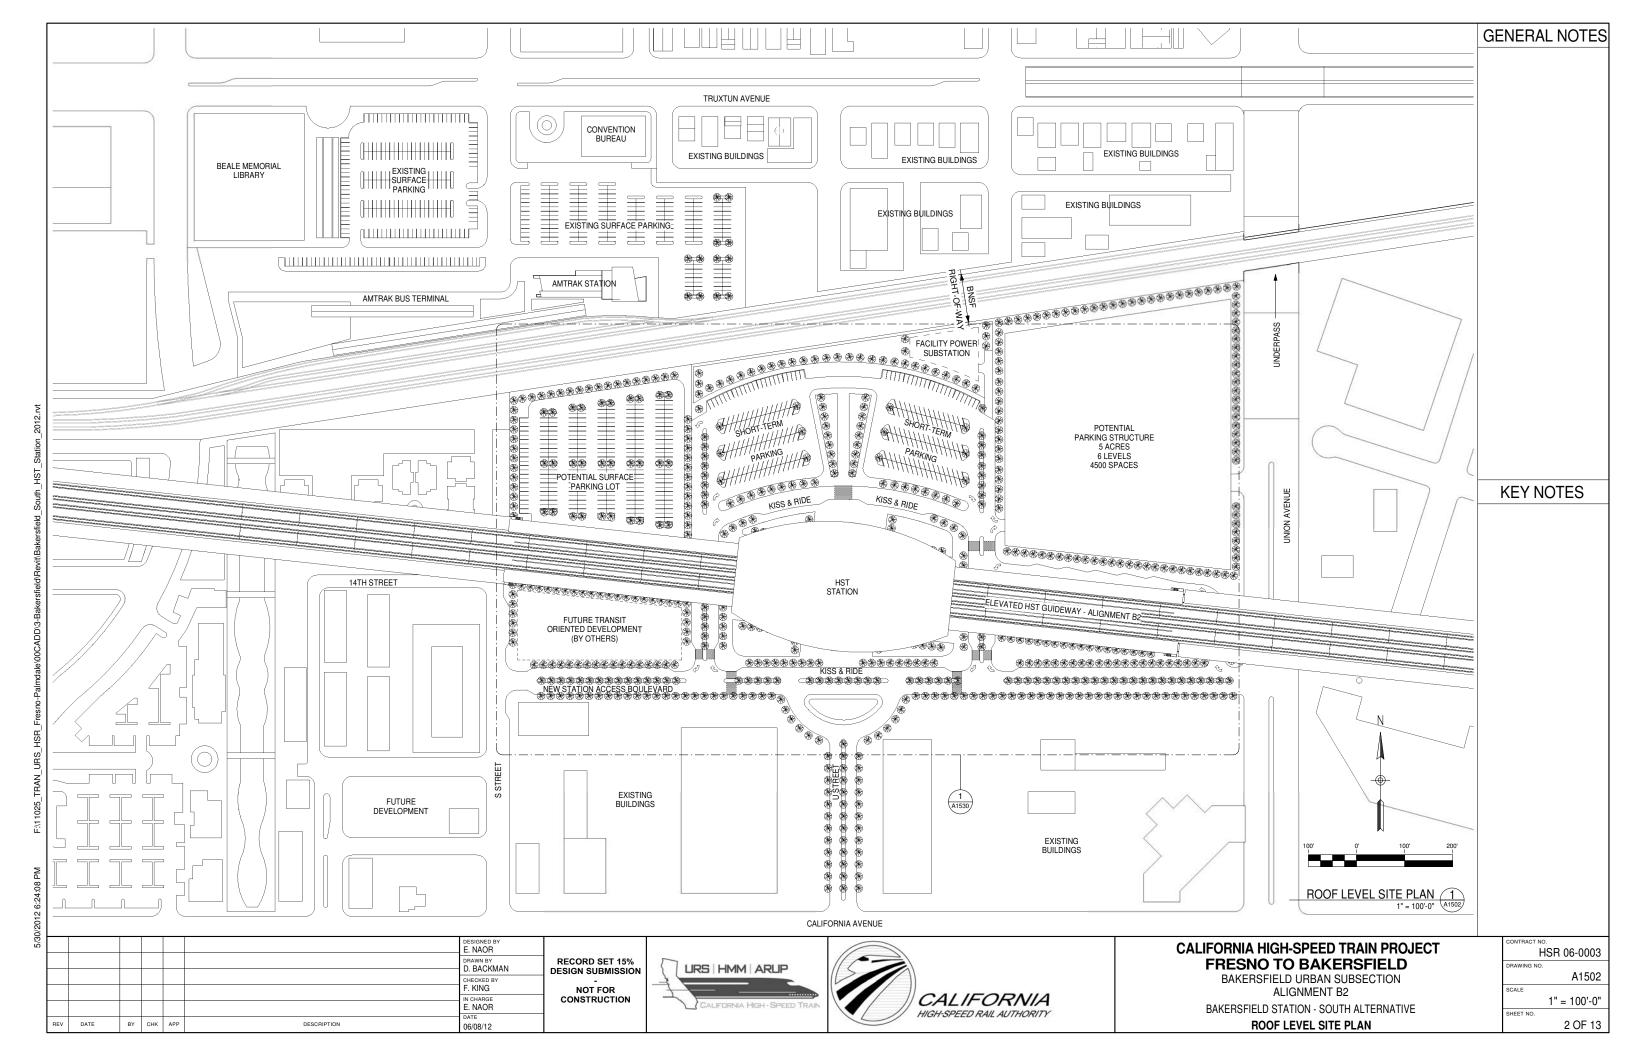


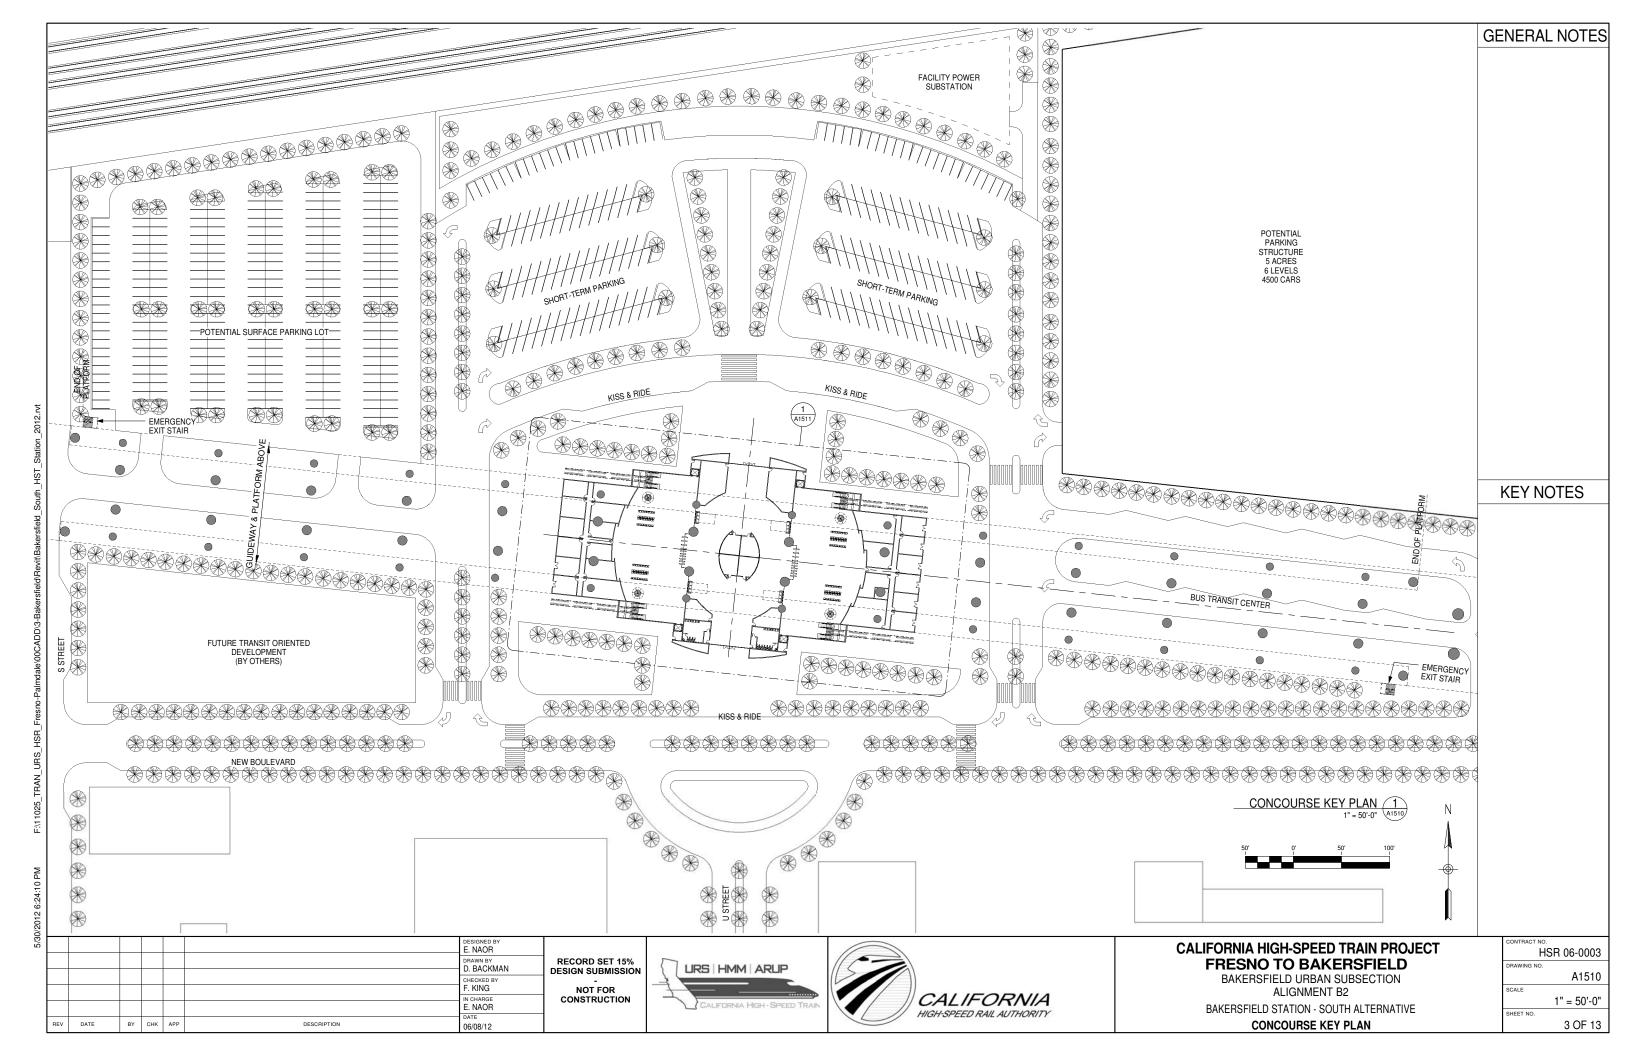


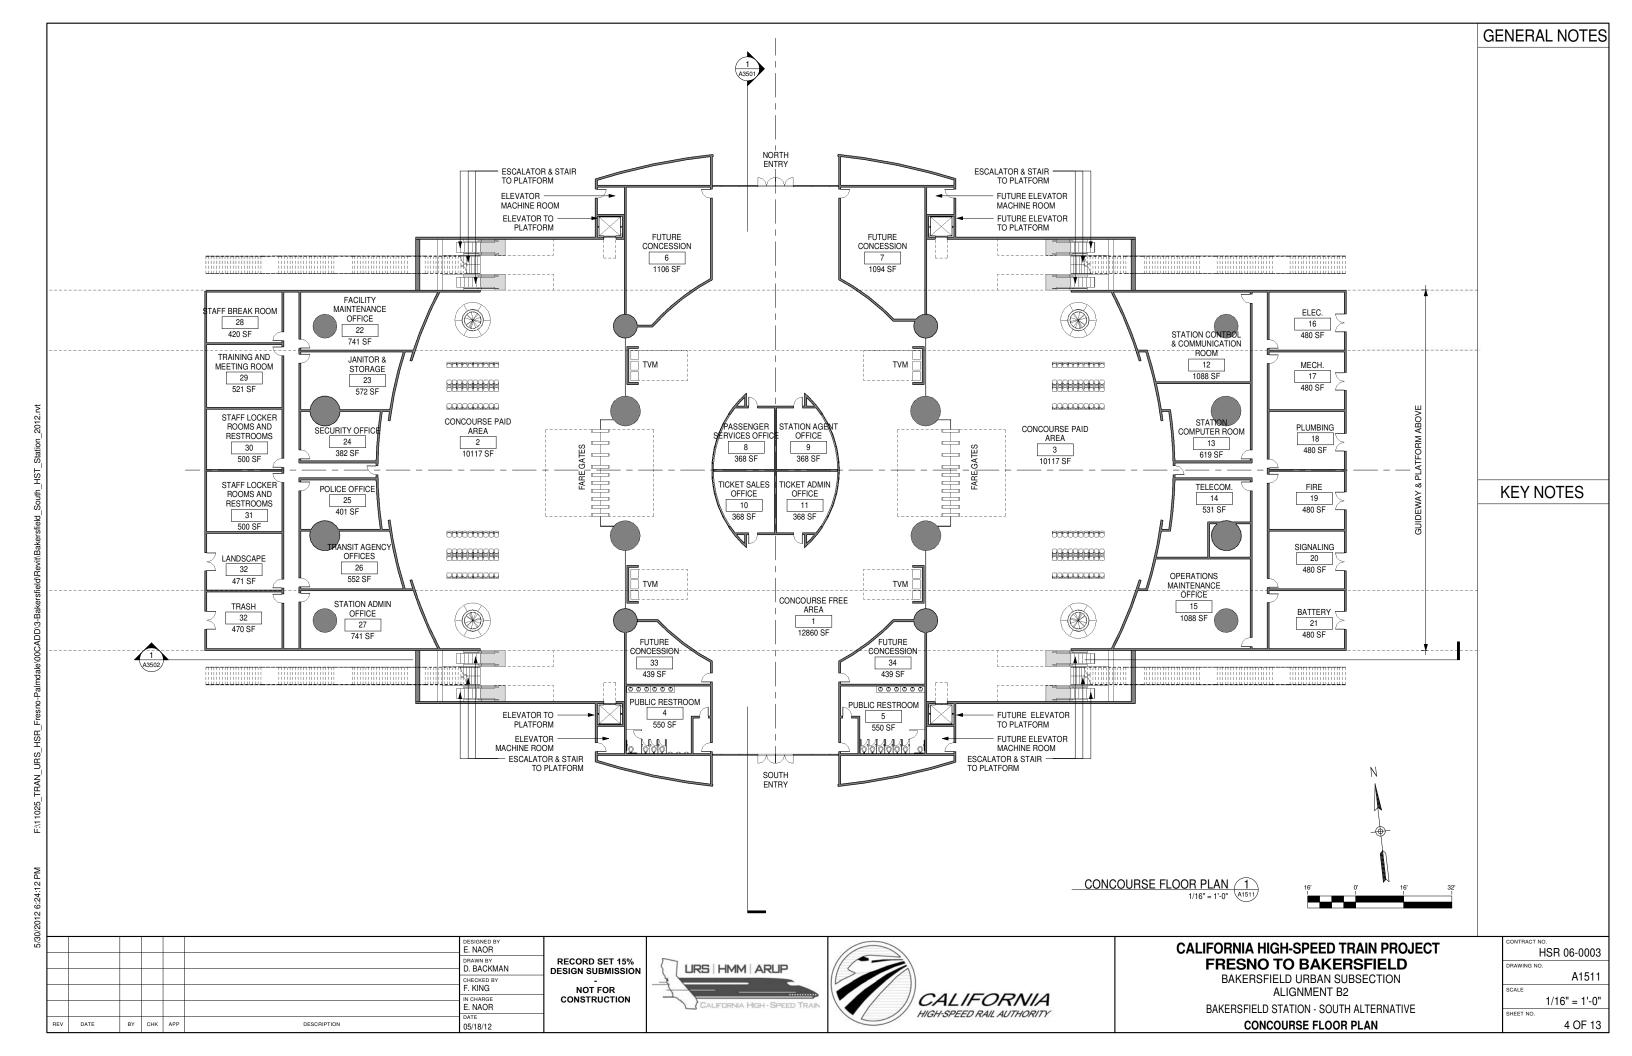

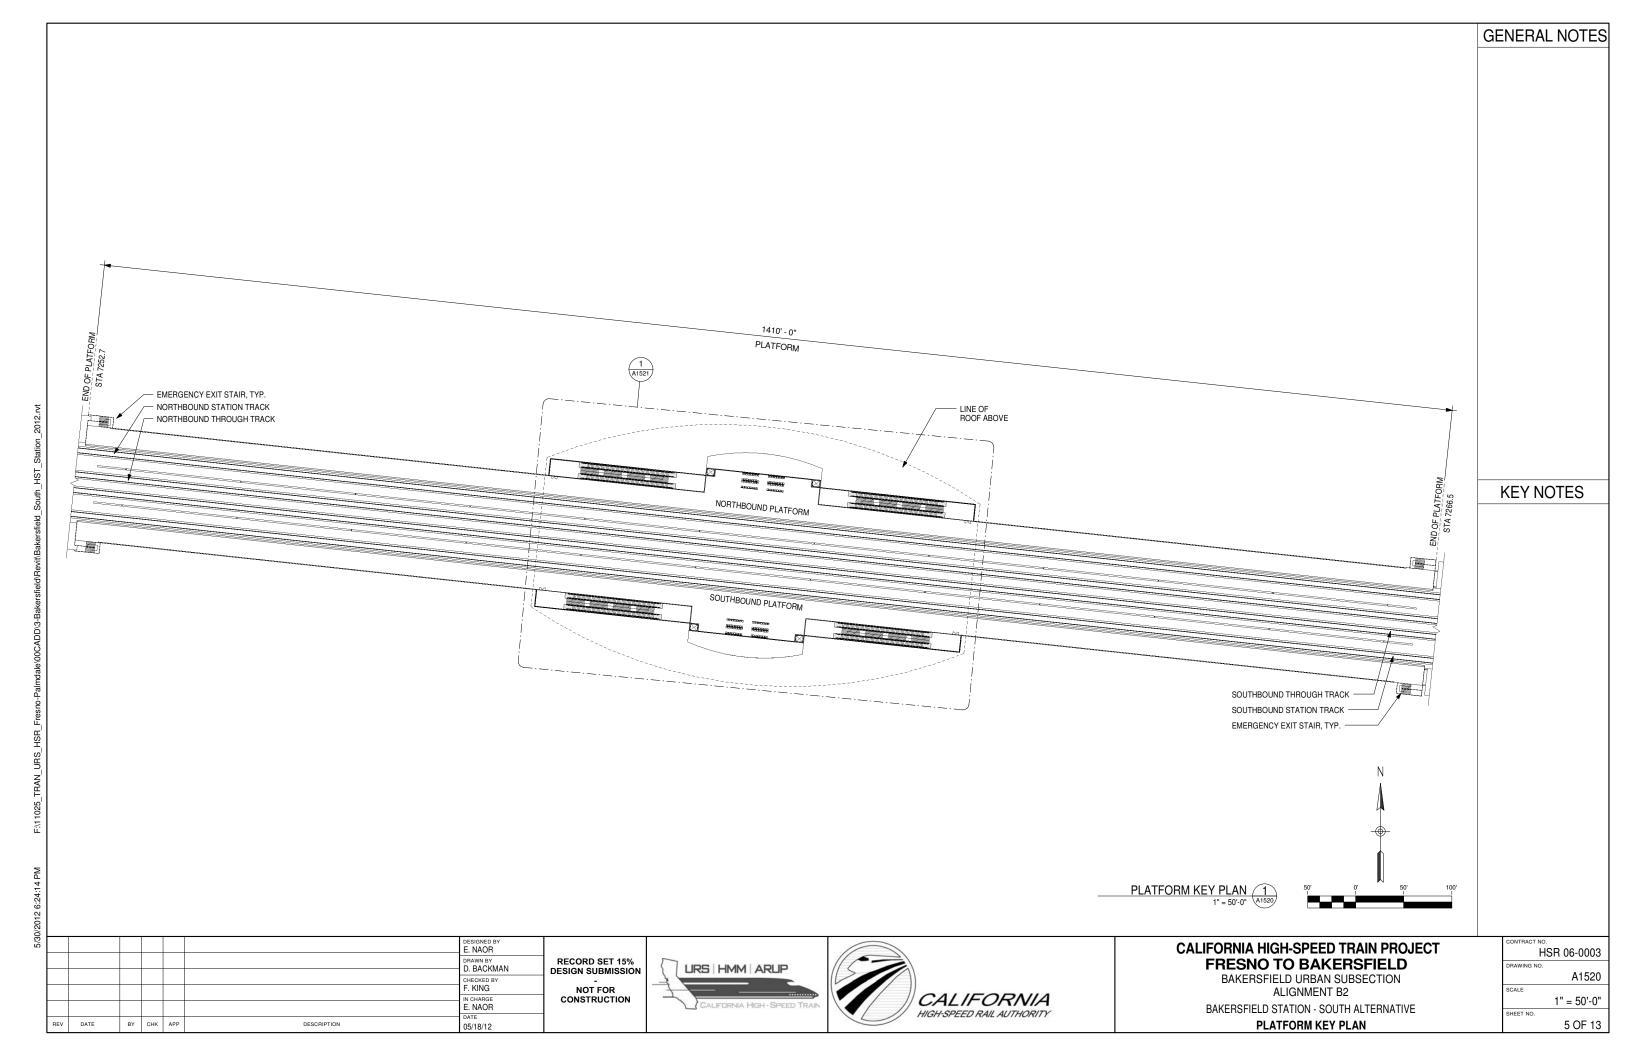

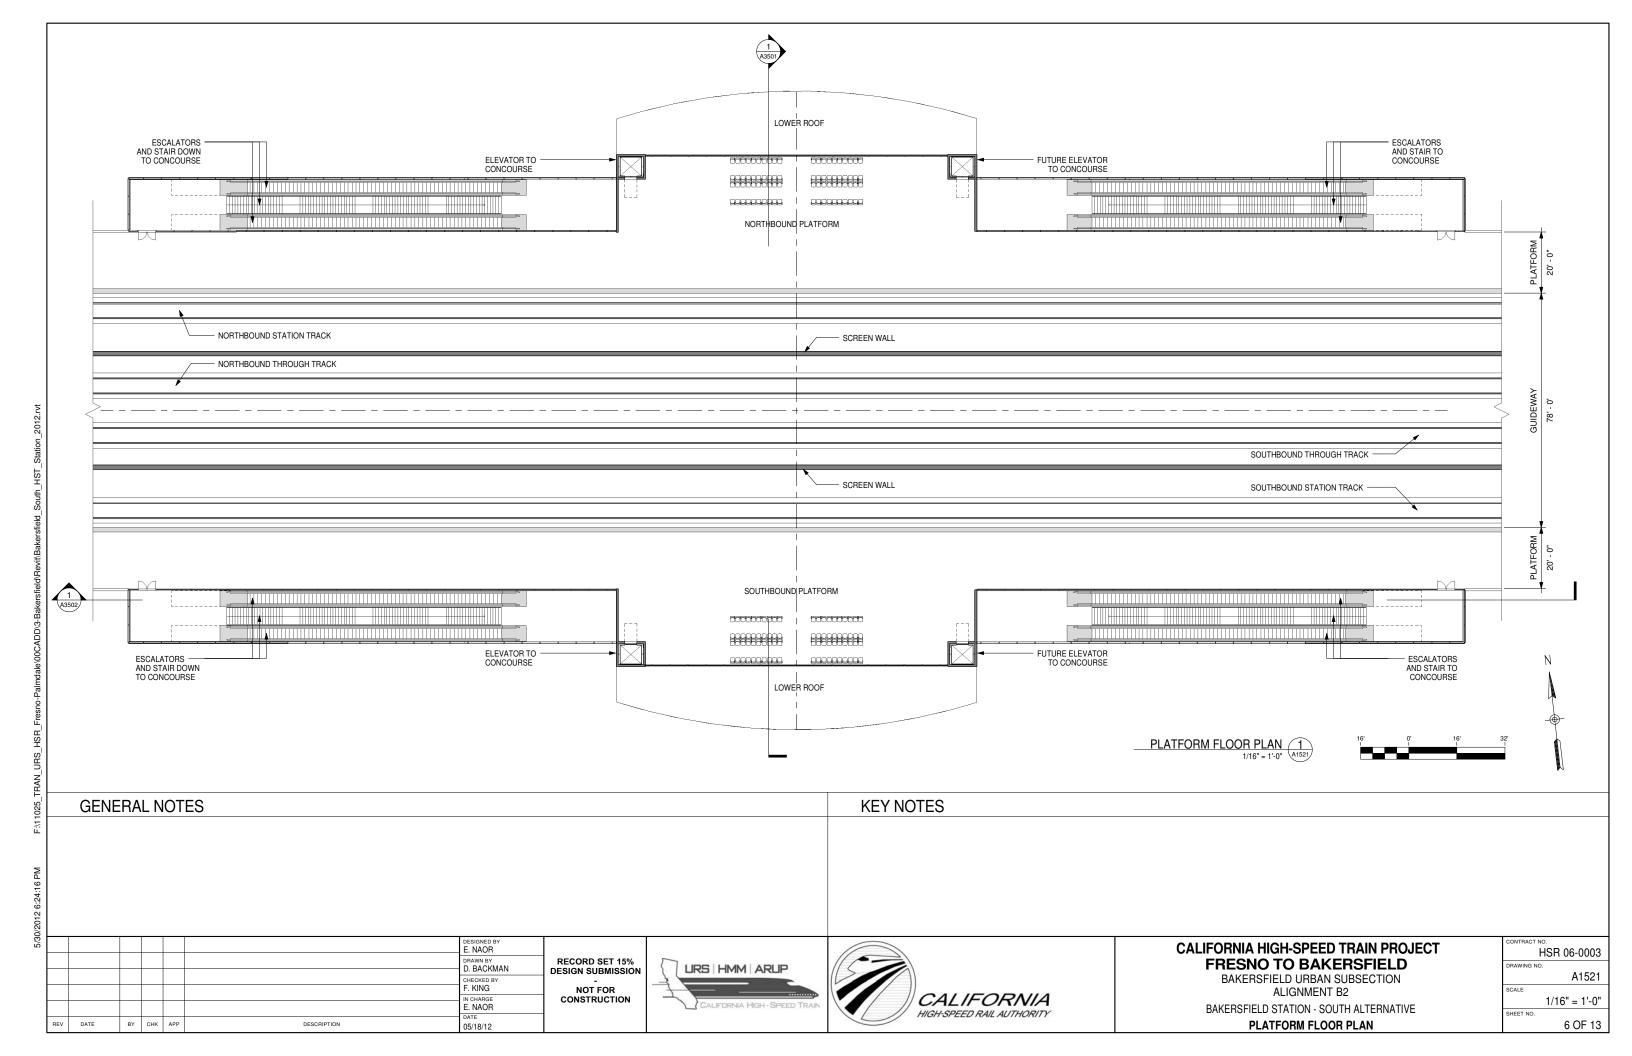

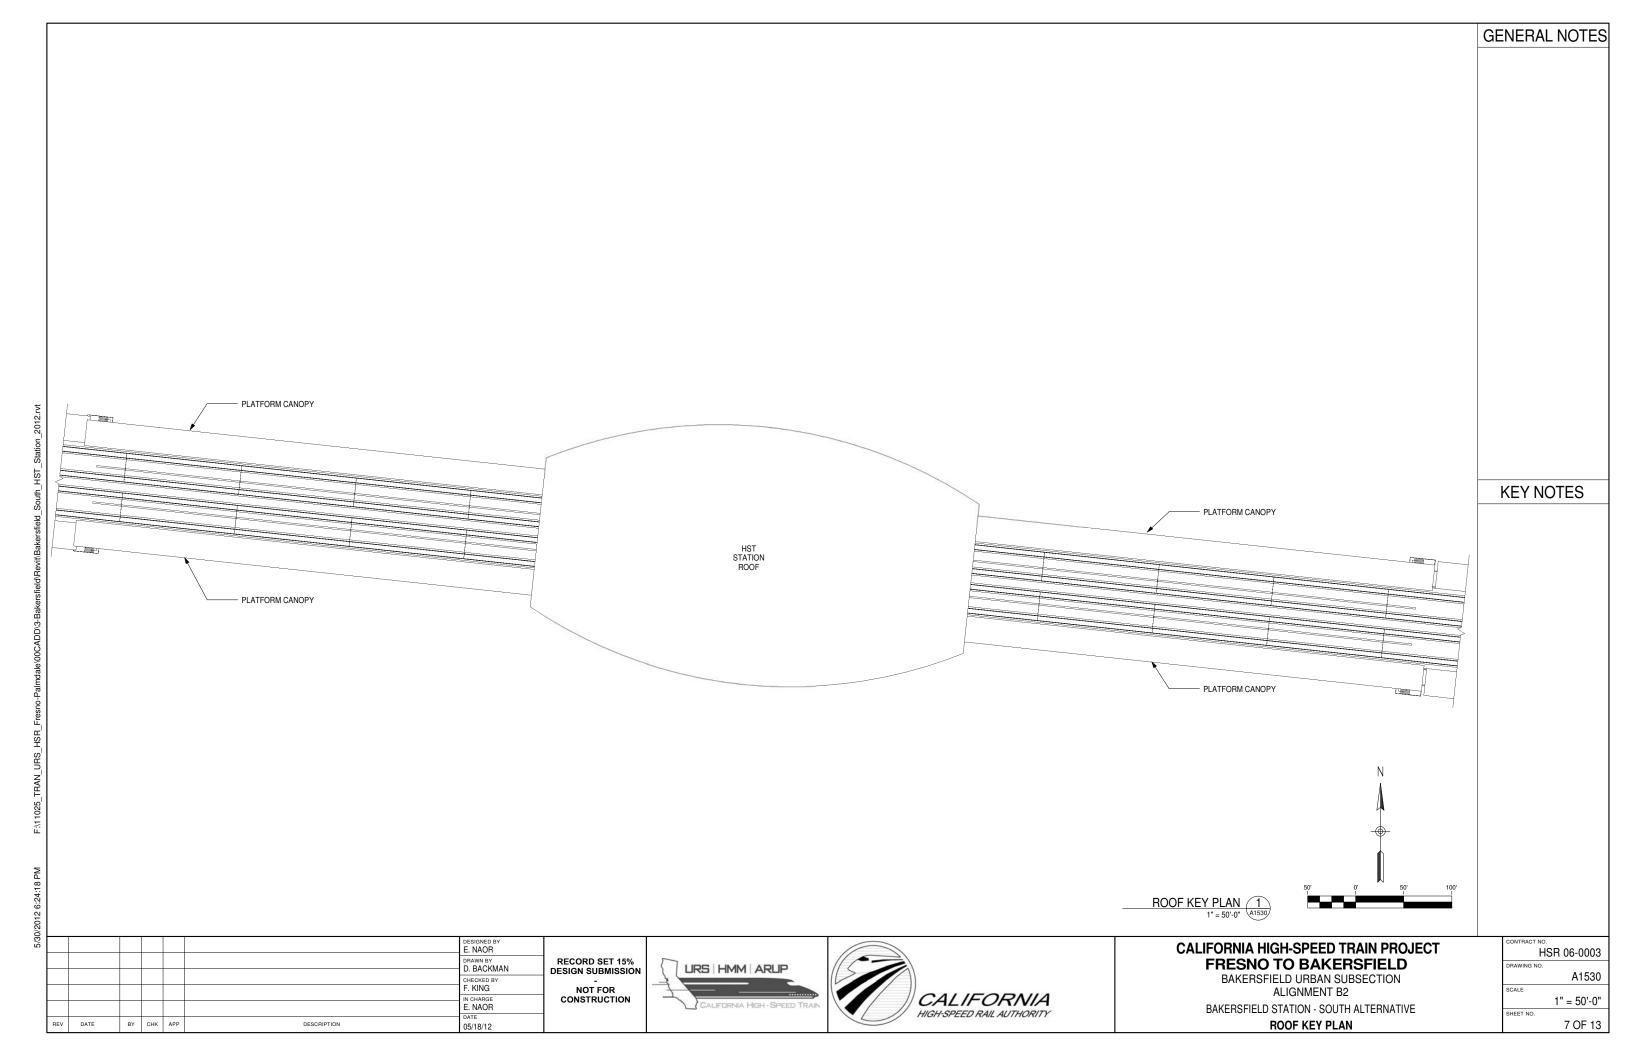

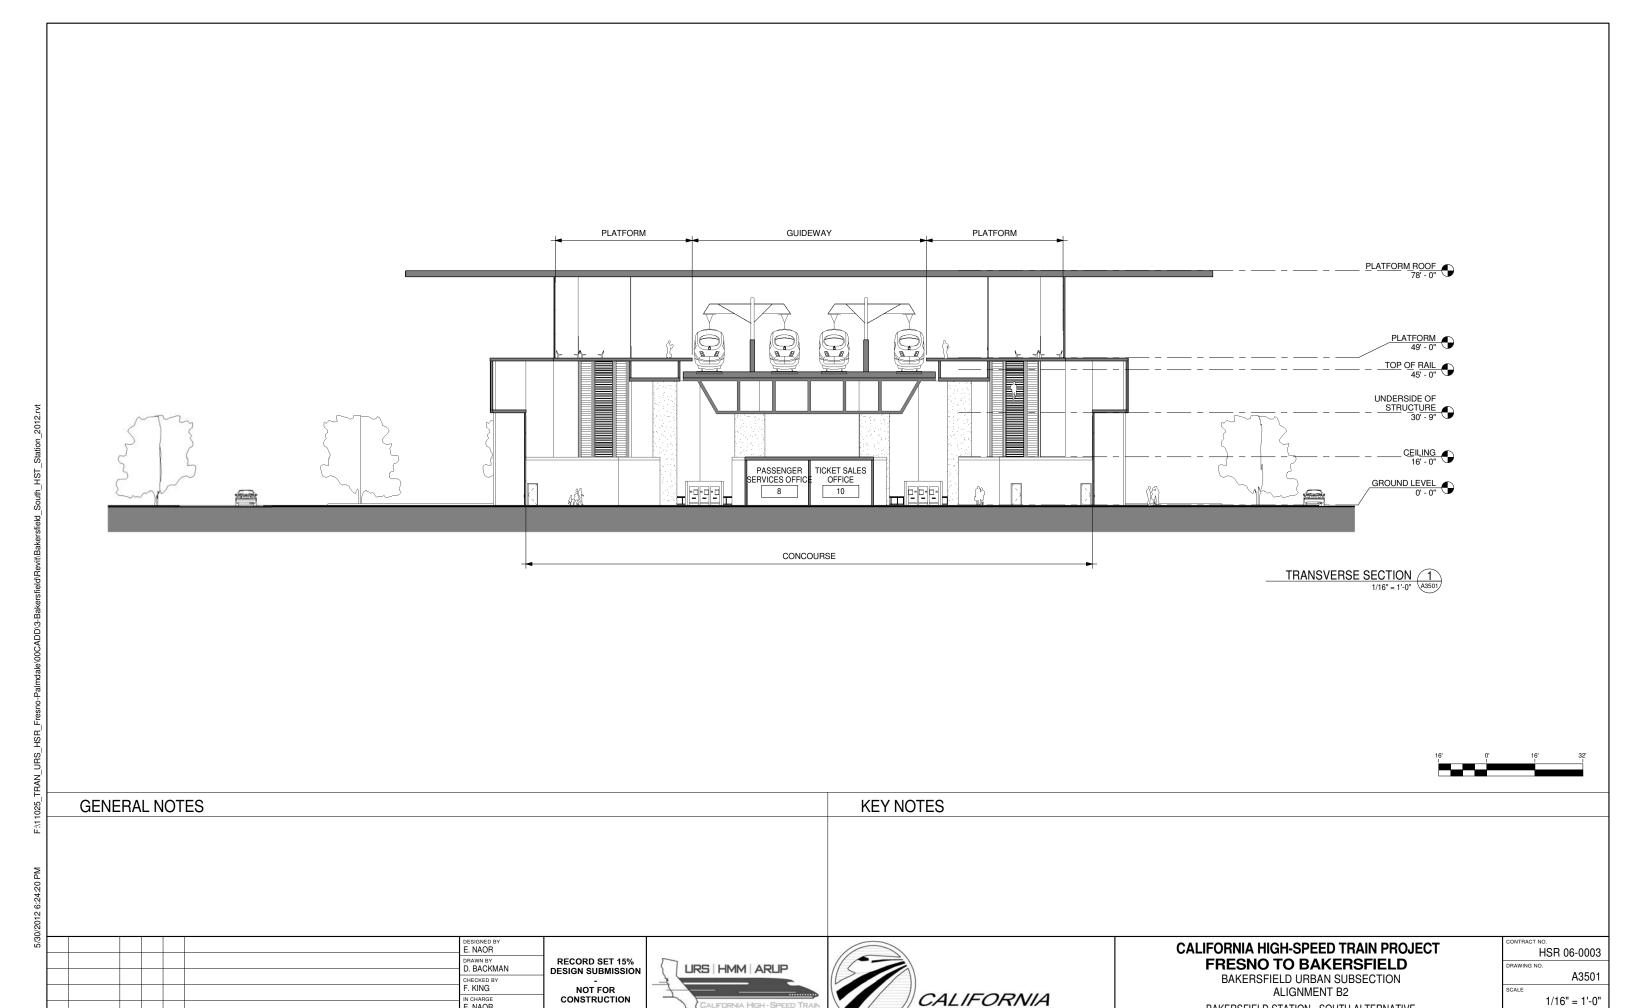

1/16" = 1'-0"

8 OF 13

BAKERSFIELD STATION - SOUTH ALTERNATIVE


**BUILDING SECTION** 

IN CHARGE E. NAOR

05/18/12

DESCRIPTION

BY CHK APP

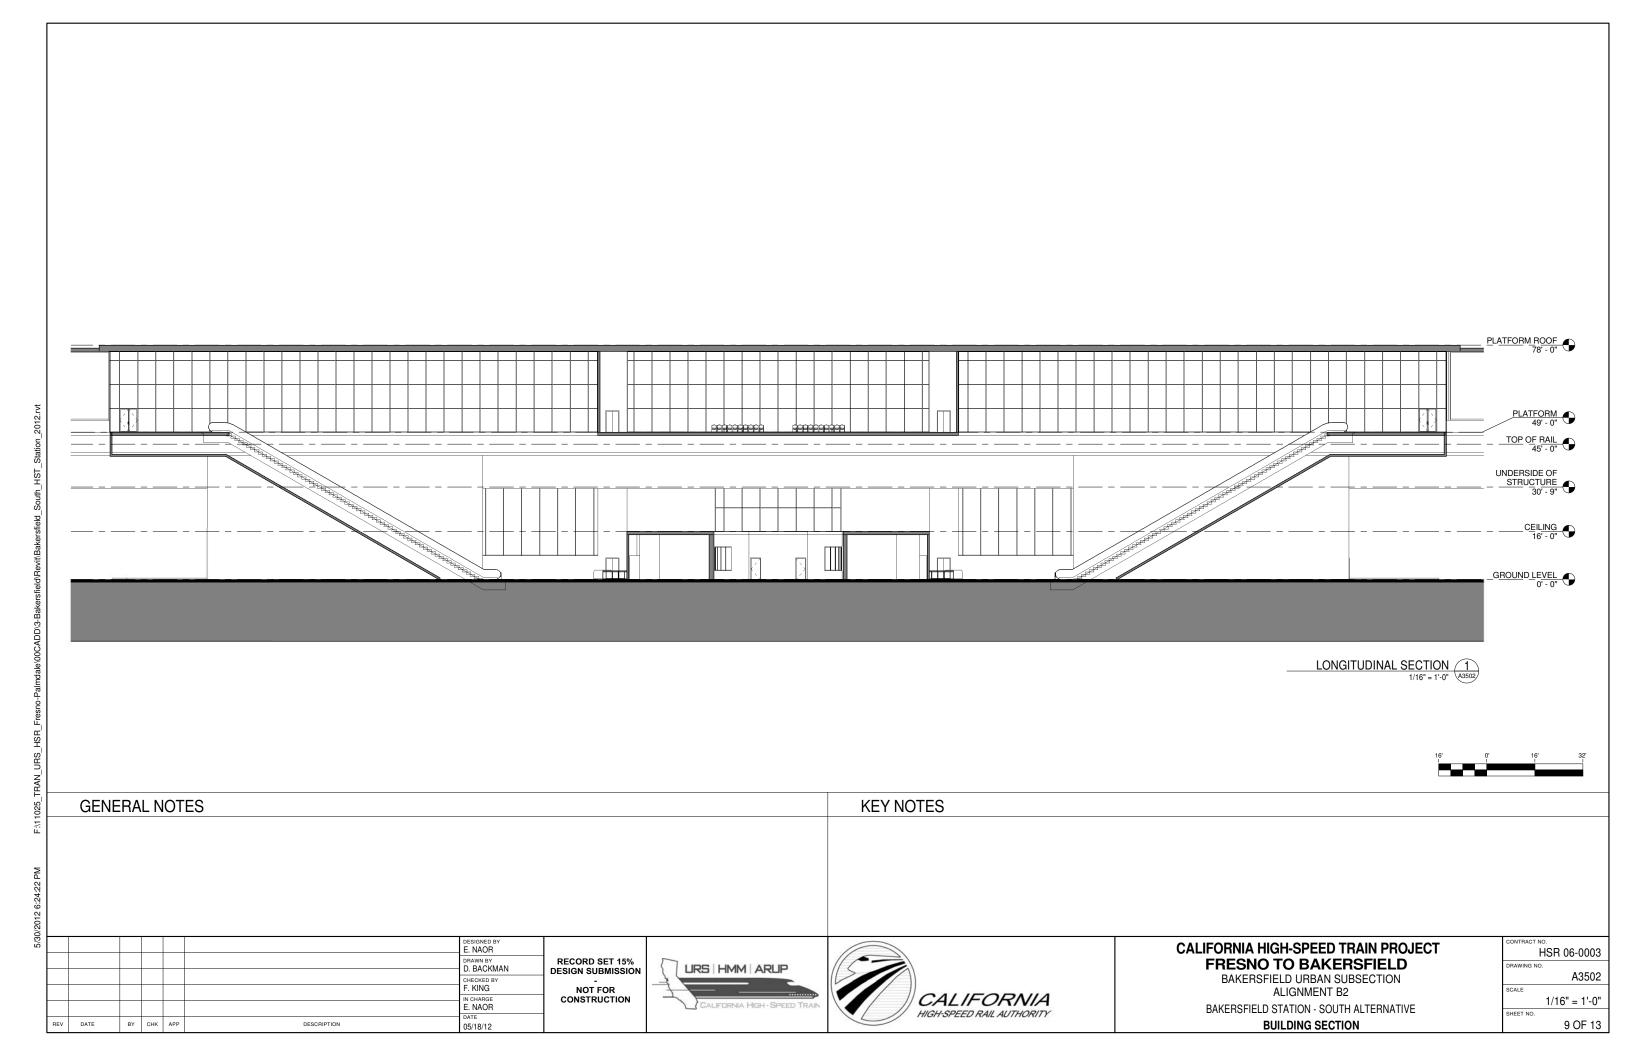

2/3						
	REV	DATE	BY	снк	APP	

RECORD SET 15% DESIGN SUBMISSION NOT FOR CONSTRUCTION

DESIGNED BY E. NAOR

D. BACKMAN

CHECKED BY F. KING

IN CHARGE E. NAOR

05/18/12

DESCRIPTION





## CALIFORNIA HIGH-SPEED TRAIN PROJECT

FRESNO TO BAKERSFIELD


BAKERSFIELD URBAN SUBSECTION
ALIGNMENT B2


BAKERSFIELD STATION - SOUTH ALTERNATIVE ROOM SCHEDULE


CONTRACT NO.	
HS	SR 06-0003
DRAWING NO.	
	A6501
SCALE	
SHEET NO.	


10 OF 13


No.	Name	Area	Required Area	FORMULA	TM 2.2.2. REFERENCE	Comments
	<u> </u>					
1	CONCOURSE FREE AREA 12	2860 SF	10969 SF	P15x30sf/person	6.2.3.2	
2	CONCOURSE PAID AREA 10	0117 SF	10969 SF	P15x30sqft	6.2.4.1	
3	CONCOURSE PAID AREA 10	0117 SF	10969 SF	P15x30sqft	6.2.4.1	
				P15	6.2.3.5	
5	PUBLIC RESTROOM 55	50 SF	366 SF	P15	6.2.3.5	
6		106 SF		Not specified in Technical Memorandum 2.2.2	6.2.3.6	
7	FUTURE CONCESSION 10	094 SF		Not specified in Technical Memorandum 2.2.2	6.2.3.6	
8		68 SF	160 SF	160 SF	6.2.6.1.3	
				270 SF	6.2.6.1.5	
		68 SF	141 SF	(((P60bx.15)/(1.5 x 60)) x 75) sqft	6.2.6.1.1	
		68 SF	160 SF	160 SF	6.2.6.2.6	
12	STATION CONTROL & COMMUNICATION ROOM 10	088 SF	1080 SF	1080 SF	6.2.6.2.3	
			520 SF	520 SF	6.2.6.2.4	
14	TELECOM. 5	31 SF			6.2.6.3	
		088 SF	1080 SF	1080 SF	6.2.6.2.10	
16	ELEC. 46	80 SF			6.2.6.3	
17	MECH. 46	80 SF			6.2.6.3	
18	PLUMBING 4	80 SF			6.2.6.3	
19	FIRE 44	80 SF			6.2.6.3	
20	SIGNALING 4	80 SF			6.2.6.3	
21	BATTERY 40	80 SF			6.2.6.3	
22	FACILITY MAINTENANCE OFFICE 74	41 SF	325 SF	325 SF	6.2.6.2.9	
23	JANITOR & STORAGE 5	72 SF	240 SF	240 SF x 3	6.2.6.2.16/17	
24	SECURITY OFFICE 38	82 SF	160 SF	160 SF	6.2.6.2.7	
25	POLICE OFFICE 4	01 SF	160 SF	160 SF	6.2.6.2.8	
26	TRANSIT AGENCY OFFICES 55	52 SF		Based on Demand	6.2.6.2.11	
27	STATION ADMIN OFFICE 74	41 SF		((65sqft x staff with own workspace) + (43sqft x staff with shared workspace))x1.25	6.2.6.2.1	
28	STAFF BREAK ROOM 44	20 SF	125 SF	(20sqft x .25 x max staff per shift x 1.25)	6.2.6.2.14	
29	TRAINING AND MEETING ROOM 55	21 SF	500 SF	(20sqft x max staff per shift x 1.25)	6.2.6.2.2	
30	STAFF LOCKER ROOMS AND RESTROOMS 50	00 SF		Local Codes	6.2.6.2.12/13	
31	STAFF LOCKER ROOMS AND RESTROOMS 50	00 SF		Local Codes	6.2.6.2.12/13	
32	TRASH 4:	70 SF			6.2.6.2.15	
32	LANDSCAPE 4	71 SF			6.2.6.2.18	
33	FUTURE CONCESSION 44	39 SF		Not specified in Technical Memorandum 2.2.2	6.2.3.6	
34	FUTURE CONCESSION 44	39 SF		Not specified in Technical Memorandum 2.2.2	6.2.3.6	
	·					

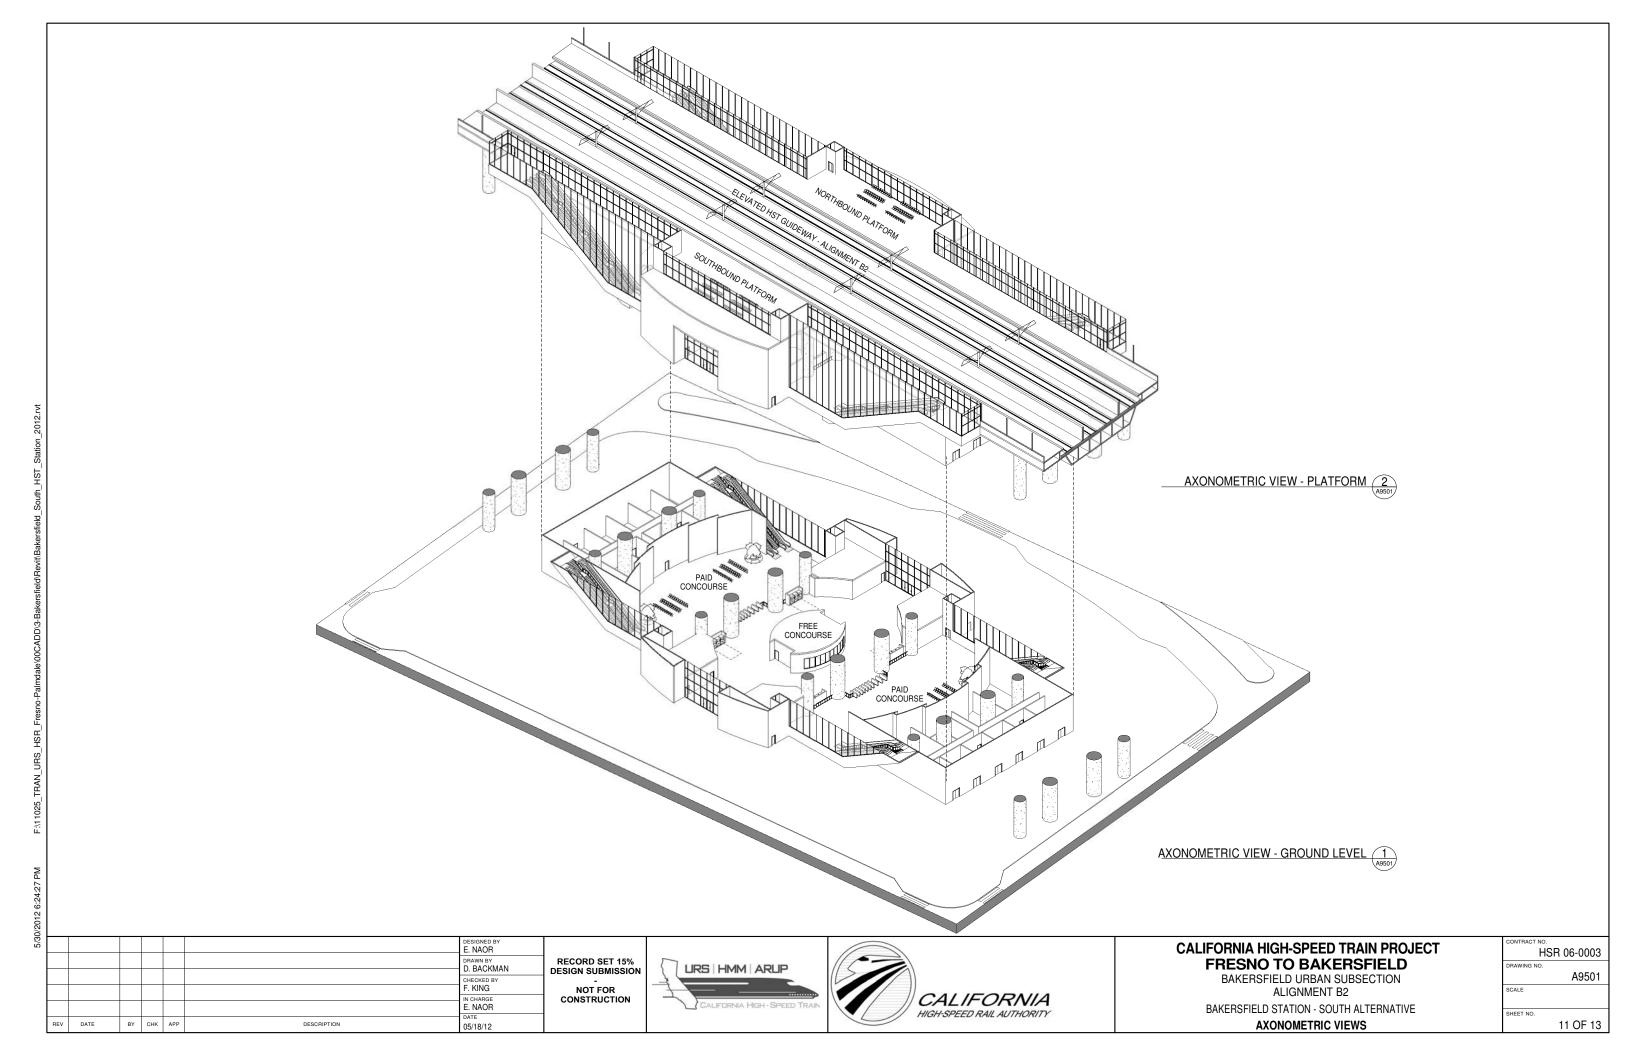


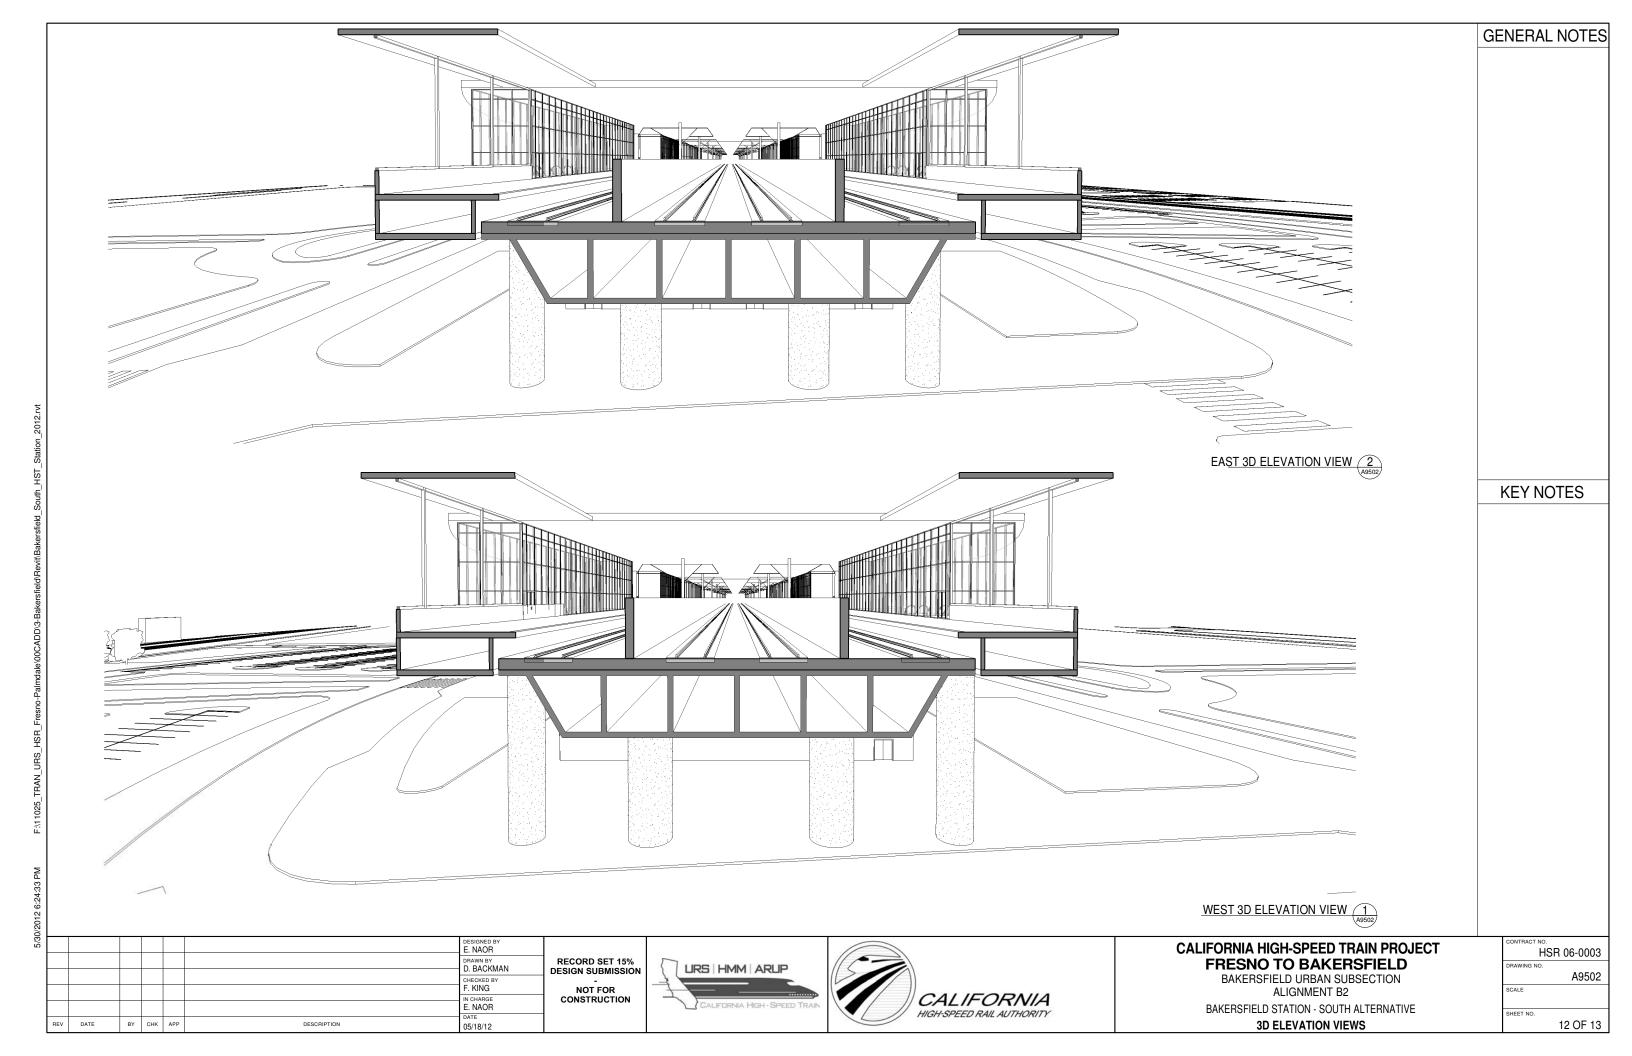


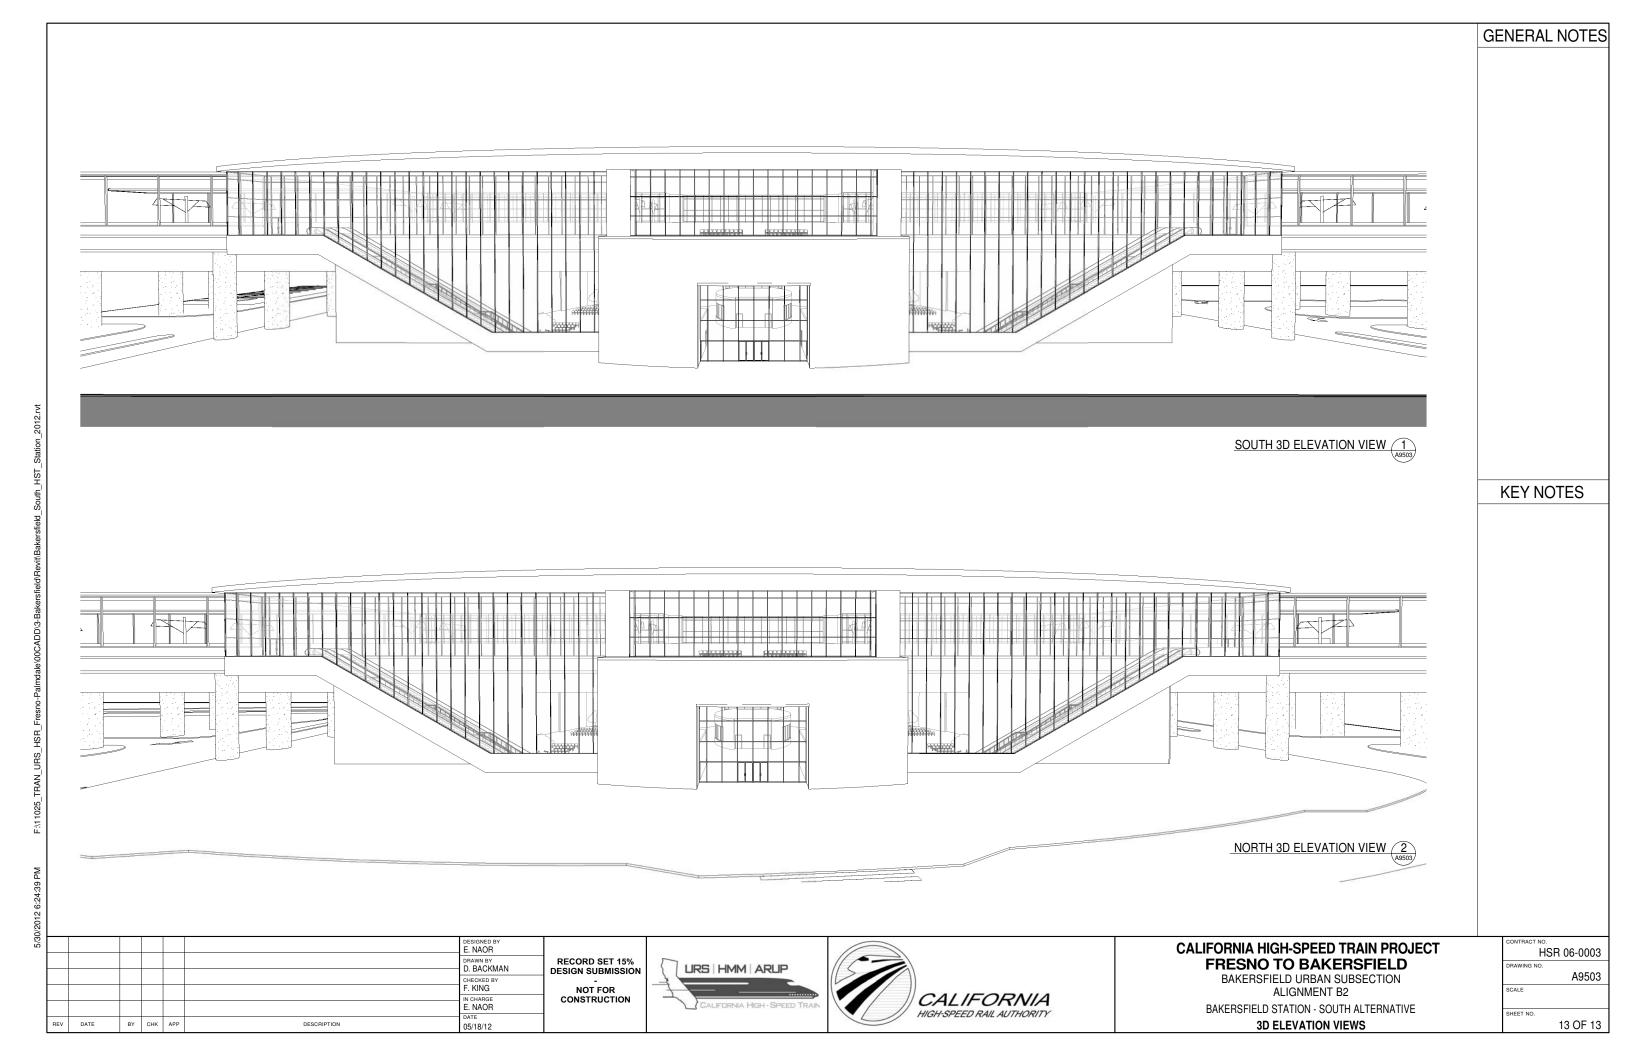


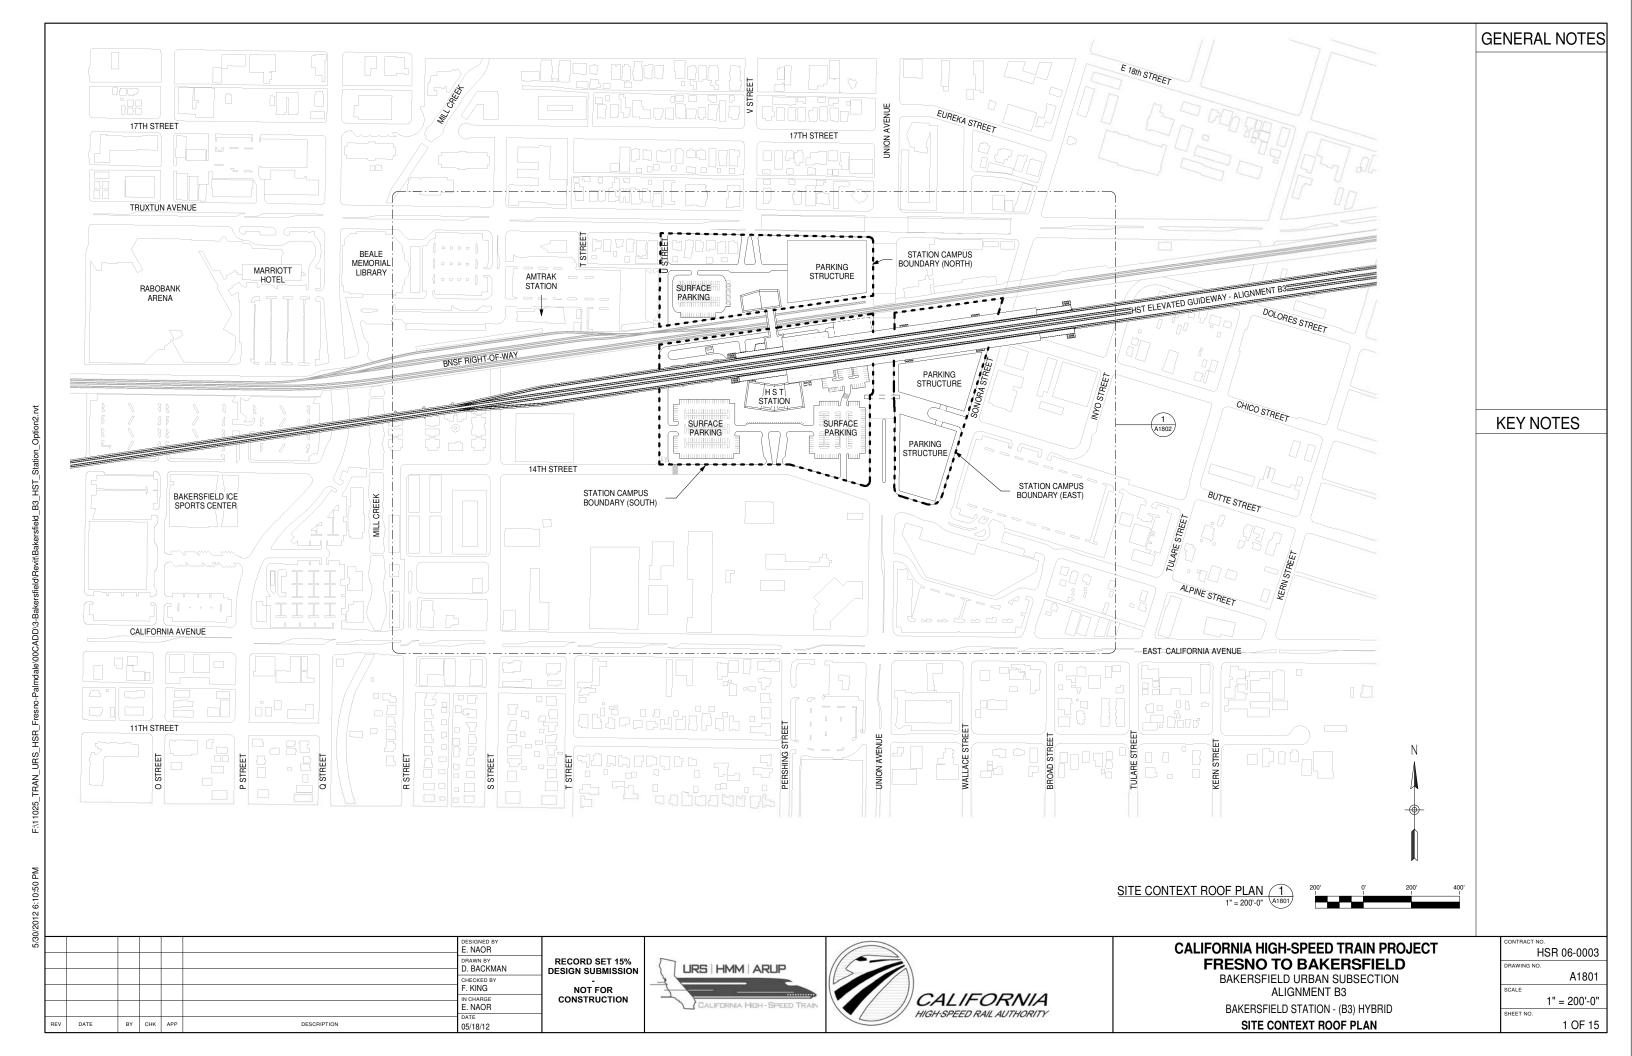


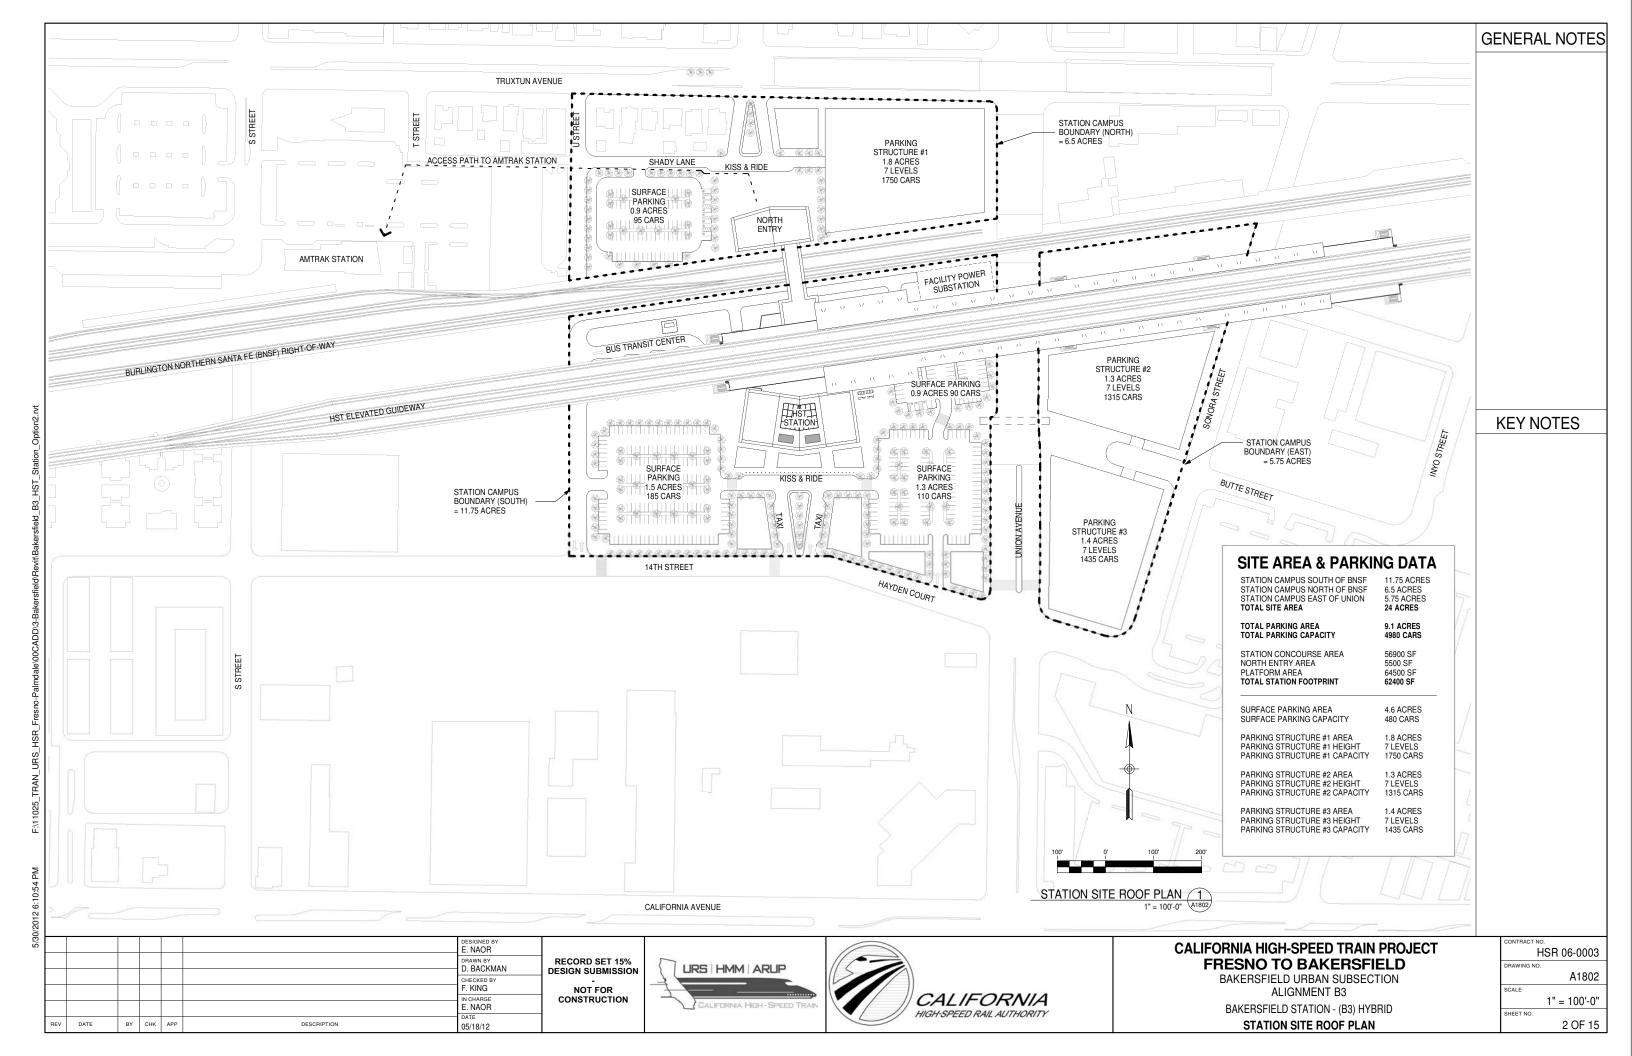


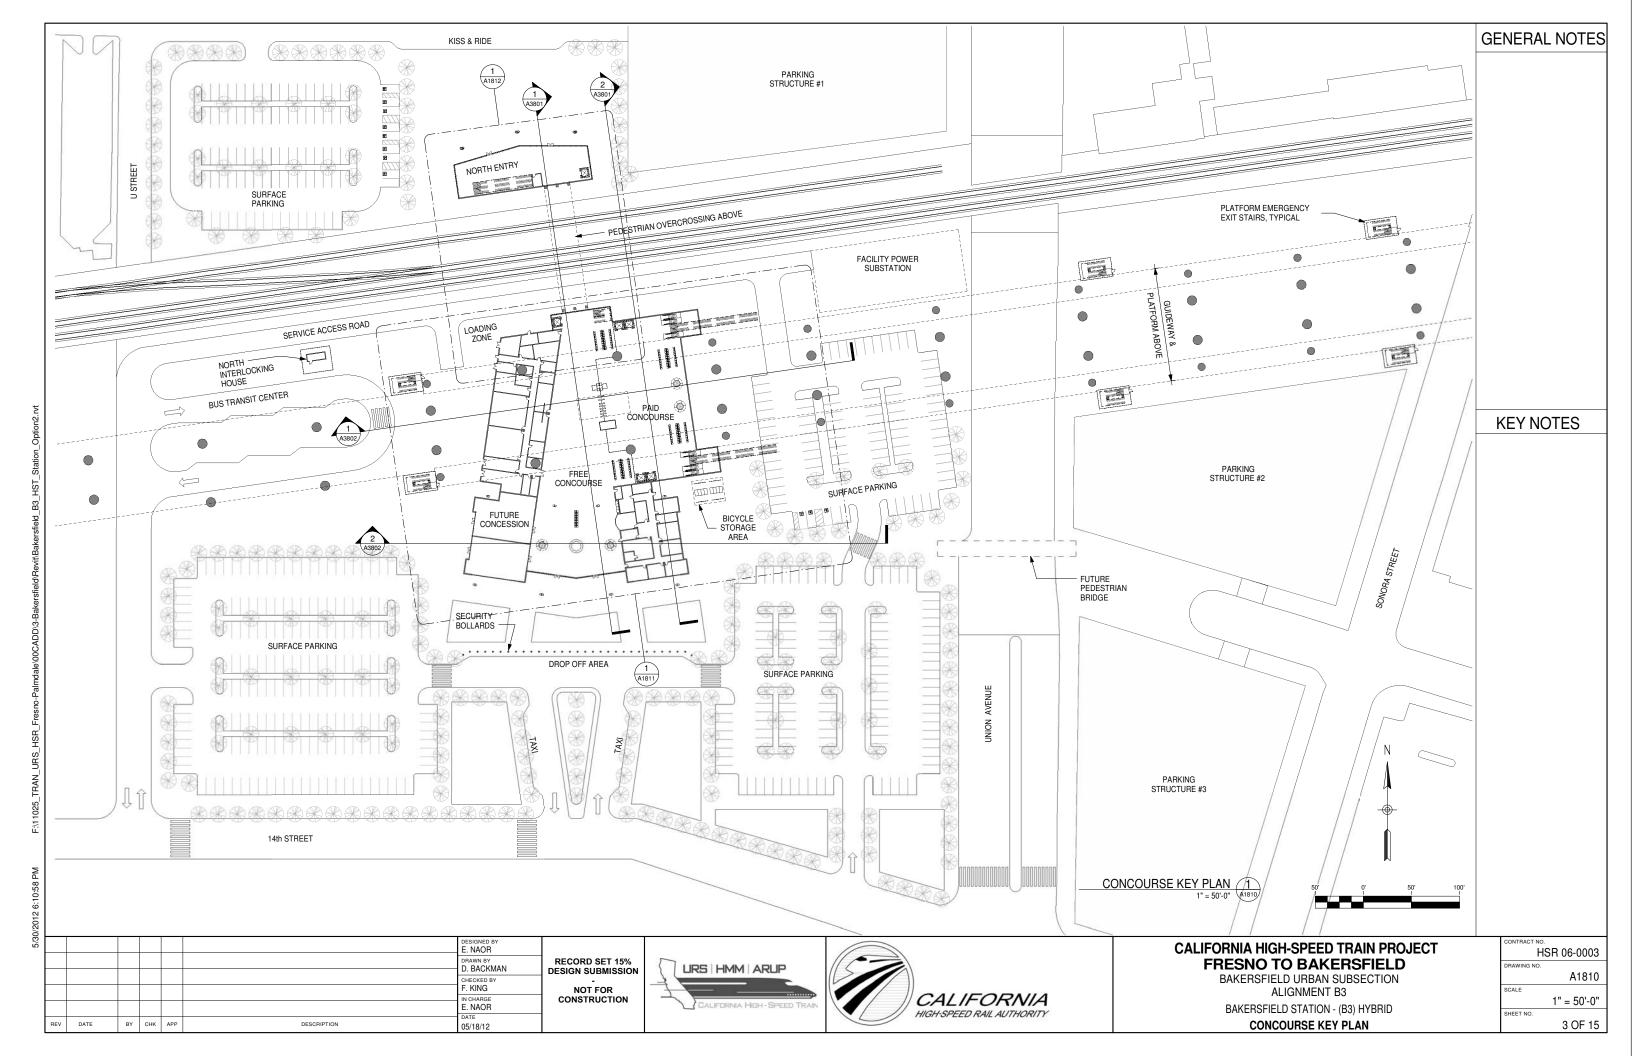


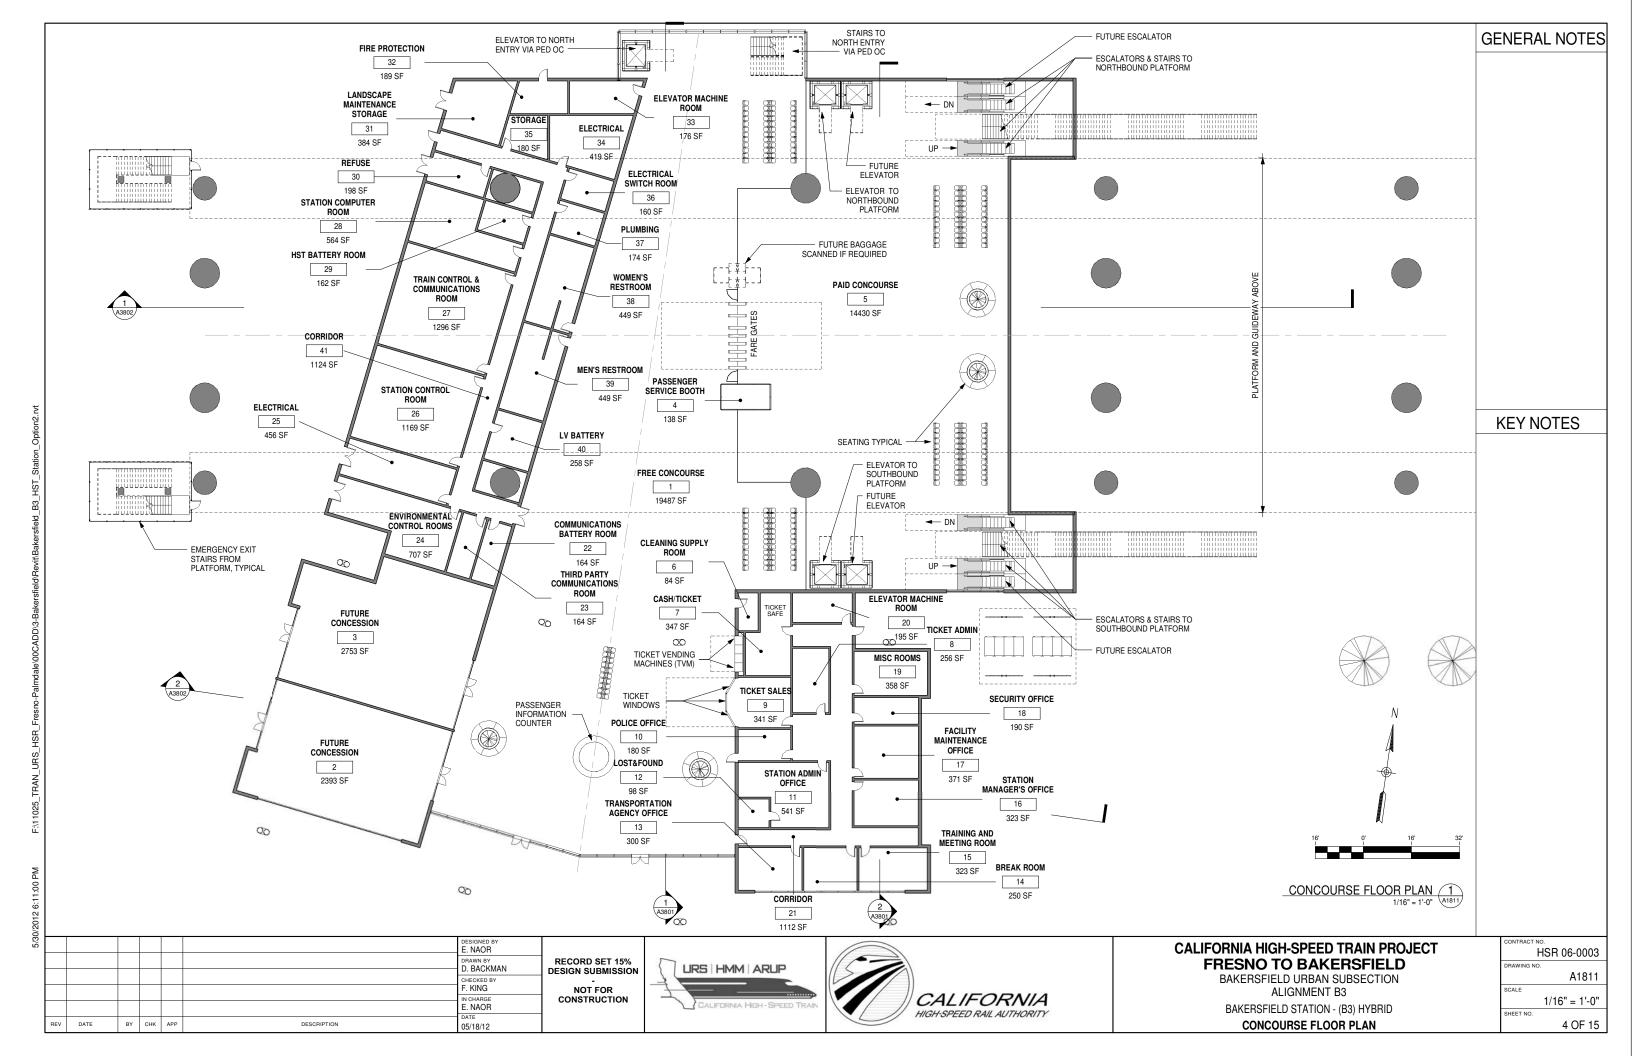

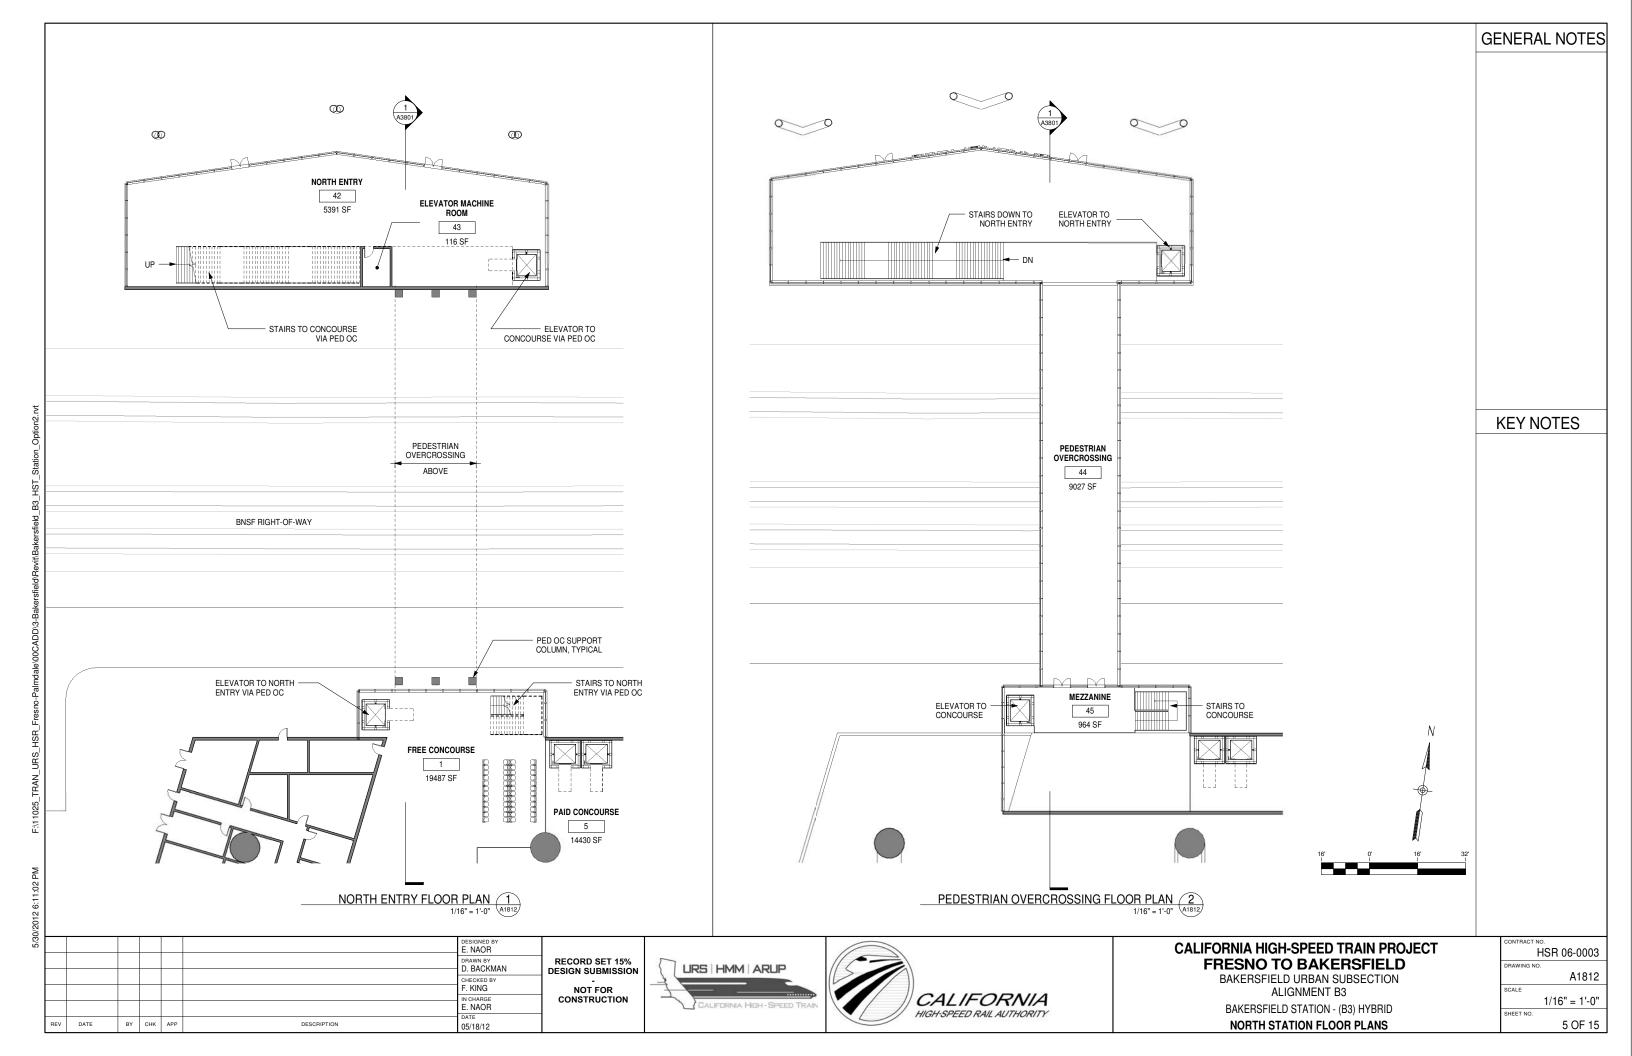

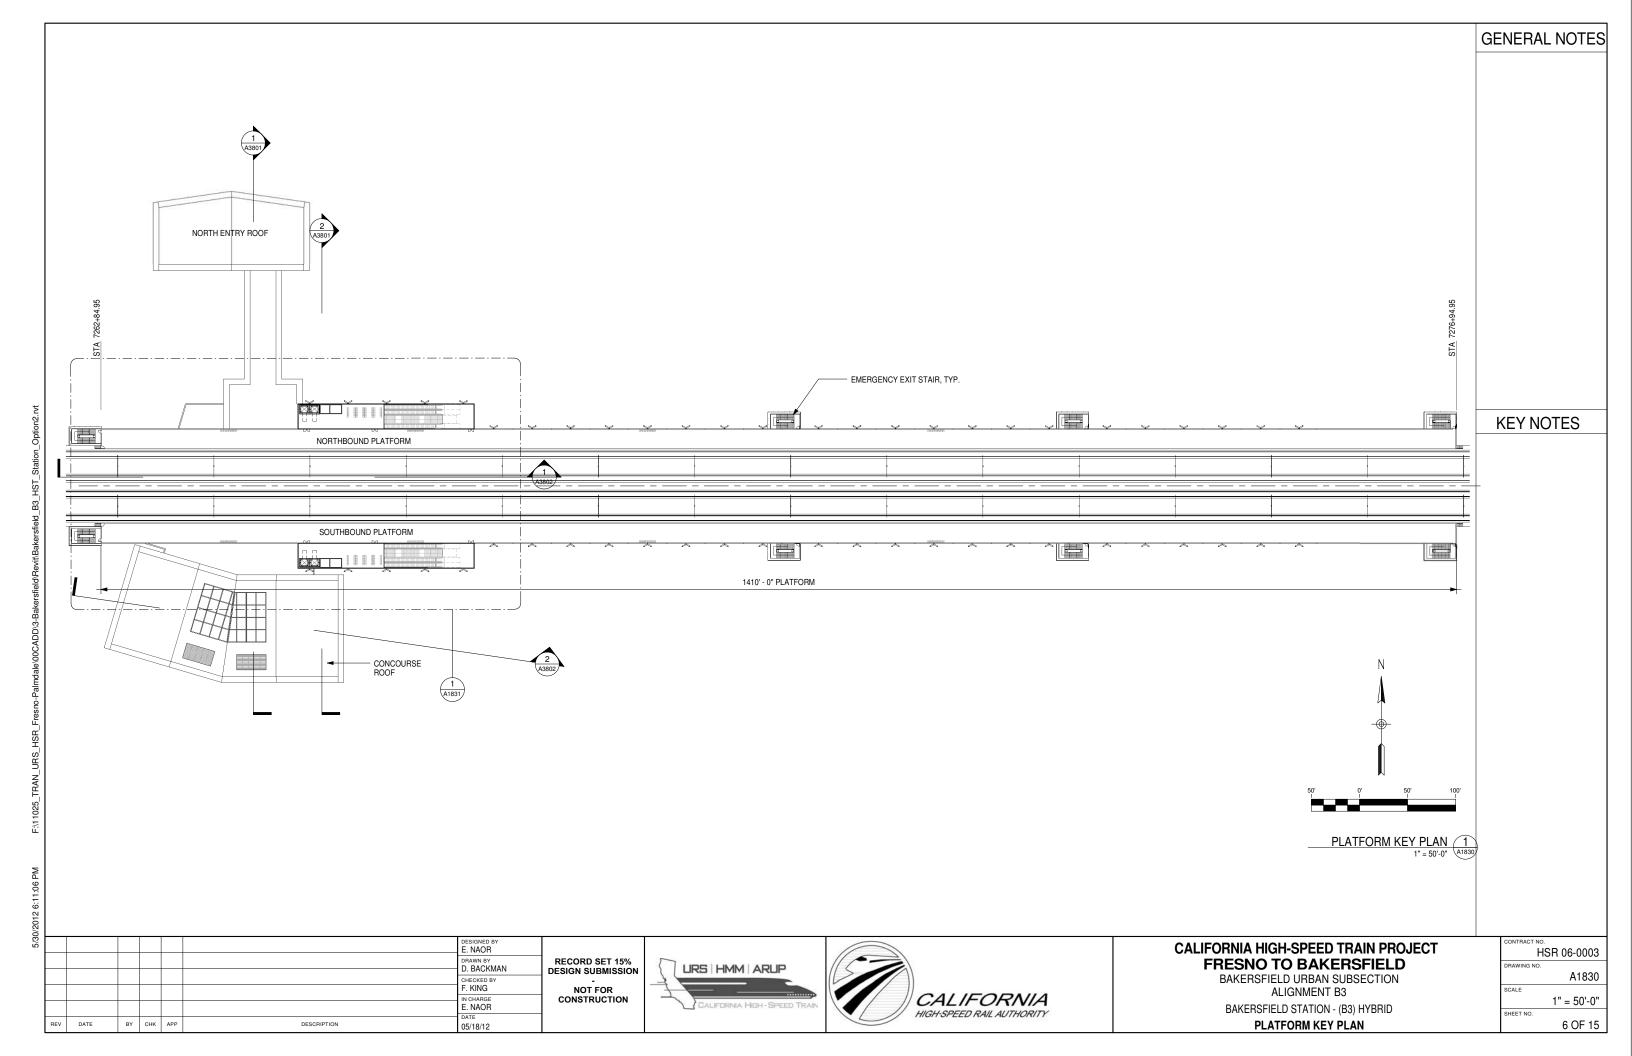

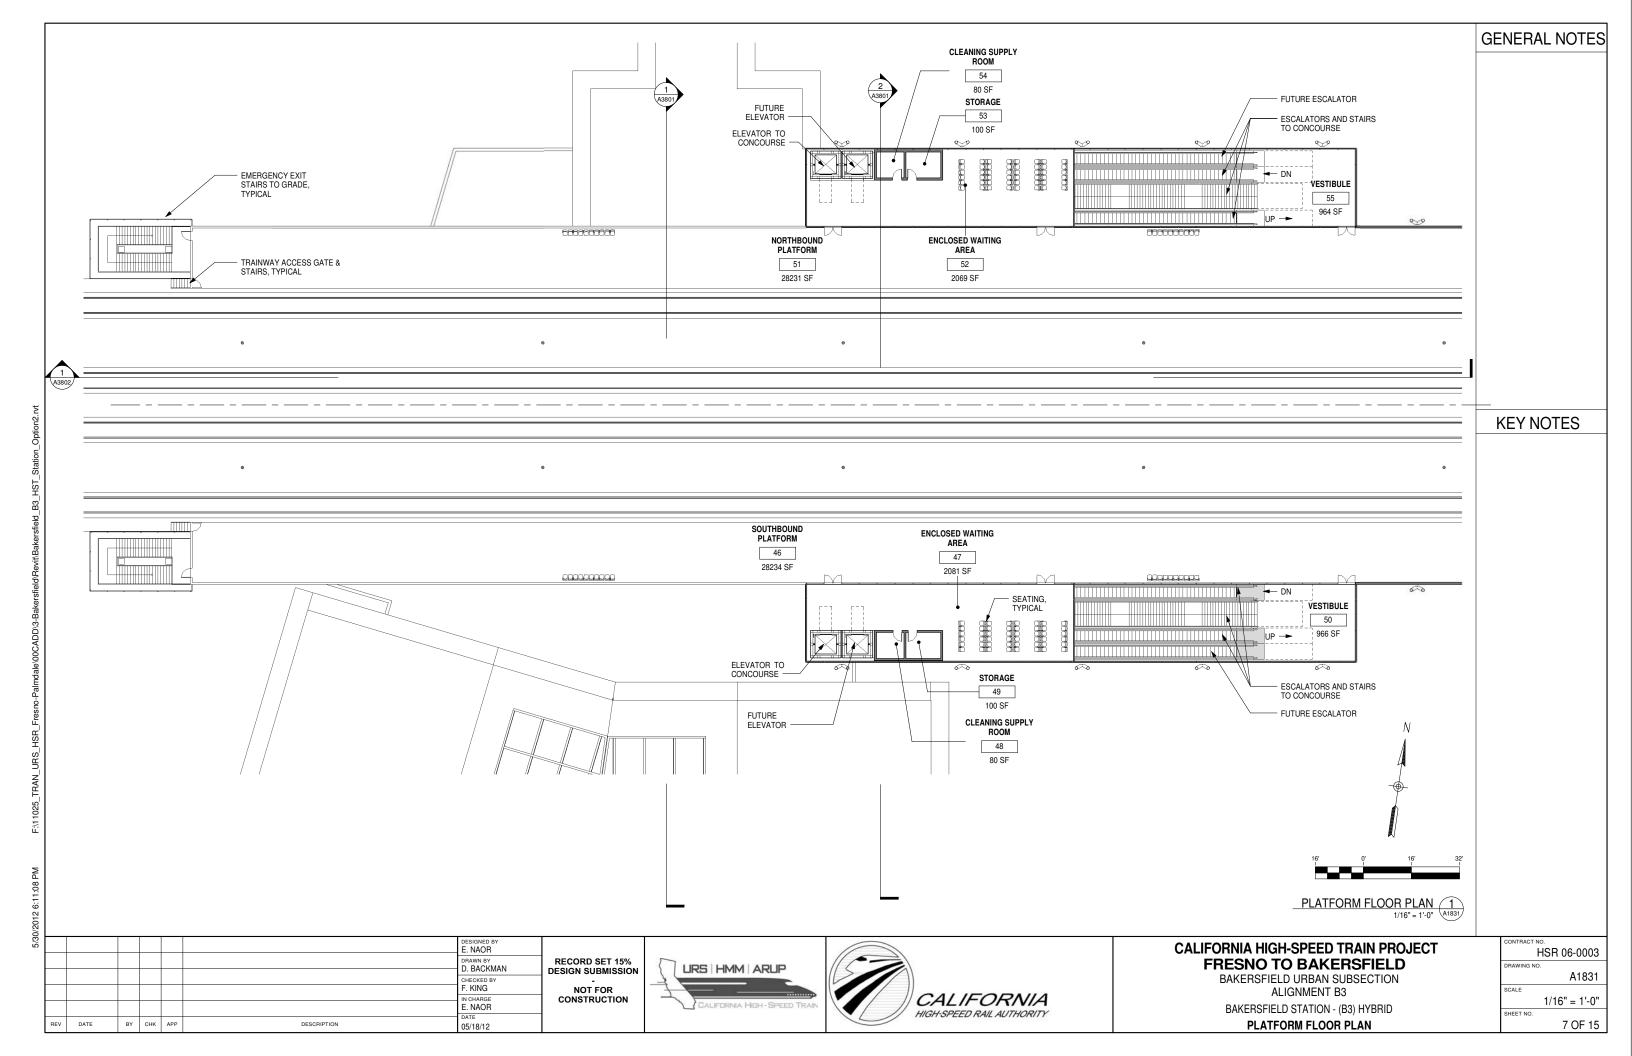

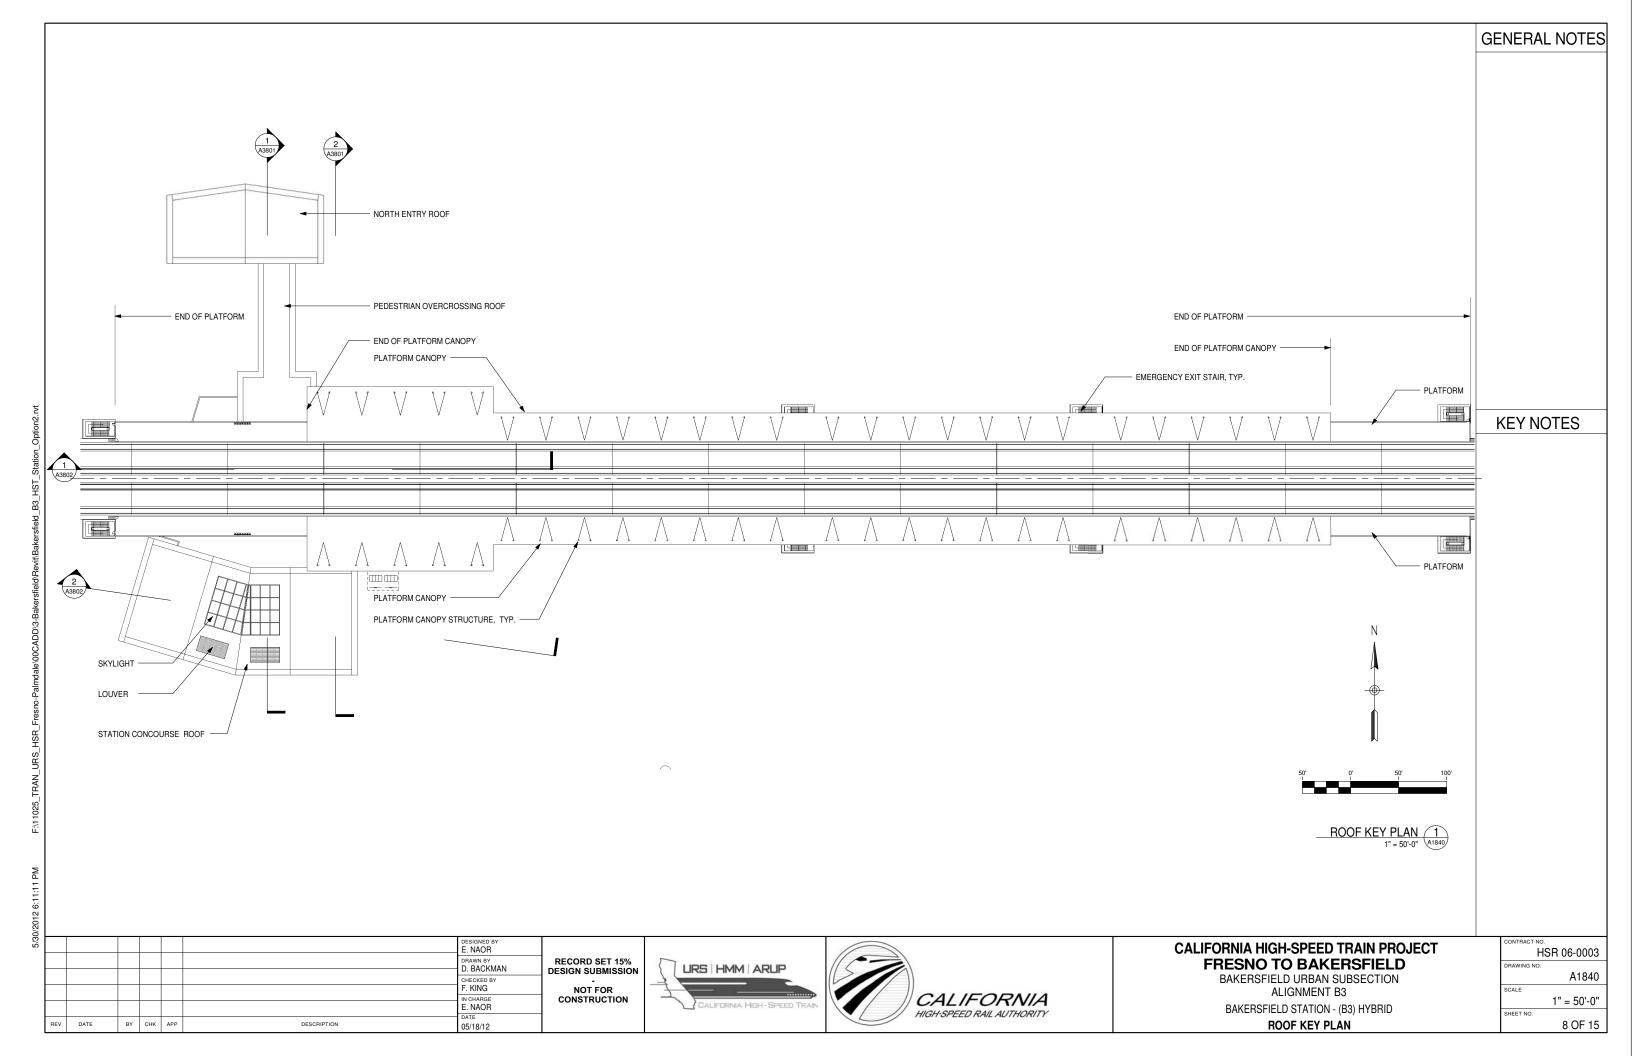

DESIGNED BY DRAWN BY
D. BACKMAN CHECKED BY F. KING IN CHARGE E. NAOR BY CHK APP DESCRIPTION 05/18/12

RECORD SET 15% DESIGN SUBMISSION NOT FOR CONSTRUCTION





#### **CALIFORNIA HIGH-SPEED TRAIN PROJECT FRESNO TO BAKERSFIELD**

BAKERSFIELD URBAN SUBSECTION ALIGNMENT B3 BAKERSFIELD STATION - (B3) HYBRID

**BUILDING SECTIONS** 

	A3801
SCALE	
	1" = 20'-0"
SHEET NO.	
	9 OF 15

HSR 06-0003



DESIGNED BY DRAWN BY
D. BACKMAN CHECKED BY F. KING IN CHARGE E. NAOR BY CHK APP DESCRIPTION 05/18/12

RECORD SET 15% DESIGN SUBMISSION NOT FOR CONSTRUCTION





## CALIFORNIA HIGH-SPEED TRAIN PROJECT FRESNO TO BAKERSFIELD

BAKERSFIELD URBAN SUBSECTION ALIGNMENT B3 BAKERSFIELD STATION - (B3) HYBRID

**BUILDING SECTIONS** 

A3802 1" = 20'-0" 10 OF 15

HSR 06-0003

PLATFORM CANOPY 70' - 0" PLATFORM 49' - 0" TOP OF RAIL 45' - 0" UNDERSIDE OF

GUIDEWAY


30' - 4"

LOWER ROOF

24' - 0" CONCOURSE

LEVEL
0"

LONGITUDINAL SECTION AT PAID CONCOURSE 1" = 20'-0" (A3802)

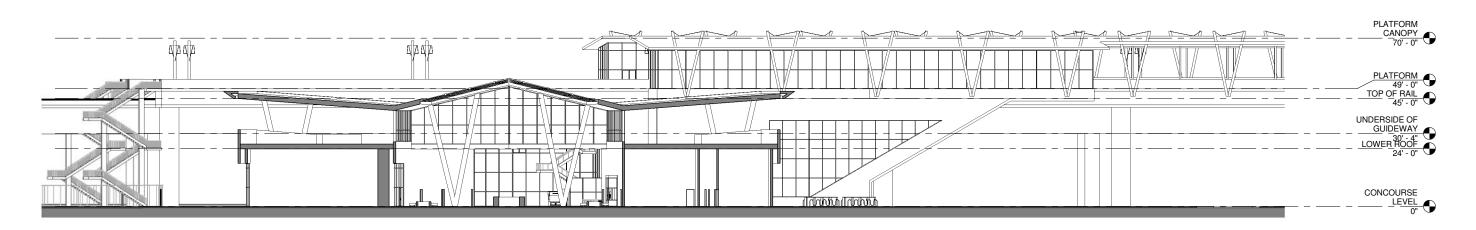

LONGITUDINAL SECTION AT FREE CONCOURSE 2
1" = 20'-0" (A3802)



L TERES COMPOUNDS	1,0,000	17.1.000		lana	
1 FREE CONCOURSE	19487 SF	Table 6-2 *		6.3.2	7,546 SF waiting area plus required circulation area
2 FUTURE CONCESSION	2393 SF	3000 SF Table 6-3		6.3.5	
3 FUTURE CONCESSION	2753 SF	3000 SF Table 6-3		6.3.5	
4 PASSENGER SERVICE BOOTH	138 SF	7.1.004		6.6.2.3	
5 PAID CONCOURSE	14430 SF	Table 6-2 *		6.3.3	6,286 SF waiting area plus required circulation area
6 CLEANING SUPPLY ROOM	84 SF	80 SF		6.6.4.2	
7 CASH/TICKET	347 SF	260 SF		6.6.3.8	
8 TICKET ADMIN	256 SF	160 SF		6.6.3.7	
9 TICKET SALES	341 SF	225 SF 75 SF per window		6.6.2.2	Three windows
10 POLICE OFFICE	180 SF	160 SF		6.6.2.6	
11 STATION ADMIN OFFICE	541 SF	500 SF 100 SF per assigned	staff	6.6.3.2	
12 LOST&FOUND	98 SF	80 SF		6.6.2.5	
13 TRANSPORTATION AGENCY OFFICE	300 SF			6.6.3.16	
14 BREAK ROOM	250 SF	200 SF		6.6.3.12	
15 TRAINING AND MEETING ROOM	323 SF	200 SF		6.6.3.4	
16 STATION MANAGER'S OFFICE	323 SF	270 SF		6.6.3.3	
17 FACILITY MAINTENANCE OFFICE	371 SF	330 SF		6.6.3.10	
18 SECURITY OFFICE	190 SF	160 SF		6.6.3.9	
19 MISC ROOMS	358 SF	300 SF		6.6.4.5	
20 ELEVATOR MACHINE ROOM	195 SF	80 SF		6.5.3.6	
21 CORRIDOR	1112 SF				
22 COMMUNICATIONS BATTERY ROOM	164 SF	160 SF		6.6.7.1	
23 THIRD PARTY COMMUNICATIONS ROOM	164 SF	160 SF		6.6.7.1	
24 ENVIRONMENTAL CONTROL ROOMS	707 SF	0 SF		6.6.6.1	
25 ELECTRICAL	456 SF	450 SF		6.6.6.2	
26 STATION CONTROL ROOM	1169 SF	1100 SF		6.6.3.5	
27 TRAIN CONTROL & COMMUNICATIONS ROOM	1296 SF	1280 SF		6.6.7.1	
28 STATION COMPUTER ROOM	564 SF	500 SF		6.6.3.6	
29 HST BATTERY ROOM	162 SF	160 SF		6.6.7.2	
30 REFUSE	198 SF	150 SF		6.6.4.1	
31 LANDSCAPE MAINTENANCE STORAGE	384 SF	Exterior access requ	red	6.6.4.4	
32 FIRE PROTECTION	189 SF			6.6.6.3	
33 ELEVATOR MACHINE ROOM	176 SF	80 SF		6.5.3.6	
34 ELECTRICAL	419 SF	450 SF		6.6.6.2	
35 STORAGE	180 SF	150 SF		6.6.4.3	
36 ELECTRICAL SWITCH ROOM	160 SF	160 SF		6.6.7.2	
37 PLUMBING	174 SF			6.6.6.4	
38 WOMEN'S RESTROOM	449 SF	Size per code		6.3.4	
39 MEN'S RESTROOM	449 SF	Size per code		6.3.4	
40 LV BATTERY	258 SF	200 SF		6.6.6.2	
41 CORRIDOR	1124 SF				
42 NORTH ENTRY	5391 SF	Table 6-2 *		6.3.2	
43 ELEVATOR MACHINE ROOM	116 SF	80 SF		6.5.3.6	
44 PEDESTRIAN OVERCROSSING	9027 SF	100 01		0.0.0.0	
45 MEZZANINE	964 SF				
46 SOUTHBOUND PLATFORM	28234 SF	25 SF min per board	ng passenger *	6.4.2	
47 ENCLOSED WAITING AREA	2081 SF	Table 6-2 *	a harranaa,	6.3.3.2	
48 CLEANING SUPPLY ROOM	80 SF	80 SF		6.6.4.2	
49 STORAGE	100 SF	100 SF		6.6.4.3	
50 VESTIBULE	966 SF	Table 6-2 *		6.5.1.4	
51 NORTHBOUND PLATFORM	28231 SF	25 SF min per board	ng passenger *	6.4.2	
52 ENCLOSED WAITING AREA	2069 SF	Table 6-2 *	g p	6.3.3.2	
53 STORAGE	100 SF	100 SF		6.6.4.3	-
54 CLEANING SUPPLY ROOM	80 SF	80 SF		6.6.4.2	
55 VESTIBULE	964 SF	Table 6-2 *		6.5.1.4	
UU VEOTIBULE	304 91	Table 6-2		0.5.1.4	

**FORMULA** 

TM 2.2.2. REFERENCE

\* STATION PUBLIC AREAS AND VERTICAL CIRCULATION ARE SIZED FOR PEAK PASSENGER FORCAST FOR FULL BUILD OUT (2035) AT 50% AIR FARES AS PROVIDED IN STATION AREA PARKING GUIDANCE TECHNICAL MEMORANDUM REV 4, DATED 6/20/2011

PEAK CUMULATIVE DAILY BOARDINGS OF 9,200 PASSENGERS

PEAK HOUR BOARDINGS (P60B) OF 1,380 PASSENGERS

COMMENTS

_								
05/0							DESIGNED BY E. NAOR	
							DRAWN BY D. BACKMAN	R
							CHECKED BY F. KING	
							IN CHARGE E. NAOR	] c
	REV	DATE	BY	СНК	APP	DESCRIPTION	05/18/12	

REQUIRED AREA

AREA

ROOM NAME

RECORD SET 15%
DESIGN SUBMISSION
NOT FOR
CONSTRUCTION





# CALIFORNIA HIGH-SPEED TRAIN PROJECT FRESNO TO BAKERSFIELD

BAKERSFIELD URBAN SUBSECTION ALIGNMENT B3

BAKERSFIELD STATION - (B3) HYBRID ROOM SCHEDULE

CONTRACT NO.
HSR 06-0003
DRAWING NO.
A6801
SCALE
SHEET NO. 11 OF 15

